Eden Street Riverside Tasmania 7250 Telephone: (03) 6323 9300 Facsimile: (03) 6323 9349

4. Other:



### PLANNING APPLICATION FORM

Section 57 & 58

OFFICE USE ONLY

Application Number
Assess No:
PID No:

PA2024217 A4794 9398423

Applicant Name:	BVZ Designs			
Postal Address:				
Contact Phone:	Home	Work	Mobile	
Email Address:				

# **Planning Application Lodgement Checklist**

The	follo	owing documents have been submitted to support the consideration of this application:	
1.	Α сι	rrent copy of the property title text, folio plan and schedule of easements	
2.	A co	ompleted application form including a detailed description of the proposal	
3.	A cc	omplete plan set:	
	a)	Floor plans	
	b)	<b>Elevations</b> (from all orientations/sides and showing natural ground level and finished surface level)	
	c)	Site Plan showing:	
	8	Orientation	
	•	All title boundaries	
	9	Location of buildings and structure (both existing and proposed)	
	•	Setbacks from all boundaries	
	•	Native vegetation to be removed	
	•	Onsite services, connections and drainage details (including sewer, water and stormwater)	
		Cut and/or Fill	
	•	Car parking and access details (including construction material of all trafficable areas)	
	٠	Fence details	
	•	Contours	

If submitting plans in over the counter please ensure they are A3.

All plans must be to scale.

### WEST TAMAR COUNCIL



Application Number: «Application Number»

	APPLICANT DETAILS	16年 里海 新 在1	
Applicant Name:	Bradley van Zetten		
Note: Full name(	of person(s) or company making the application o	and postal address for a	correspondence.
2000	LAND DETAILS		
Owner/Authority Name: (as per certificate of title)	ROSSITEN HOMES &	DEVELOPMEN	T PTY LTD
Location / Address:	FUTURE LOT S OFF UN	T7-176	PRESHWATER POWTRE
Title Reference:	183722/7		
Zone(s):	GEN RE)		
Existing Development/Use:	VACANT CANO		
Existing Developed Area:	Area 1-47 HA	1018 501	M
<b>一种,从</b> 被查到一定。	DEVELOPMENT APPLICATION	DETAILS	
Proposed Use:	Residential: Visitor Accommodation Description of Use:  RESIDENTIAC UNIT		cial:   Other:
Development Type:	Building work: ☑ Demolition: □  Description of development:	Subdivision:	Other: □
New or Additional Area:	Area V1, V2 - 137	. SOM	V3-155
Estimated construction cost proposed development:	f the \$ 750 K		
Building Materials:	Wall Type: BRICK/ (	Colo	our: Neutrals/ grays
bunuing waterials.	Roof Type: Colonbus	1) Colo	our: Neutrals/ grays

### **WEST TAMAR COUNCIL**



Application Number: «Application Number»

	SUBDIVISION	■N/A
		Subdivision creating additional lots ent with no additional lots created
Number of Lots (existing):	Number of I	Lots (proposed):
Description:		
If applying for a subdivision which		ee proposed names for the road(s), in order of
1.	preference:	
2.		
3.		
COMMERCIAL,	NDUSTRIAL OR OTHER NON-RESI	DENTIAL DEVELOPMENT/USE ON/A
	Monday / Friday:	То
Hours of Operation:	/ Saturday:	То
	Sunday:	То
Existing Car Parking:		
Proposed Car Parking:		
Number of Employees: (Existing)		
Number of Employees: (Proposed)		
Type of Machinery installed:		
Details of trade waste and method of disposal:		

### **WEST TAMAR COUNCIL**



Application Number: «Application Number»

<b>对于"拉斯拉斯斯</b>	APPLICANT DI	ECLARATION	
Owner:	As the owner of the land, I declare that the accurate representation of the proposal and Officers to conduct inspections as required f	d I consent to this application being submitt	a true and ed and for Council
	Name (print)	Signed	Date
Applicant: (if not the owner)	As the applicant, I declare that I have notifie the information contained in this application	ed the owner of my intention to make this a n is a true and accurate representation of th	pplication and that ne proposal,
	Bradley van Zetten	Brans	6/8/24
	Name (print)	Signed	Date
Please Note: If th	ne application involves Crown Land you will ne Minister, or a delegated officer of the G	eed to provide a letter of consent and this fo Crown with a copy of the delegation.	orm signed by the
Crown			
Consent	Name (ed.)		
(if required)	Name (print)	Signed	Date
General			
Manager (if required)	Name (print)	Signed	Date
(1) required)	Come (print)	Signed	Date
If the subje	ct site is accessed via a right of way, the owne	er of the ROW must also be notified of the a	application.
Right of V	Vay Owner:		
As the applicant, I	declare that I have notified the owner of the this application that w		ny intent to lodge
L	Name (print)	Signed	Date



### RECORDER OF TITLES



Issued Pursuant to the Land Titles Act 1980




Search Date: 01 Aug 2024 Search Time: 10:00 AM Volume Number: 183722 Revision Number: 01 Page 1 of 5



### RECORDER OF TITLES



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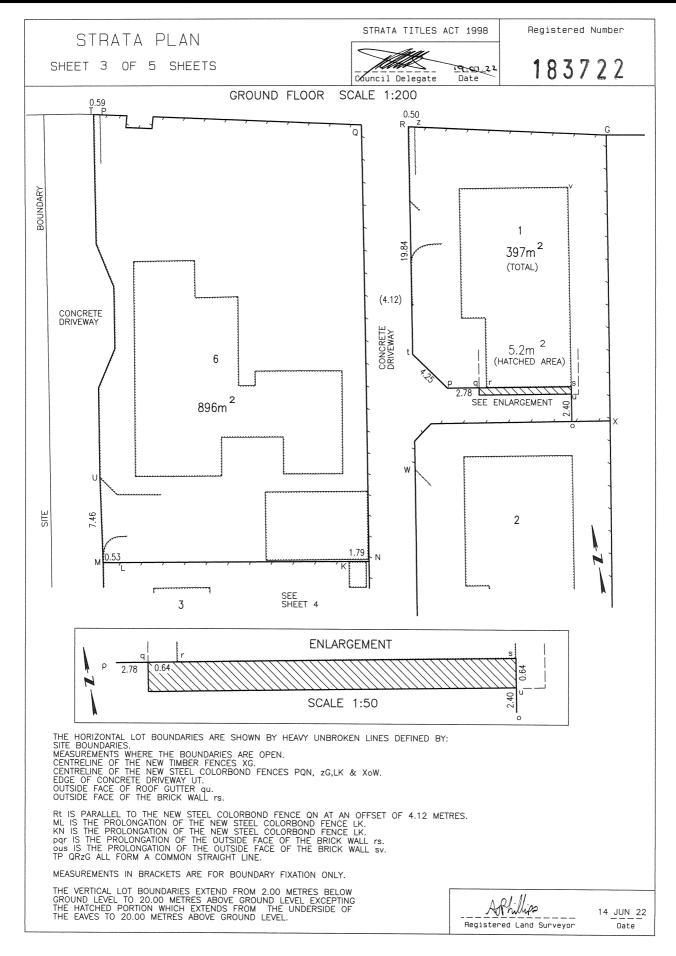
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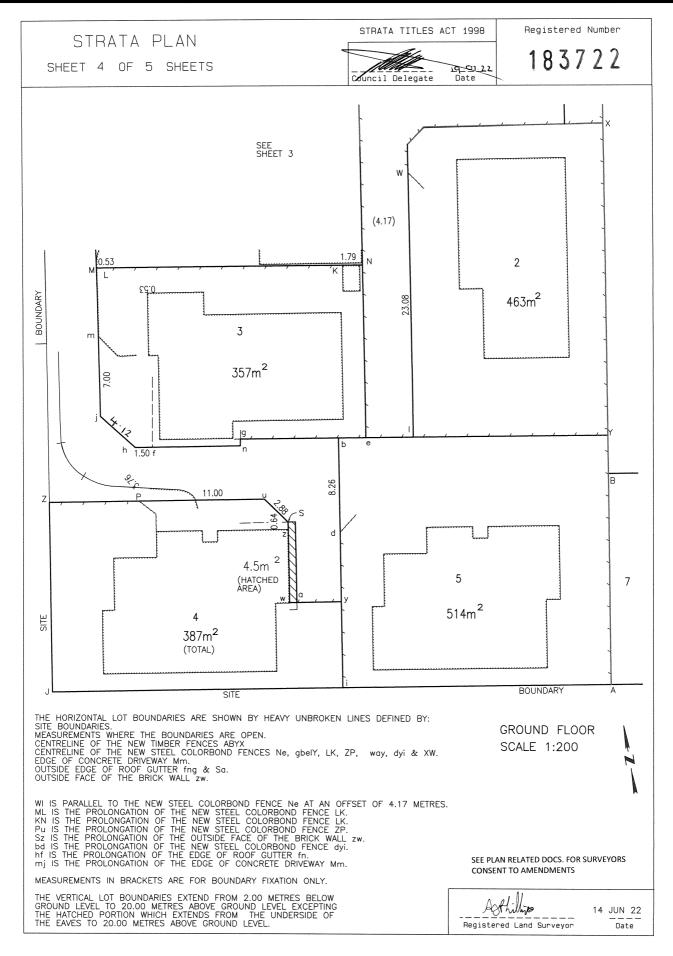
Search Date: 01 Aug 2024 Search Time: 10:00 AM Volume Number: 183722 Revision Number: 01 Page 3 of 5

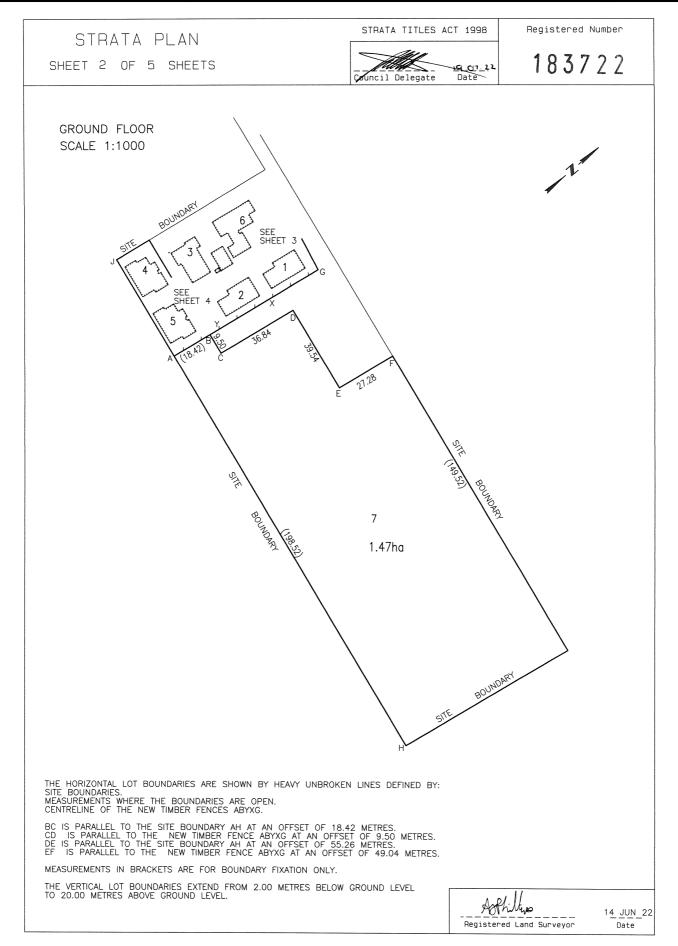

RECORDER OF TITLES



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### RECORDER OF TITLES





STRATA PLAN

SHEET 5 OF 5 SHEETS

STRATA TITLES ACT 1998

Registered Number

183722

NAME OF BODY CORPORATE: STRATA CORPORATION NO. 183722 ,176 FRESHWATER POINT ROAD, LEGANA

ADDRESS FOR THE SERVICE OF NOTICES: 176 FRESHWATER POINT ROAD, LEGANA, 7277

### SURVEYORS CERTIFICATE

### I, ANTHONY JOHN PHILLIPS of Legana

a surveyor registered under the Surveyors Act 2002 certify that the building or buildings erected on the site and drawn on sheet 1 of this plan are within the site boundaries of the folio stated on sheet 1 and any encroachment beyond those boundaries is properly authorised according to law.

Registered Land Surveyor

14 JUN 2022 Date

6026 86 Ref No.

### COUNCIL CERTIFICATE

(b) issued this certificate of approval in accordance with section 31 of the Strata Titles Act 1998

Council Delegate


19.07.22 Date 20 22116. Ref No.

### GENERAL UNIT ENTITLEMENTS

LOT UNIT ENTITLEMENT  1 10  2 10	
•	
2 10	
3 10	
4 10	
2 10 3 10 4 10 5 10 6 10 7 160	
6 10	
6 10 7 160	
TOTAL 220	

Search Date: 01 Aug 2024 Search Time: 10:00 AM Volume Number: 183722 Revision Number: 01 Page 5 of 5

### PRIORITY FINAL PLAN

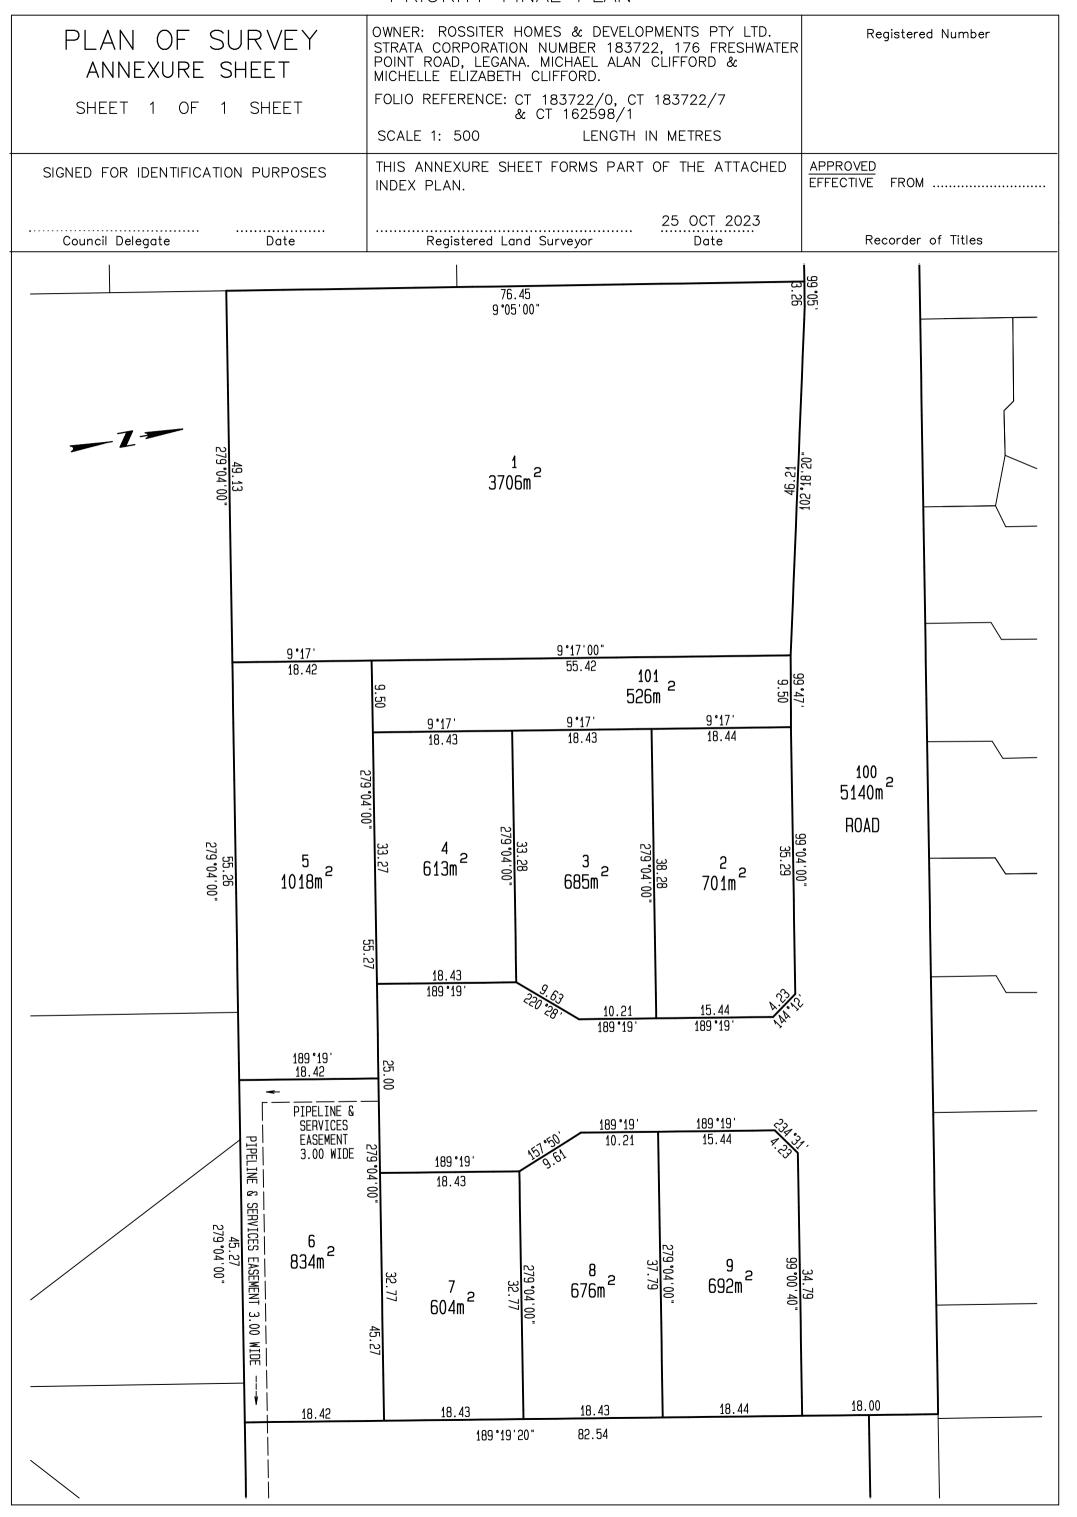

**LEGEND** PAGE 1# COVER PAGE PAGE 2# LOCALITY PLAN PAGE 3# SURVEY PLAN OF SUBDIVISION PAGE 4# EXISTING SITE SURVEY PLAN PAGE 5# SITE PLAN PAGE 6# LANDSCAPING PLAN PAGE 7# STRATA PLAN PAGE 8# SITE PLUMBING PLAN PAGE 9# CAR PARKING PLAN PAGE 10# SOIL AND WATER MANAGEMENT PLAN PAGE 11# UNIT 1 - FLOOR PLAN PAGE 12# UNIT 1 - FLOOR PLAN WITH DIMENSIONS PAGE 13# UNIT 1 - ROOF PLAN PAGE 14# UNIT 2 - FLOOR PLAN PAGE 15# UNIT 2 - FLOOR PLAN WITH DIMENSIONS PAGE 16# UNIT 2 - ROOF PLAN PAGE 17# UNIT 3 - FLOOR PLAN

PAGE 18# UNIT 3 - FLOOR PLAN WITH DIMENSIONS

COUNCIL — WEST TAMAR COUNCIL ZONE — GENERAL RESIDENTIAL CODE — BUSHFIRE PRONE AREA LANDSLIDE BAND — NIL

PAGE 19# UNIT 3 - ROOF PLAN

TITLE REF. = 188090/5

PAGE 20# ELEVATIONS

# PROPOSED UNIT DEVELOPMENT FOR BM PROPERTY DEVELOPMENT PTY LTD AT LOT 5 IMOGEN COURT OFF UNIT 7 - 176 FRESHWATER POINT ROAD LEGANA 7277

ALPINE AREA - N/A LESS THAN 900m AHD

OTHER HAZARDS - N/A

ALL DIMENSIONS SHOWN ARE TO OUTSIDE OF BRICKWORK CLADDING OR TIMBER FRAMING ON CLAD HOUSES UNLESS NOTED OTHERWISE

CONFIRM ALL DIMENSIONS AND SERVICES ON SITE
PRIOR TO COMMENCEMENT OF WORKS

IF IN ANY DOUBT ABOUT BEARING AND BOUNDARIES
THEN THESE MUST BE CONFIRMED ONSITE BY A
SURVEYOR PRIOR TO SETOUT

ENSURE DRAWINGS USED ONSITE ARE STAMPED 'APPROVED' PLANS BY BUILDING SURVEYOR AND PERMIT AUTHORITY

H4D9 CONDENSATION MANAGEMENT TO BE COMPLIANT WITH NCC PART 10.8 CONDENSATION MANAGEMENT.

(1)REFER TO THE GUIDANCE IN THE "CONDENSATION IN BUILDINGS TASMANIAN DESIGNERS' GUIDE" — CURRENT VERSION AVAILABLE AT WWW.CBOS.TAS.GOV.AU. THIS GUIDE MUST BE READ IN CONJUNCTION WITH THE NCC.

IF ANY DISCREPANCIES, APPARENT ERROR, ANOMALY OR AMBIGUITY WITHIN THE DOCUMENTATION IS FOUND. THE DESIGNER IS TO BE CONTACTED PRIOR TO ANY MORE CONSTRUCTION CONTINUING.

ENSURE THAT DRAWINGS ARE NOT SCALED AND THAT THE NOTED DIMENSIONS ARE USED FOR ACCURACY. IF IN ANY DOUBT CONTACT DESIGNER

REVISION NUMBER	DATE
REVISION 1	12 / 05 / 2024
REVISION 2	01 / 08 / 2024
REVISION 3	03 / 08 / 2024
REVISION 4	05 / 08 / 2024
REVISION 5	10 / 07 / 2025
REVISION 6	15 / 07 / 2025


C BRADLEY VAN ZETTEN 2024


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# BRADLEY VAN ZETTEN

4 EDEN HILLS DRIVE RIVERSIDE 7250 P. 0407 272 381 E. BVZDESIGNS@GMAIL.COM LICENCE NUMBER 957699796



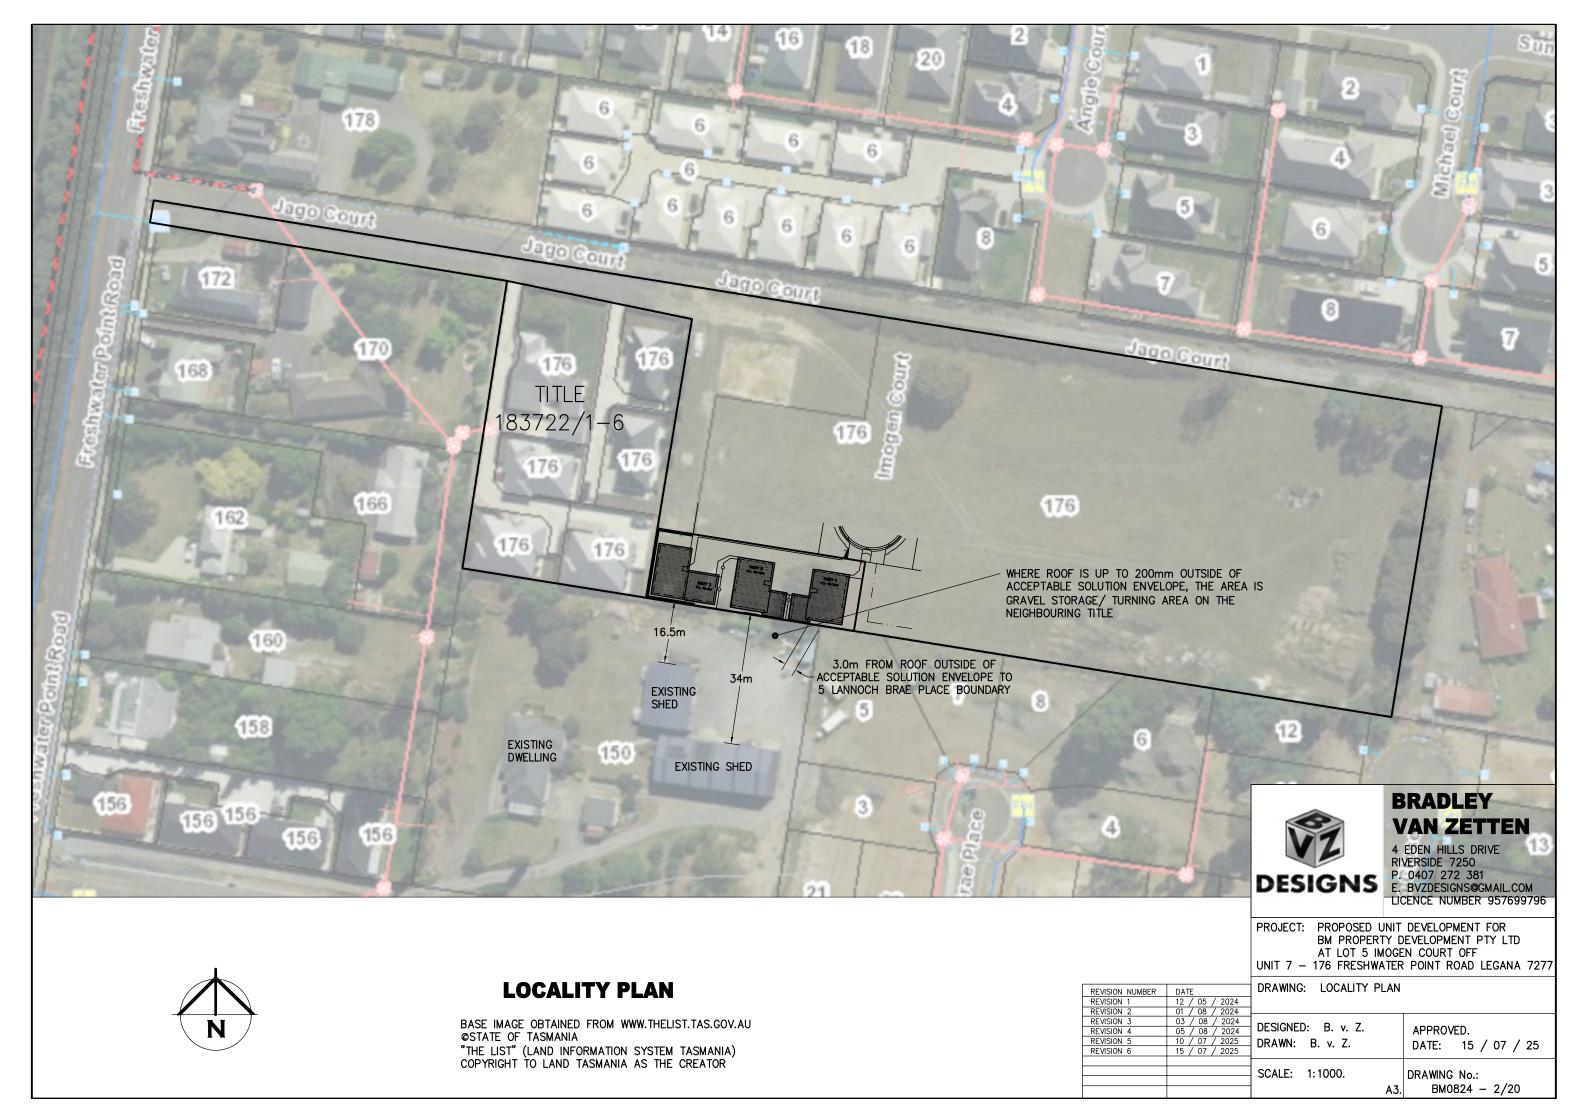

### **SURVEY PLAN OF SUBDIVISION**

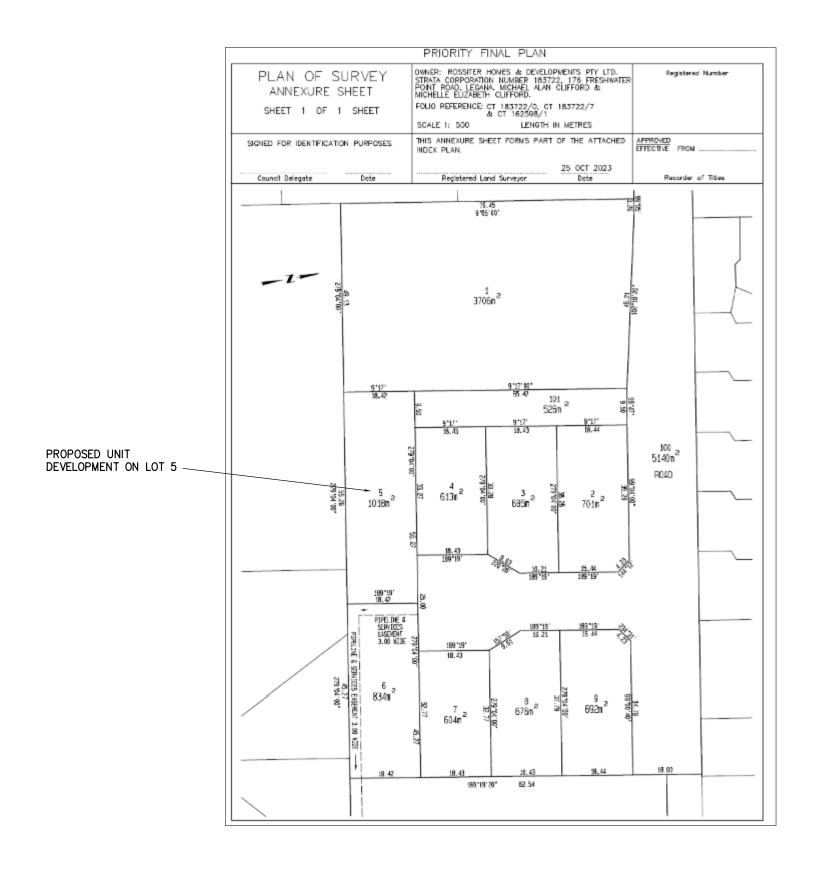

# BRADLEY VAN ZETTEN

DESIGNS


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RIVERSIDE 7250
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LICENCE NUMBER 957699796


PROJECT: PROPOSED UNIT DEVELOPMENT FOR
BM PROPERTY DEVELOPMENT PTY LTD
AT LOT 5 IMOGEN COURT OFF
UNIT 7 - 176 FRESHWATER POINT ROAD LEGANA 7277

REVISION NUMBER	DATE	DRAWING: SURVEY PLAN OF	SUBDIVISION
REVISION 1	12 / 05 / 2024		
REVISION 2	01 / 08 / 2024		
REVISION 3	03 / 08 / 2024	DECICNED. D 7	
REVISION 4	05 / 08 / 2024	DESIGNED: B. v. Z.	APPROVED.
REVISION 5	10 / 07 / 2025	DRAWN: B. v. Z.	DATE: 15 / 07 / 25
REVISION 6	15 / 07 / 2025	D. V. 2.	DAIL. 13 / 07 / 23
		SCALE: 1:1000.	DRAWING No.:
		A3.	BM0824 - 3/20

(C) BRADLEY VAN ZETTEN 2024

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SEALED DRIVEWAY TO FALL TO PITS. ASPHALT OR CONCRETE GRADE TRANSITION OF 2.0m IN LENGTH TO BE PROVIDED AT GRADE CHANGES UP TO 18%. TRANSITION GRADE TO BE HALF THE SUM OF THE TWO ADJACENT GRADES.

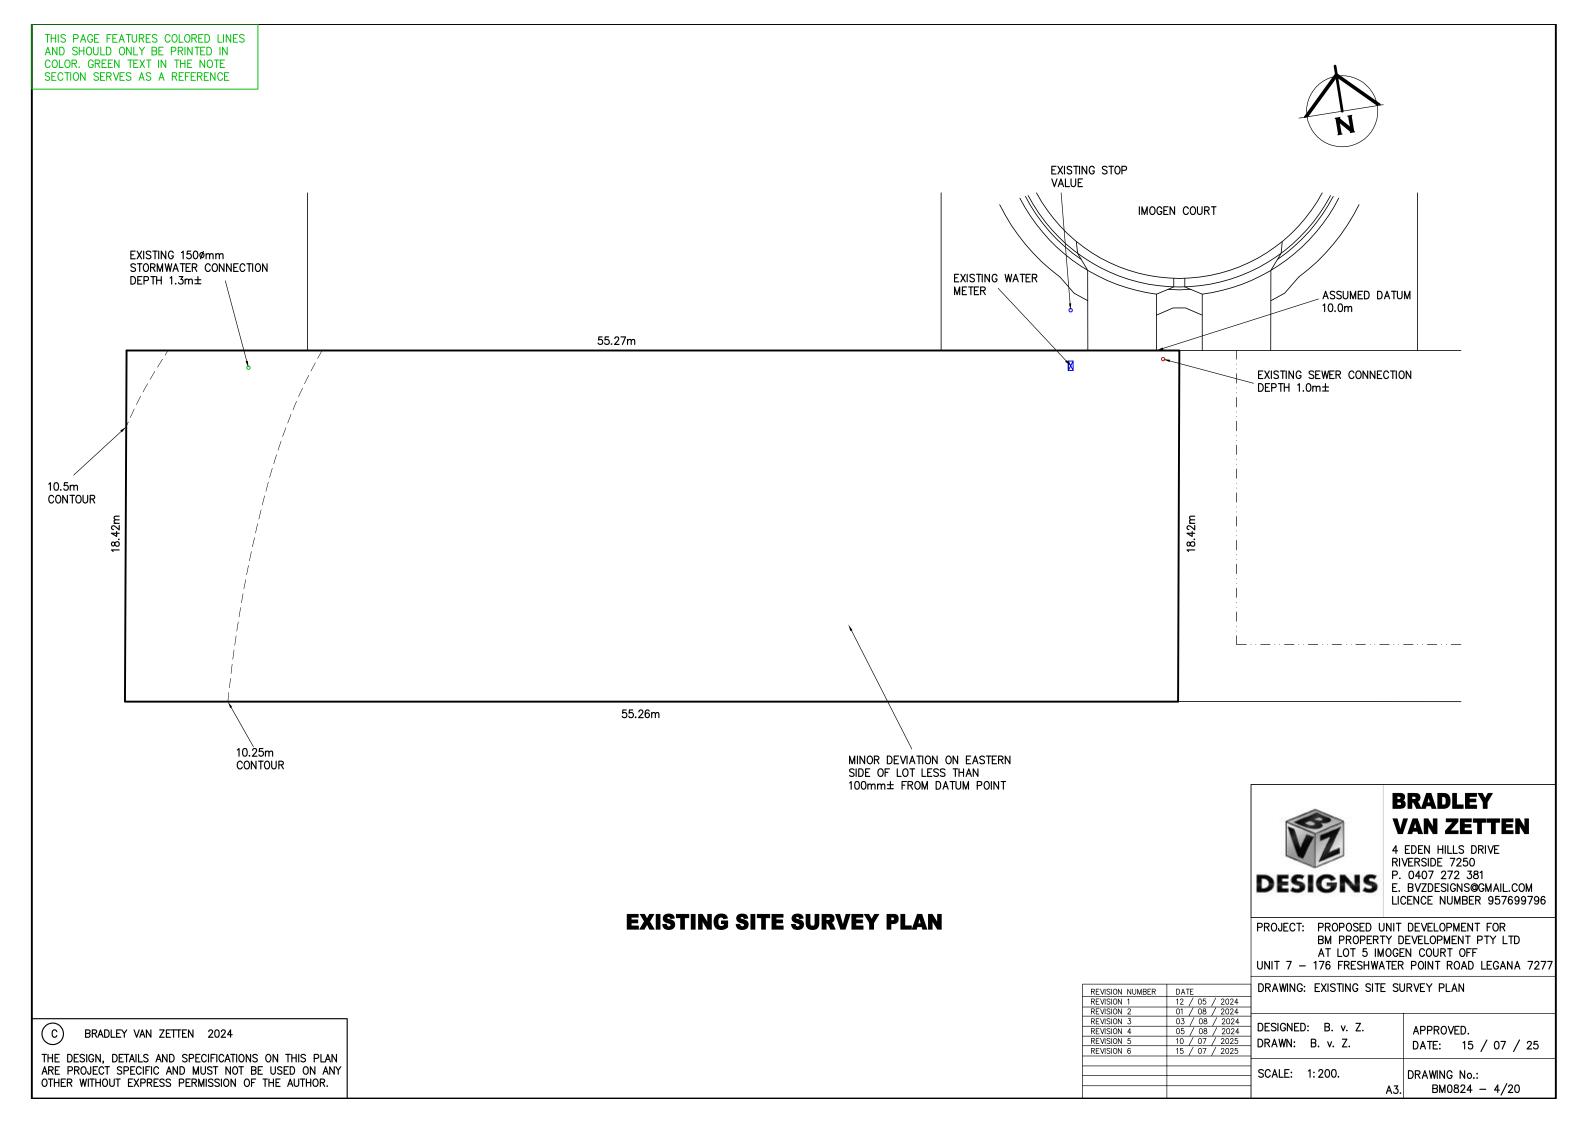

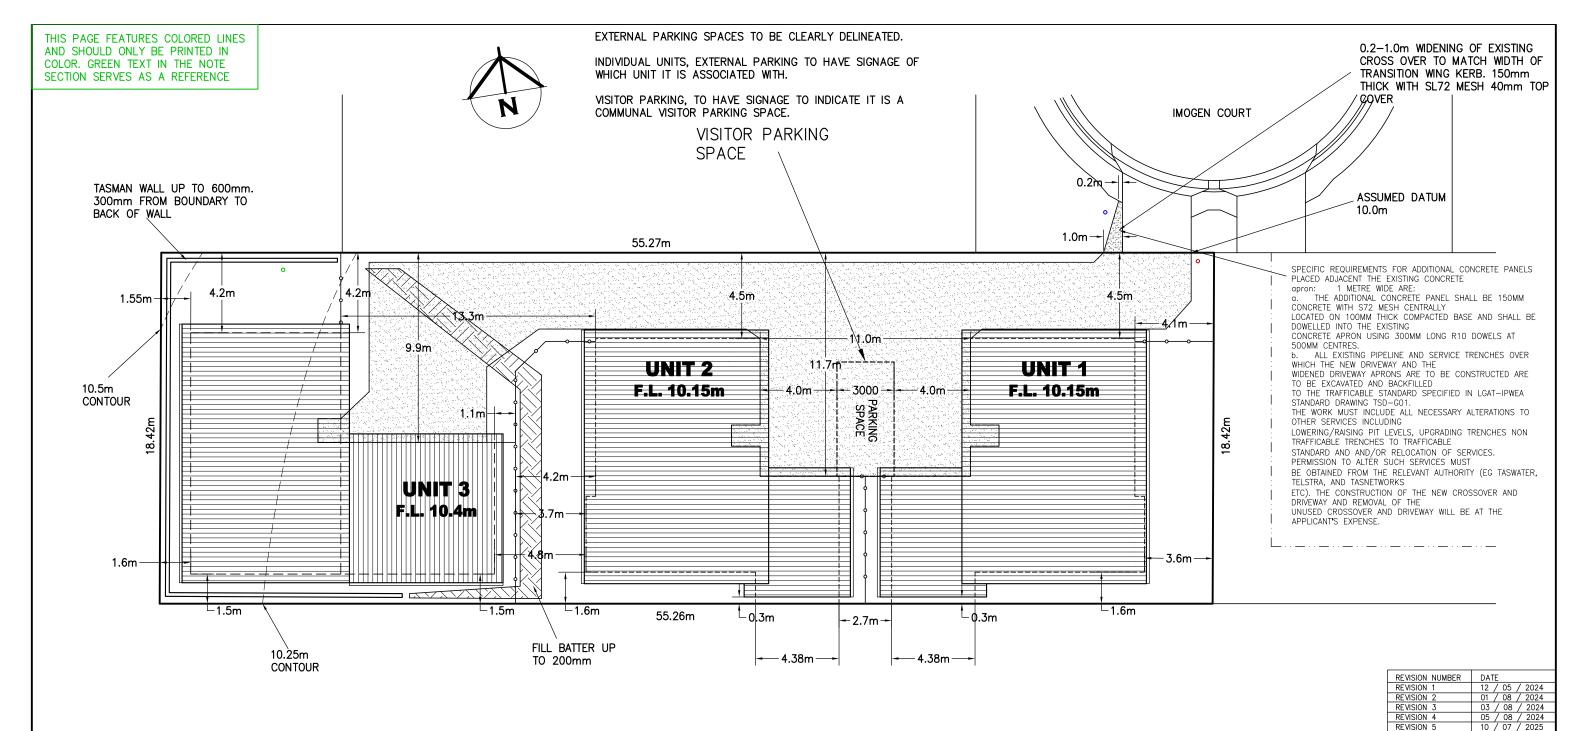
CUT/FILL BATTER MAX GRADE OF 1:10 IN PRIVATE OPEN SPACE 1:10 DRIVEWAY TURNING AREA 1:4 DRIVEWAY NON-TURNING AREA

SITE ARE	A TABLE	
	SQUARE METER	PERCENTAGE OF LOT
SITE AREA	1018	
BUILDING AREA EXCLUDING EAVES UP TO 0.6m WIDE (AS PER PLANNING SCHEME)	420	41.3
SEALED GROUND AREA (INCLUDING UNDER EAVES, EXCLUDING AREA INCLUDED IN CELL ABOVE)	355	34.9
AREA FREE FROM IMPERVIOUS SURFACES	243	23.9

### **SITE PLAN**

UN-RETAINED BULK EARTHWORKS - SITE

**CUT AND FILL PART 3.2.1** 

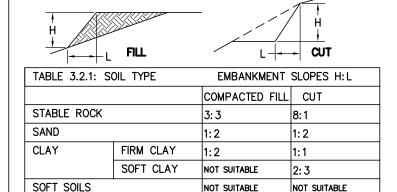

EMBANKMENTS THAT ARE TO BE LEFT EXPOSED AT THE END OF THE CONSTRUCTION WORKS MUST BE STABILISED BY VEGETATION OR SIMILAR TO PREVENT SOIL EROSION

(1)A SITE CUT USING AN UN-RETAINED EMBANKMENT MUST BE--(A)WITHIN THE ALLOTMENT; AND

(B)NOT WITHIN THE ZONE OF INFLUENCE OF ANY EXISTING STRUCTURE ON THE PROPERTY, OR THE ALLOTMENT BOUNDARY AS DEFINED IN TABLE 3.2.1 AND FIGURE

(C)NOT DEEPER THAN 2 M FROM THE NATURAL GROUND LEVEL AT ANY POINT.

(2) FILL, USING AN UN-RETAINED EMBANKMENT MUST--

(A)BE PLACED WITHIN THE ALLOTMENT; AND

(B)BE PLACED AT A GRADIENT WHICH COMPLIES WITH TABLE 3.2.1 AND FIGURE 3.2.1B;

(C)BE PLACED AND MECHANICALLY COMPACTED IN LAYERS NOT MORE THAN 150 MM; AND

(D)BE NOT MORE THAN 2 M IN HEIGHT FROM THE NATURAL GROUND LEVEL AT ANY

(E)WHERE USED TO SUPPORT FOOTINGS OR SLABS, BE PLACED AND COMPACTED IN ACCORDANCE WITH PART 4.2; AND (F)HAVE SURFACE WATER DIVERTED AWAY FROM ANY EXISTING STRUCTURE ON THE PROPERTY OR ADJOINING ALLOTMENT IN ACCORDANCE WITH 3.3.3.

### **BRADLEY VAN ZETTEN**

4 EDEN HILLS DRIVE RIVERSIDE 7250 P. 0407 272 381 DESIGNS E. BYZDESIGNS@GMAIL.COM LICENCE NUMBER 957699796

PROJECT: PROPOSED UNIT DEVELOPMENT FOR BM PROPERTY DEVELOPMENT PTY LTD AT LOT 5 IMOGEN COURT OFF

UNIT 7 - 176 FRESHWATER POINT ROAD LEGANA 7277

DRAWING: SITE PLAN	
DESIGNED: B. v. Z. DRA <b>W</b> N: B. v. Z.	APPROVED. DATE: 15 / 07 / 25
SCALE: 1: 200.	DRAWING No.: BM0824 - 5/20



BORONIA ANEMONIFOLIA STICKY BORONIA MATURE HEIGHT APPROX. 1.5m



LEUCOPYHTA BROWNII CUSHION BUSH MATURE HEIGHT APPROX. 1.0m



SEDUM SPECTABILE ICE PLANT MATURE HEIGHT APPROX. 0.7m



DIANELLA TASMANICA (TASMANIAN FLAX LILY) MATURE HEIGHT APPRÓX. 1.0m

PLANS SHOWN INDICATE TYPE AND HEIGHT TO BE PLANTED SIMILAR VARIATIONS MAY BE INSTALLED AT TIME OF PLANING



SIR WALTER BUFFALO OR SIMILAR GRASS



15mm-20mm 'NO FINES' DECORATIVE STONE OR MULCH TO ALL GARDEN BEDS.



SEALED DRIVEWAY TO FALL TO PITS



PRIVATE OPEN SPACE 6x4m OR 5x5m MAX GRADE 1:10



CRUSHED GRAVEL PATH OR STEPPING STONE PAVERS TO CLOTHES LINE



1.7x0.9m WHEELIE BIN STORAGE MINIMUM 1.5m2




L LETTERBOX



MAIN POWER BOARD LOCATED WITHIN COMMON GROUND

1800mm HIGH LAPPED PAILING FENCE OR SOLID COLORBOND FENCE. ALL BOUNDARY FENCES TO TITLE BOUNDARY THAT ARE PART OF THE PRIVATE YARD OF THE UNITS TO BE SOLID 1800mm HIGH MINIMUM. EXISTING FENCES UPGRADED AS REQUIRED.

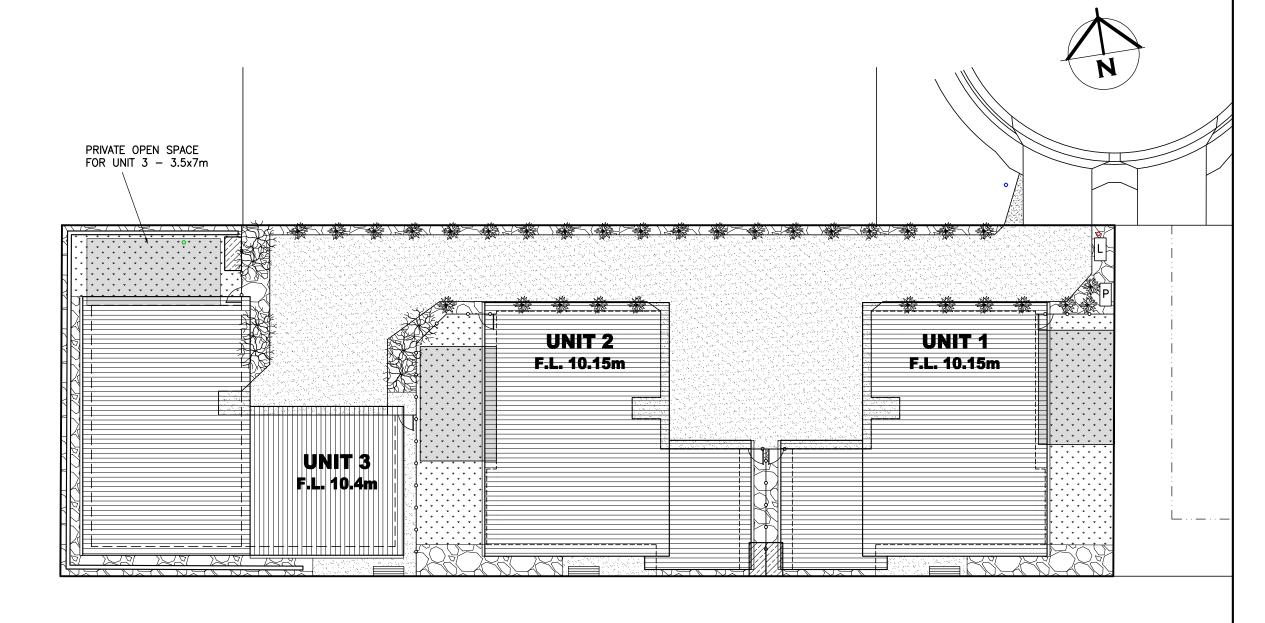

### **LANDSCAPING PLAN**

PRIVATE YARD AREA UNIT 1 = 76 sg/mPRIVATE YARD AREA UNIT 2 = 76 sg/m PRIVATE YARD AREA UNIT 3 = 96 sq/m

NOT INCLUDING BUILDING AREA PLANTING INSIDE PRIVATE YARD BY OWNER




### **BRADLEY VAN ZETTEN**

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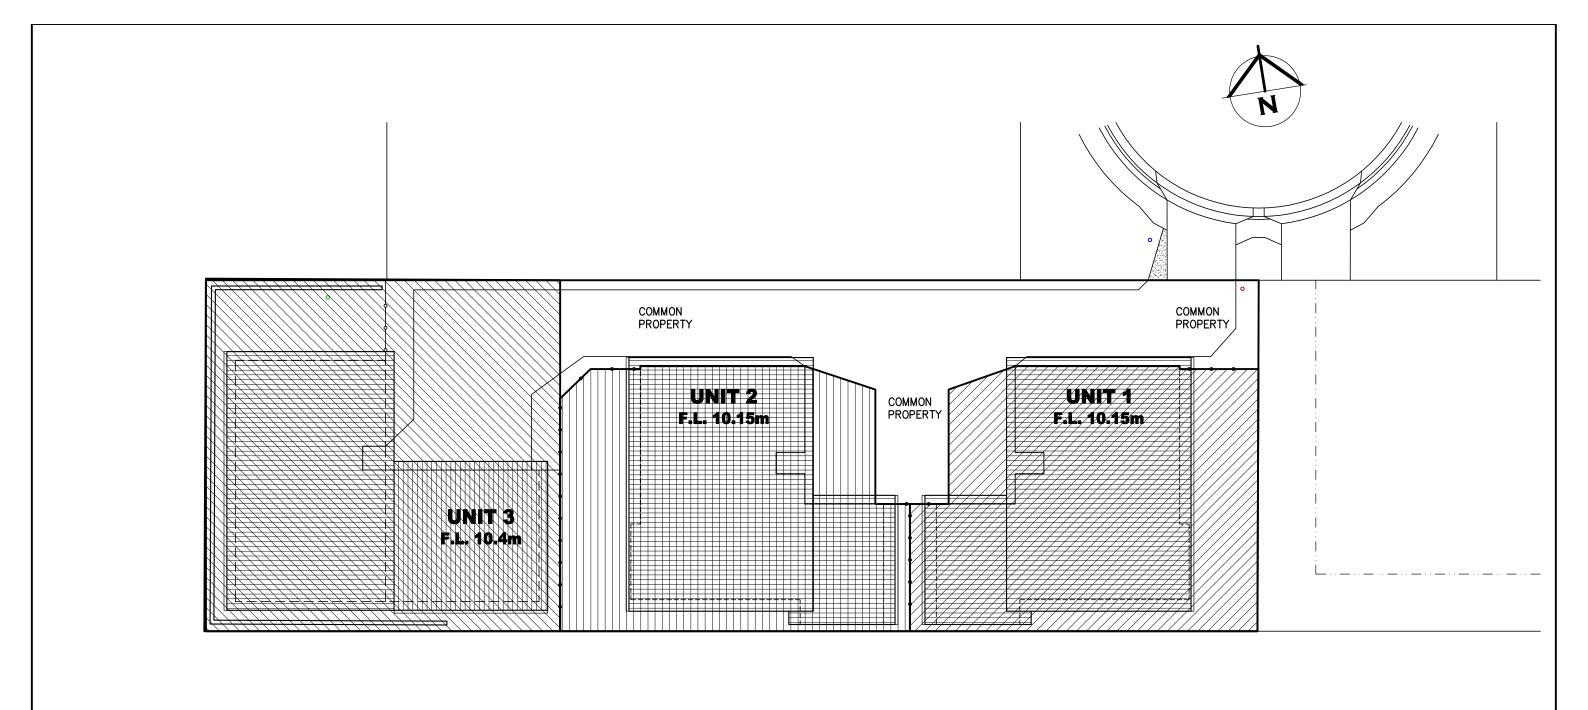
PROJECT: PROPOSED UNIT DEVELOPMENT FOR BM PROPERTY DEVELOPMENT PTY LTD

AT LOT 5 IMOGEN COURT OFF UNIT 7 - 176 FRESHWATER POINT ROAD LEGANA 7277

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REVISION NUMBER	DATE	DRAWING: LAN	DSCAPING F	LAN	
REVISION 1	12 / 05 / 2024				
REVISION 2	01 / 08 / 2024				
REVISION 3	03 / 08 / 2024	DECIONED. D	7		
REVISION 4	05 / 08 / 2024	DESIGNED: B.	V. Z.	APPROVED.	
REVISION 5	10 / 07 / 2025	DRAWN: B. v.	7.	DATE: 15 / 07 / 2	5
REVISION 6	15 / 07 / 2025	5	_,	DAIL. 15 / 07 / 2	
		SCALE: 1: 200.		DRAWING No.:	
		00/122			
			A3.	BM0824 - 6/20	

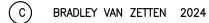

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### STRATA/ STAGE PLAN

EXACT STRATA BOUNDARY TO BE CONFIRMED ONCE CONSTRUCTION IS COMPLETED AND STRATA PLAN IS COMPLETED BY LAND SURVEYOR

COMMON PROPERTY

UNIT 1 STRATA TITLE



UNIT 2 STRATA TITLE



UNIT 3 STRATA TITLE



## **BRADLEY VAN ZETTEN**

4 EDEN HILLS DRIVE
RIVERSIDE 7250
P. 0407 272 381
E. BVZDESIGNS@GMAIL.COM LICENCE NUMBER 957699796

PROJECT: PROPOSED UNIT DEVELOPMENT FOR BM PROPERTY DEVELOPMENT PTY LTD AT LOT 5 IMOGEN COURT OFF

UNIT 7 - 176 FRESHWATER POINT ROAD LEGANA 7277

DF	DATE	REVISION NUMBER
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הר	03 / 08 / 2024	REVISION 3
DE	05 / 08 / 2024	REVISION 4
DR	10 / 07 / 2025	REVISION 5
	15 / 07 / 2025	REVISION 6
SC		
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	DRAWING:	STRATA	PLAN
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4			


ESIGNED: B. v. Z. APPROVED. RAWN: B. v. Z. DATE: 15 / 07 / 25


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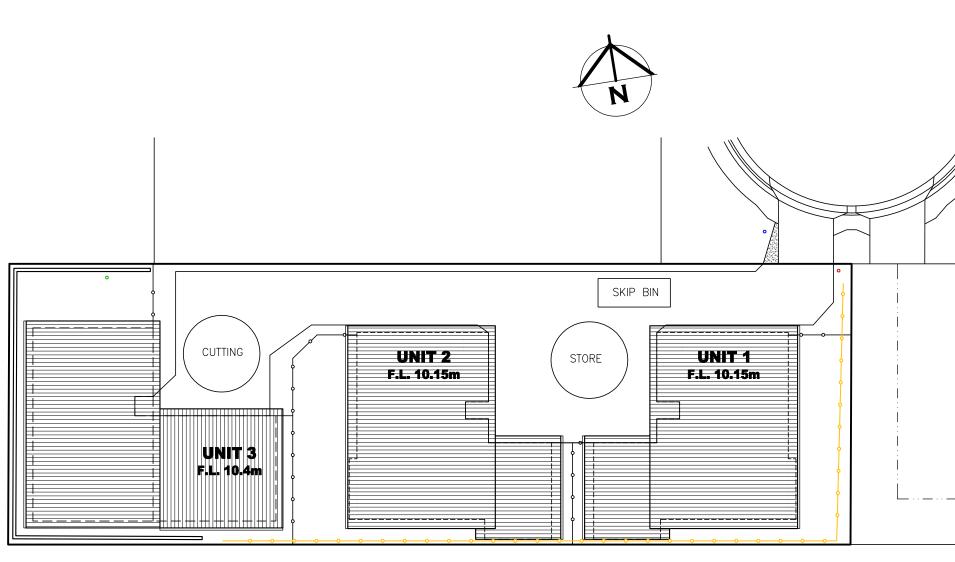
DRAWING No.: BM0824 - 7/20

BRADLEY VAN ZETTEN 2024

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BUILDING SITE DURING CONSTRUCTION TO COMPLY WITH EPA TASMANIA, SOIL AND WATER MANAGEMENT ON BUILDING SITES WHERE POSSIBLE. REFER TO FACT SHEETS 1-19 EPA.TAS.GOV.AU/ENVIRONMENT/WATER/STORMWATER/SOIL-AND-WATER-MANAGEMENT-ON-BUILDING-SITES

FACT SHEET 3 - SOIL AND WATER MANAGEMENT. PLAN TO BE KEPT ONSITE AND ALL TIMES AND ALL WORKERS UNDERSTAND THE SWMP

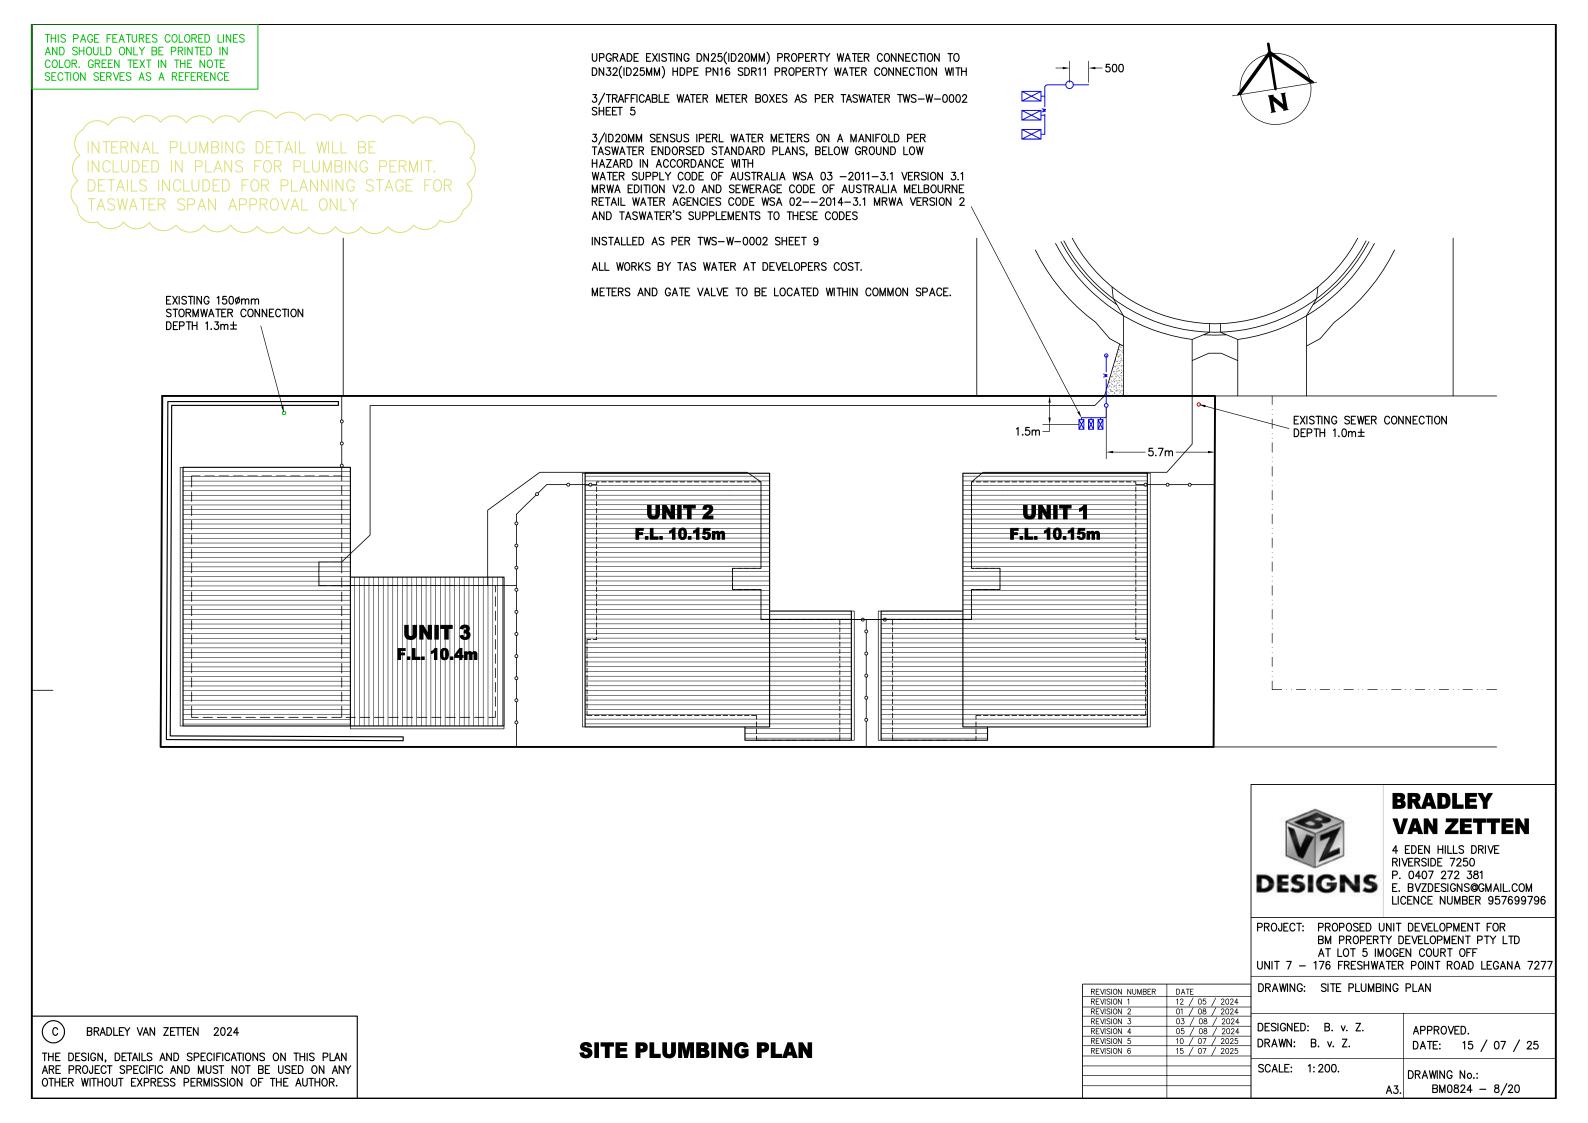FACT SHEET 4 - DISPERSIVE SOILS, NOT APPLICABLE.

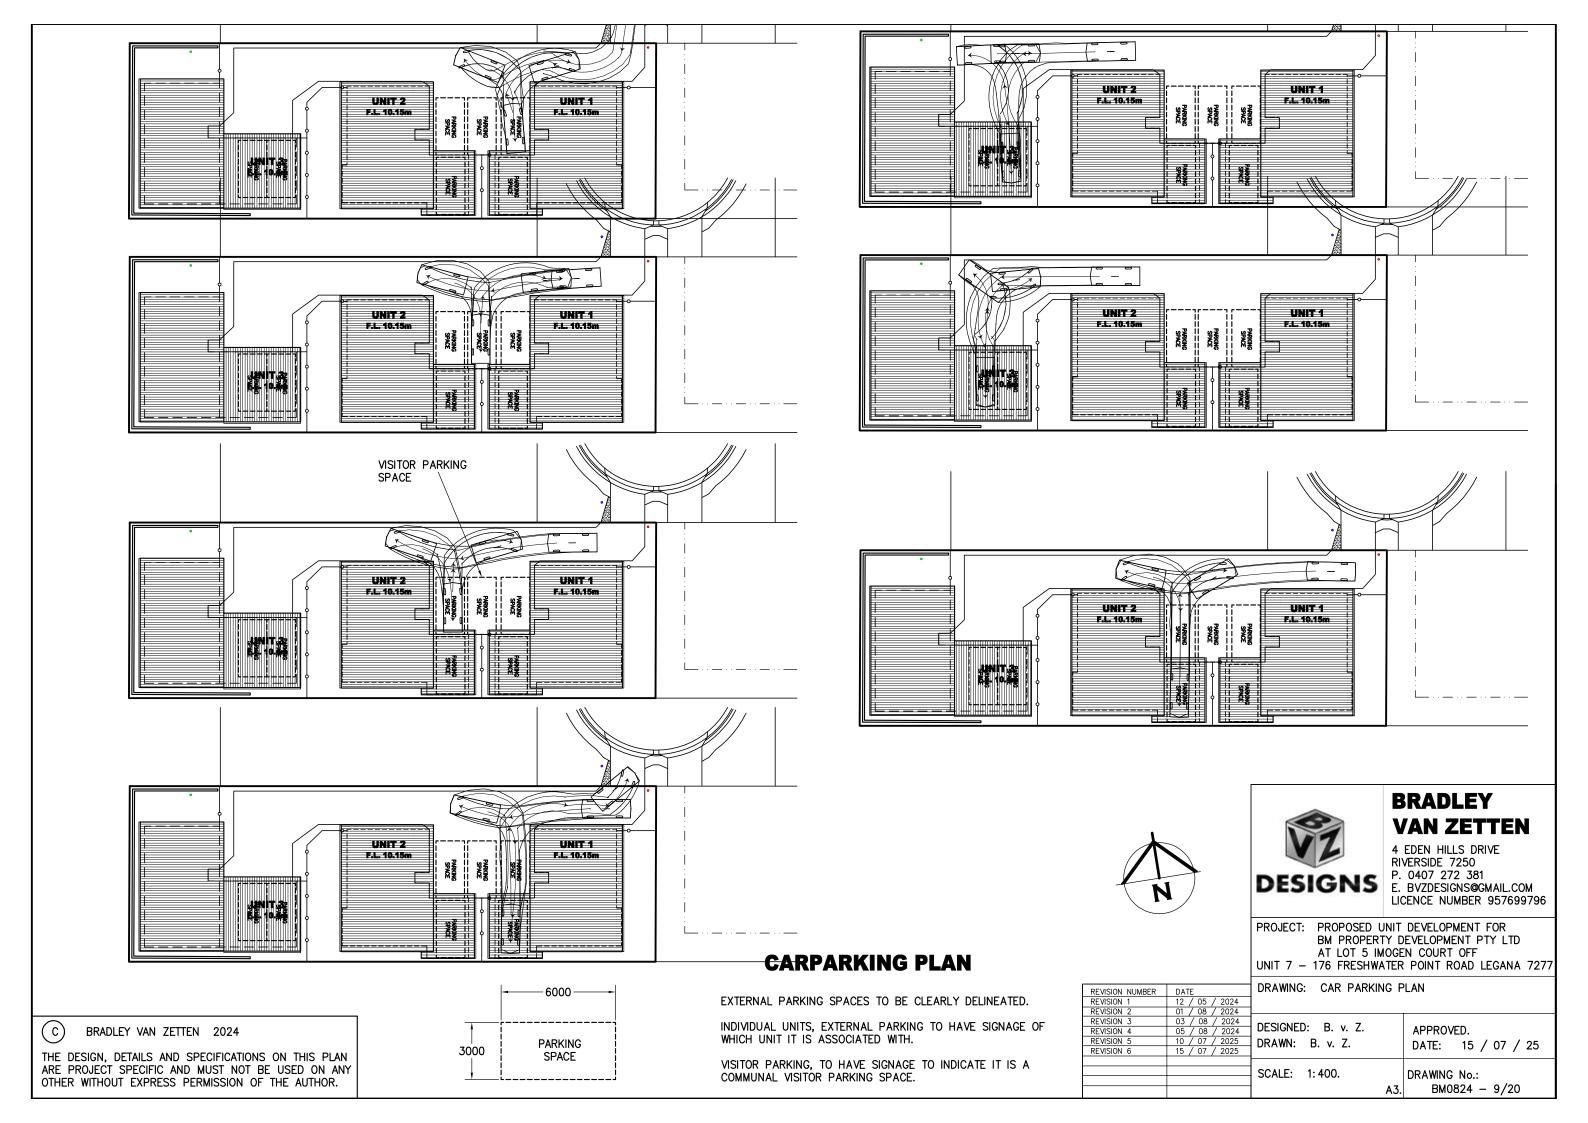FACT SHEET 5 - MINIMISE SOIL DISTURBANCE.

DO TRACK MACHINERY UP AND DOWN THE SLOPE TO CREATE GROOVES FROM THE WHEELS/ OR TRACKS THAT WILL CATCH RAINFALL. THE GROOVES WILL ROUGHEN THE SURFACE IN A WAY THAT WILL SLOW RUNOFF. AS PER FACT SHEET CLEARING FOR WORKS TO BE LIMITED TO WITHIN 5 METRES FROM THE EDGE OF ANY ESSENTIAL CONSTRUCTION ACTIVITY. NO TOPSOIL SHALL BE REMOVED FROM LAND OUTSIDE THE AREAS OF GROUND DISTURBANCE SHOWN. ALL AREAS OF GROUND DISTURBANCE MUST BE DRESSED WITH TOP SOIL AND WHERE APPROPRIATE REVEGETATED AND STABILISED TO PREVENT FUTURE

SHEET 6 - PRESERVE VEGETATION.

WHERE EXISTING TREES ARE TO REMAIN ON THE SITE, ESTABLISH NO GO AREA AROUND TREES OF BRIGHT TAPE ON STAR PICKETS MINIMUM 1th AWAY FROM BASE OF TREE

EXISTING GROUND VEGETATION TO BE RETAINED WHEN EVER POSSIBLE. MINIMUM 400mm WIDE GRASS STRIPS TO BE RETAINED ON BACK OF KERB OR FILTERING RUNOFF. INSTALLED AS PER FACT SHEET

FACT SHEET 7 - DIVERT UP-SLOPE WATER

DIVERSION CHANNEL TO BE CONSTRUCTED ON HIGHSIDE OF SITE MINIMUM 150MM DEEP WITH 10% MAX FALL WITH A CURVED SHAPE WITH EXCAVATED SOIL FROM THE CHANNEL ON THE DOWN-SLOPE SIDE TO INCREASE DIVERSION CHANNEL CAPACITY.

LEVEL SPREADER TO END OF DIVERSION CHANNEL TO ENSURE WATER DISCHARGE IS SLOW MOVING MINIMUM 4M WIDE. INSTALLED AS PER FACT SHEET

FACT SHEET 8 — EROSION CONTROL MATS AND BLANKETS
WHERE FINISHED BATTERS ARE PROPOSED TO BE STEEPER THAN 1:3 EROSION CONTROL BLANKETS TO BE INSTALLED ON BATTER FOR SITE REHABILITATION. INSTALLED AS PER FACT SHEET

FACT SHEET 9 - PROTECT SERVICES TRENCHES AND STOCKPILES

ALL STOCKPILES TO BE POSITIONED CLEAR OF WATER COURSES AND TO ENSURE THAT NO SILT RUNOFF CAN ENTER A WATER

TOP SOIL TO BE STOCKPILED SEPARATELY AND SPREAD OVER BACKFILLED AREAS. SPOIL TO BE STOCKPILED IN A NARROW CORRIDOR ON THE UPSTREAM SIDE OF ALL EXCAVATION. TEMPORARY CATCH DRAINS TO BE CONSTRUCTED ON THE UPSTREAM SIDE OF STOCKPILES AND EXCAVATED AREAS, DIRECTING RUNOFF TO EXISTING STORMWATER SYSTEM. SERVICE TRENCHES TO HAVE SOIL PLACED ON TOPSIDE OF TRENCH TO DIVERT WATER FLOW AWAY FROM THE TRENCH LINE.

FACT SHEET 10 - EARLY ROOF DRAINAGE CONNECTION DOWNPIPES TO BE CONNECTED INTO STORMWATER SYSTEM AS SOON AS THE ROOF IS INSTALLED. TEMPORARY DOWNPIPES TO DIRECT WATER TO TUFTED AREAS.

FACT SHEET 11 - SCOUR PROTECTION

NOT APPLICABLE AS NO NEW DAMS/ CULVERTS

FACT SHEET 12 - STABILISED SITE ACCESS DIVERSION HUMP INSTALLED ON ROAD ACCESS WITH WATER DIRECTED TO SEPARATE SILT FENCE. INSTALLED AS PER FACT SHEET

FACT SHEET 13 - WHEEL WASH

EVERY EFFORT TO BE MADE TO MINIMISE SPREADING SEDIMENT ON TO SEALED AREAS WHEN VEHICLES LEAVE THE SITE, INCLUDING THE WASHING DOWN OF TYRES.

FACT SHEET 14 - SEDIMENT FENCES SEDIMENT FENCE INSTALLED AS PER DETAIL AND FACT SHEET

FACT SHEET 15 - PROTECTION OF STORMWATER PITS

PITS INSTALLED ONSITE TO BE CONSTRUCTED WITH DRIVEWAY AT END OF JOB AFTER FINISHED CONSTRUCTION OF BUILDING. THEREFORE NO REQUIREMENTS FOR PITS.

FACT SHEET 16 - PROTECTED CONCRETE, BRICK AND TILE CUTTING
ALL CUTTING TO BE INSIDE NOMINATED AREA AS PER SWMP WITH FILTER SOCKS INSTALLED ON LOW SIDE. SLURRY TO BE DISPOSED OFF IN GEOTEXTILE LINED DITCH OR DRUMS

FACT SHEET 17 - SEDIMENT BASINS NOT REQUIRED DUE TO SCALE OF WORKS.

FACT SHEET 18 - DUST CONTROL

DURING EXTENDED PERIODS OF DRY WEATHER, DAMPEN THE SITE SLIGHTLY WITH A LIGHT APPLICATION OF WATER DURING EXCAVATION OR WHEN DUST IS BEING RAISED

ALL OF SITE THAT IS NOT FINISHED IN HARD SURFACES TO BE REVEGETATION WITH GRASS OR MULCH AS PER LANDSCAPING PLAN OR TO OWNERS DETAILS

### **SOIL AND WATER MANAGEMENT PLAN**


SILT FENCE AS PER DETAIL

REVISION NUMBER	DATE
REVISION 1	12 / 05 / 2024
REVISION 2	01 / 08 / 2024
REVISION 3	03 / 08 / 2024
REVISION 4	05 / 08 / 2024
REVISION 5	10 / 07 / 2025
REVISION 6	15 / 07 / 2025

DOWNPIPES TO BE CONNECTED INTO STORMWATER SYSTEM AS SOON AS THE ROOF IS INSTALLED

INSTALL AG DRAIN (IF SHOWN) PRIOR TO FOOTING EXCAVATION


EXCAVATED MATERIAL PLACED UP SLOPE OF CUT OFF DRAIN. TO BE REMOVED WHEN BUILDING WORKS ARE COMPLETE AND USED AS FILL ON SITE FOR ANY LOW POINTS, INSTALL A SEDIMENT FENCE ON THE DOWNSLOPE SIDE OF MATERIAL

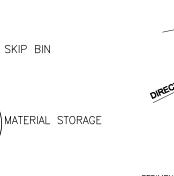



SKIP BIN

STORE

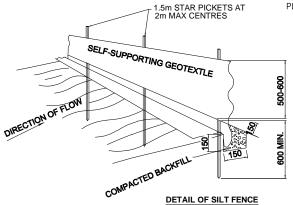

SEDIMENT FENCE NOTES:

1. SURVEY AND MARK OUT LOCATION OF SEDIMENT FENCE, ENSURE IT IS PARALLEL TO THE CONTOURS

OF THE SITE AND TO DRAIN IN THE CORRECT DIRECTION
2. DIG A 150 MM TRENCH IMMEDIATELY ABOVE THE PROPOSED FENCE LINE.

3. PLACE THE BOTTOM OF THE FABRIC TO THE BASE OF THE TRENCH AND RUN FABRIC UP THE DOWN-SLOPE SIDE OF THE TRENCH. 4. BACKFILL THE TRENCH AND COMPACT TO SECURE ANCHORAGE OF THE FABRIC

T. DAVID ILL INCLUDING AND SOLUTION AND SOLUTION AND FASTEN FABRIC TO PICKETS INTO GROUND, 2 M APART TO SUPPORT THE SEDIMENT FENCE FABRIC. TENSION AND FASTEN FABRIC TO PICKETS USING UV STABILISED ZIP TIES OR WIRE TIES. 6 JOIN SECTIONS OF FABRIC AT A SUPPORT POST WITH A 2 M OVERLAP

7. ANGLE THE ENDS OF THE SEDIMENT FENCE UPSLOPE TO REDUCE SCOURING

VZ
DESIGN

### **BRADLEY VAN ZETTEN**

4 EDEN HILLS DRIVE RIVERSIDE 7250 P. 0407 272 381 E. BVZDESIGNS@GMAIL.COM LICENCE NUMBER 957699796

PROJECT: PROPOSED UNIT DEVELOPMENT FOR BM PROPERTY DEVELOPMENT PTY LTD AT LOT 5 IMOGEN COURT OFF UNIT 7 - 176 FRESHWATER POINT ROAD LEGANA 7277

DRAWING: SOIL AND WATER MANAGEMENT PLAN

DESIGNED: B. v. Z. APPROVED. DRAWN: B. v. Z. DATE: 15 / 07 / 25

SCALE: 1:300.


DRAWING No.:

A3. BM0824 - 10/20 BRICK VENEER WALL

90mm TIMBER FRAMED WALL WITH CEMENT SHEET CLADDING

90mm Stud Wall With 10mm Plaster Board Lining Throughout. (Wet Area PlasterBoard to Wet AREA WALLS)



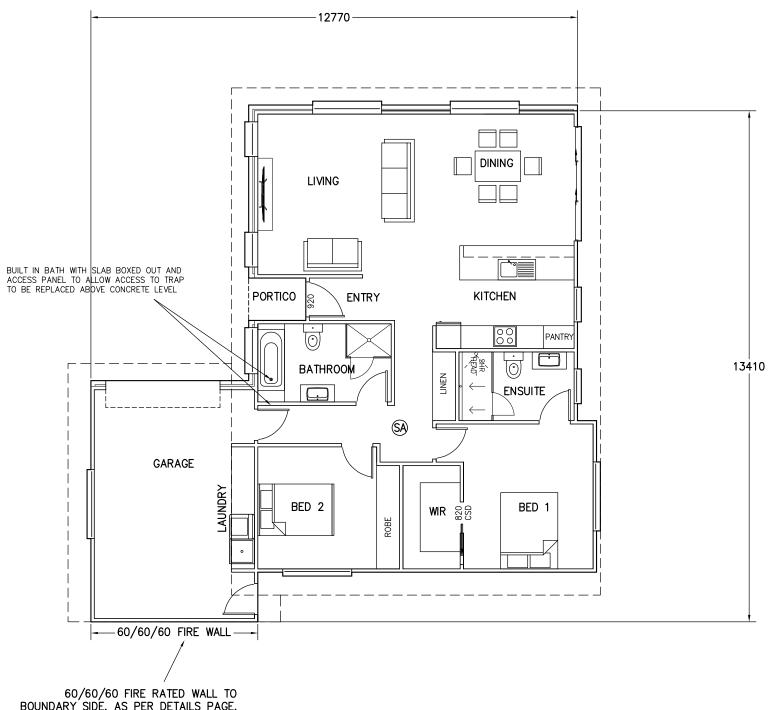

BOUNDARY SIDE. AS PER DETAILS PAGE.

ENTIRE WALL SYSTEM AS PER "DESIGN GUIDE HARDIES SMART BOUNDARY WALL SYSTEM CLASS 1 & 10A TIMBER FRAME BUILDING".

**FLOOR PLAN UNIT 1** 

BRICK VENEER - DIMENSIONS AND AREA TO OUTSIDE CLADDING CLAD FRAME - DIMENSIONS AND AREA TO OUTSIDE OF TIMBER FRAMING. CLADDING IN ADDITION TO DIMENSIONS ALL INTERNAL DOORS ARE 820mm UNLESS OTHERWISE NOTED

SA) – 240V HARD WIRED SMOKE ALARMS INSTALLED IN ACCORDANCE WITH NCC9.5 TO COMPLY WITH AS3786, BE CONNECTED TO MAINS POWER AND INTERCONNECTED WHERE THERE IS MORE THAN ONE ALARM



### **BRADLEY VAN ZETTEN**

4 EDEN HILLS DRIVE RIVERSIDE 7250 P. 0407 272 381 DESIGNS P. 0407 272 381 E. BVZDESIGNS@GMAIL.COM LICENCE NUMBER 957699796

PROJECT: PROPOSED UNIT DEVELOPMENT FOR BM PROPERTY DEVELOPMENT PTY LTD AT LOT 5 IMOGEN COURT OFF

UNIT 7 - 176 FRESHWATER POINT ROAD LEGANA 7277

	DRAWING:	FLOOR PLAN C	JNII 1
24			

REVISION NUMBER DATE
REVISION 1 12 /

REVISION 4

REVISION 5

SCALE: 1:100. DRAWING No.:

BM0824 - 11/20

PORTICO AREA 1.7 0.2 TOTAL AREA 134.3 14.5

AREA TABLE


FLOOR AREA


SQUARE METER

132.6

BUILDING SQUARES

14.3

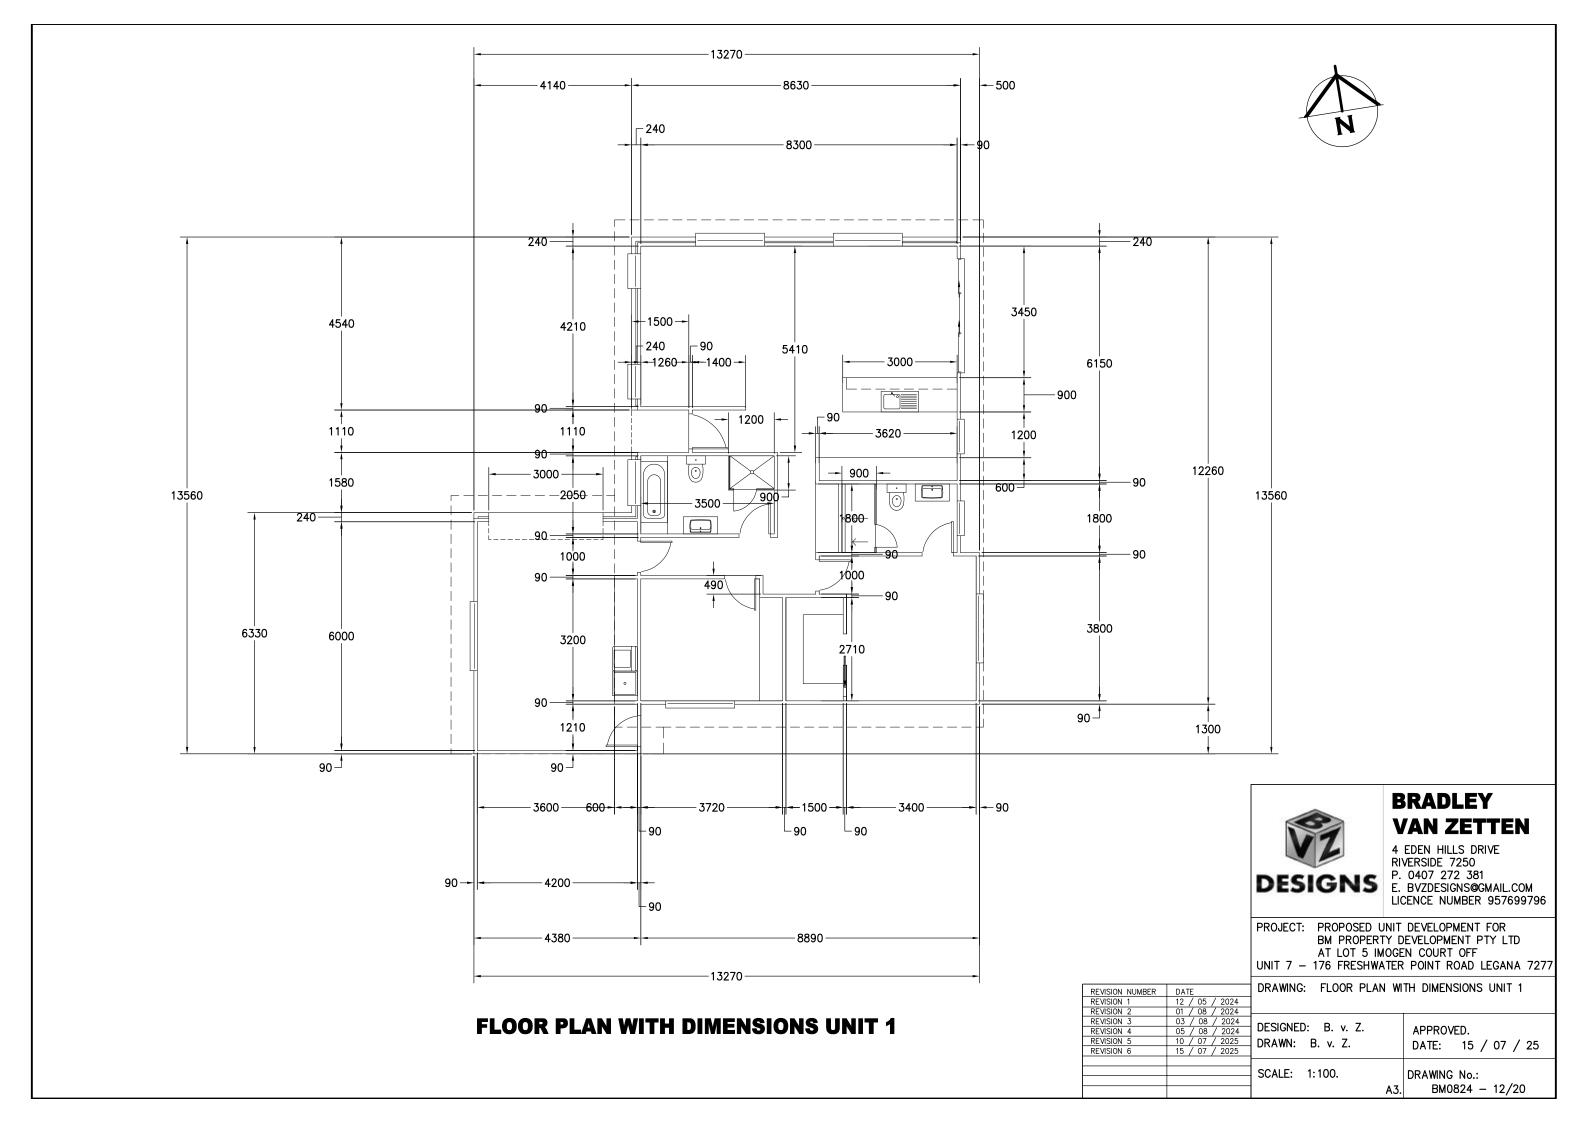

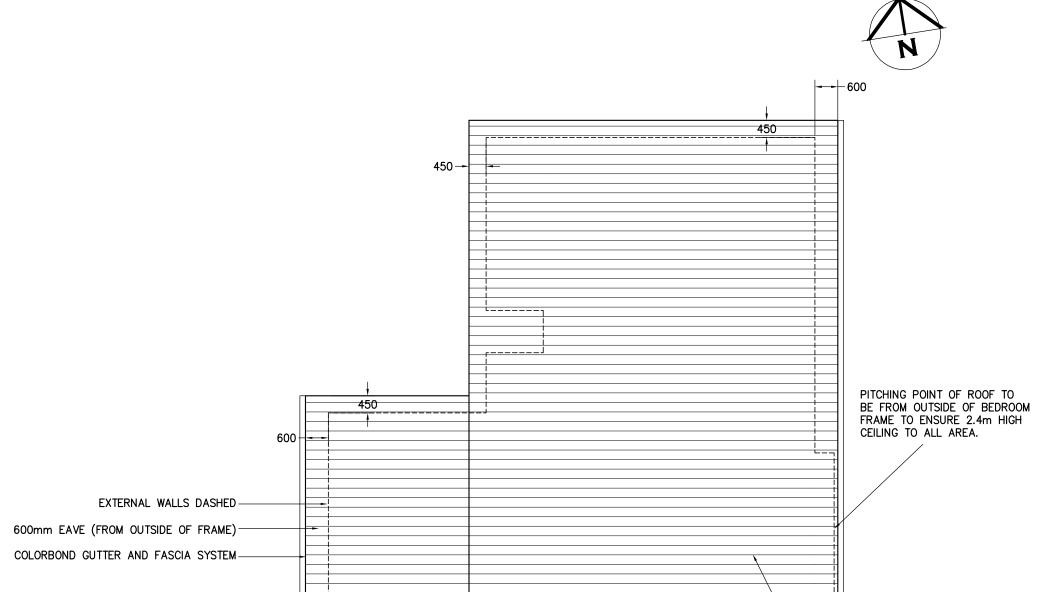

**ROOF PLAN UNIT 1** 

DUCTED TO EAVE/WALL VENT

75x38mm HARD WOOD OR 70x35mm MGP12

RANGEHOOD AND BATHROOM EXTRACTION FANS

BATTENS AT 900mm MAX 900mm CRS AND SPAN.

COLORBOND CUSTOM ORB ROOF SHEETING AT 5.0°. ONE AND A HALF CORRUGATION SIDE LAP (TYPICAL). FIXED AT SIDE LAPS. 3 FIXINGS FOR INTÉRNAL SPANS AND 5 FOR END SPANS. FIXED WITH ROOFZIPS M6-11x50mm FOR SOFTWOOD AND STEEL 0.55-1.0mm BMT BATTENS 12-14x35 METAL TEK 1.0-3.0mm BMT STEEL BATTENS 12-11x50mm FOR HARDWOOD

600 –

ROOF CLADDING TO COMPLY WITH NCC PART 7.1-7.5

GUTTERS AND DOWNPIPES INSTALLED AS PER NCC PART 7.4 GUTTER MUST BE INSTALLED WITH A FALL NOT LESS THAN

• 1:500 FOR EAVES GUTTERS, UNLESS FIXED TO METAL FASCIAS

WHERE HIGH FRONTED GUTTERS ARE INSTALLED, PROVISION MUST BE MADE TO AVOID ANY OVERFLOW BACK INTO THE ROOF OR BUILDING STRUCTURE BY INCORPORATING OVERFLOW MEASURERS OR THE LIKE

DOWNPIPES MUST--

(A)NOT SERVE MORE THAN 12 M OF GUTTER LENGTH FOR EACH DOWNPIPE; AND

(B)BE LOCATED AS CLOSE AS POSSIBLE TO VALLEY GUTTERS:

(C)BE SELECTED IN ACCORDANCE WITH THE APPROPRIATE EAVES GUTTER SECTION AS SHOWN IN TABLE 7.4.3A, TABLE 7.4.3B AND TABLE 7.4.3C.

FOR ROOF CATCHMENTS UP TO 50SQ/M PER DOWNPIPE MEDIUM RECTANGULAR GUTTERS OR 115MM 'D' GUTTERS MAY BE USED WITH 90ØMM DOWNPIPES

EAVE AND GUTTER OVERFLOW MEASURE TO BE INSTALLED FOR 1% ANNUAL EXCEEDANCE PROBABILITY

BOX GUTTERS AS PER AS3500.3

7.4.6 ACCEPTABLE CONTINUOUS OVERFLOW MEASURE

(1) FOR A FRONT FACE SLOTTED GUTTER WITH-

A MINIMUM SLOT OPENING AREA OF 1200 MM2 (A) PER METRE OF GUTTER; AND

(a) THE LOWER EDGE OF THE SLOTS INSTALLED A MINIMUM OF 25 MM BELOW THE TOP OF THE FASCIA.

THE ACCEPTABLE OVERFLOW CAPACITY MUST BE 0.5 L/S/M. CONSTRUCTED IN ACCORDANCE WITH FIGURE 7.4.6A.

(2) FOR A CONTROLLED BACK GAP WITH-

- (a) A PERMANENT MINIMUM 10 MM SPACER INSTALLED BETWEEN THE GUTTER BACK AND THE FASCIA; AND
- (b) ONE SPACER PER BRACKET, WITH THE SPACER NOT MORE THAN 50 MM WIDE; AND
- (c) THE BACK OF THE GUTTER INSTALLED A MINIMUM OF 10 MM BÉLOW THE TOP OF THE FASCIA.

THE ACCEPTABLE OVERFLOW CAPACITY MUST BE 1.5 L/S/M, CONSTRUCTED IN ACCORDANCE WITH FIGURE 7.4.6B.

(3) FOR THE CONTROLLED BACK GAP OPTION, THE SPACER CAN BE A PROPRIETARY CLIP OR BRACKET THAT PROVIDES THE REQUIRED OFFSET OF

THE GUTTER FROM THE FASCIA.

### **BRADLEY VAN ZETTEN**

4 EDEN HILLS DRIVE RIVERSIDE 7250 P. 0407 272 381 DESIGNS E. BYZDESIGNS@GMAIL.COM LICENCE NUMBER 957699796

PROJECT: PROPOSED UNIT DEVELOPMENT FOR BM PROPERTY DEVELOPMENT PTY LTD AT LOT 5 IMOGEN COURT OFF UNIT 7 - 176 FRESHWATER POINT ROAD LEGANA 7277

REVISION NUMBER DATE REVISION 1 03 / 08 / 2024 05 / 08 / 2024 10 / 07 / 2025 REVISION REVISION 4 REVISION 5 DRAWN: B. v. Z. 15 / 07 / 2025

DRAWING: ROOF PLAN UNIT 1

DESIGNED: B. v. Z. APPROVED. DATE: 15 / 07 / 25


SCALE: 1:100.

DRAWING No.: BM0824 - 13/20 BRICK VENEER WALL

90mm TIMBER FRAMED WALL WITH CEMENT SHEET CLADDING

90mm Stud Wall With 10mm Plaster Board Lining Throughout. (Wet Area PlasterBoard to Wet AREA WALLS)



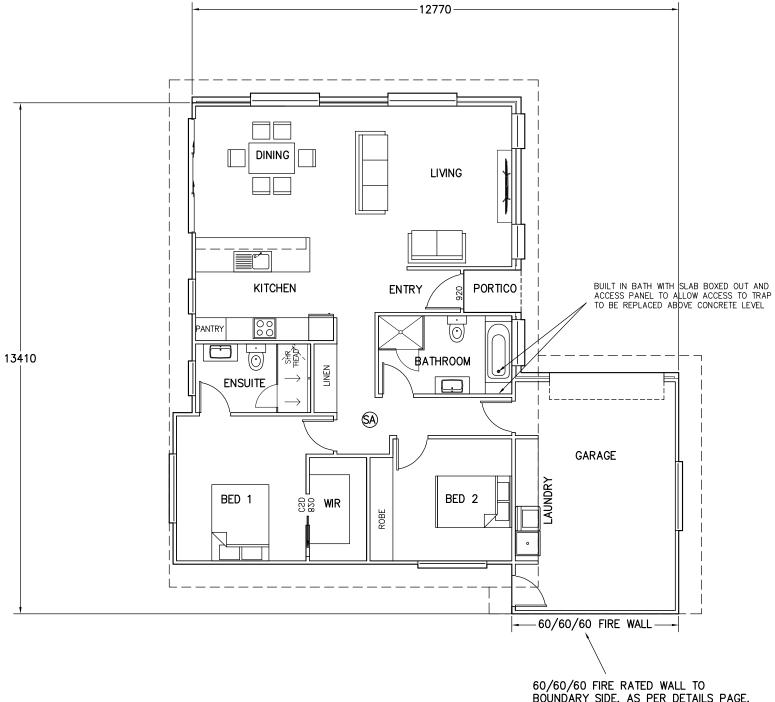

BOUNDARY SIDE. AS PER DETAILS PAGE.

ENTIRE WALL SYSTEM AS PER "DESIGN GUIDE HARDIES SMART BOUNDARY WALL SYSTEM CLASS 1 & 10A TIMBER FRAME BUILDING".

REVISION NUMBER DATE
REVISION 1 12 /

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REVISION 5

INSTALLED IN ACCORDANCE WITH NCC9.5 TO COMPLY WITH AS3786, BE CONNECTED TO MAINS POWER AND INTERCONNECTED WHERE THERE IS MORE THAN ONE ALARM

SA) – 240V HARD WIRED SMOKE ALARMS



### **BRADLEY VAN ZETTEN**

4 EDEN HILLS DRIVE RIVERSIDE 7250 P. 0407 272 381 DESIGNS P. 0407 272 381 E. BVZDESIGNS@GMAIL.COM LICENCE NUMBER 957699796

DATE: 15 / 07 / 25

PROJECT: PROPOSED UNIT DEVELOPMENT FOR BM PROPERTY DEVELOPMENT PTY LTD AT LOT 5 IMOGEN COURT OFF UNIT 7 - 176 FRESHWATER POINT ROAD LEGANA 7277

DRAWING: FLOOR PLAN UNIT 2


DESIGNED: B. v. Z. APPROVED. DRAWN: B. v. Z.

SCALE: 1:100. DRAWING No.: BM0824 - 14/20


**FLOOR PLAN UNIT 2** 

BRICK VENEER - DIMENSIONS AND AREA TO OUTSIDE CLADDING CLAD FRAME - DIMENSIONS AND AREA TO OUTSIDE OF TIMBER FRAMING. CLADDING IN ADDITION TO DIMENSIONS ALL INTERNAL DOORS ARE 820mm UNLESS OTHERWISE NOTED

AREA TABLE			
SQUARE METER BUILDING SQUARE			
FLOOR AREA	132.6	14.3	
PORTICO AREA	1.7	0.2	
TOTAL AREA	134.3	14.5	

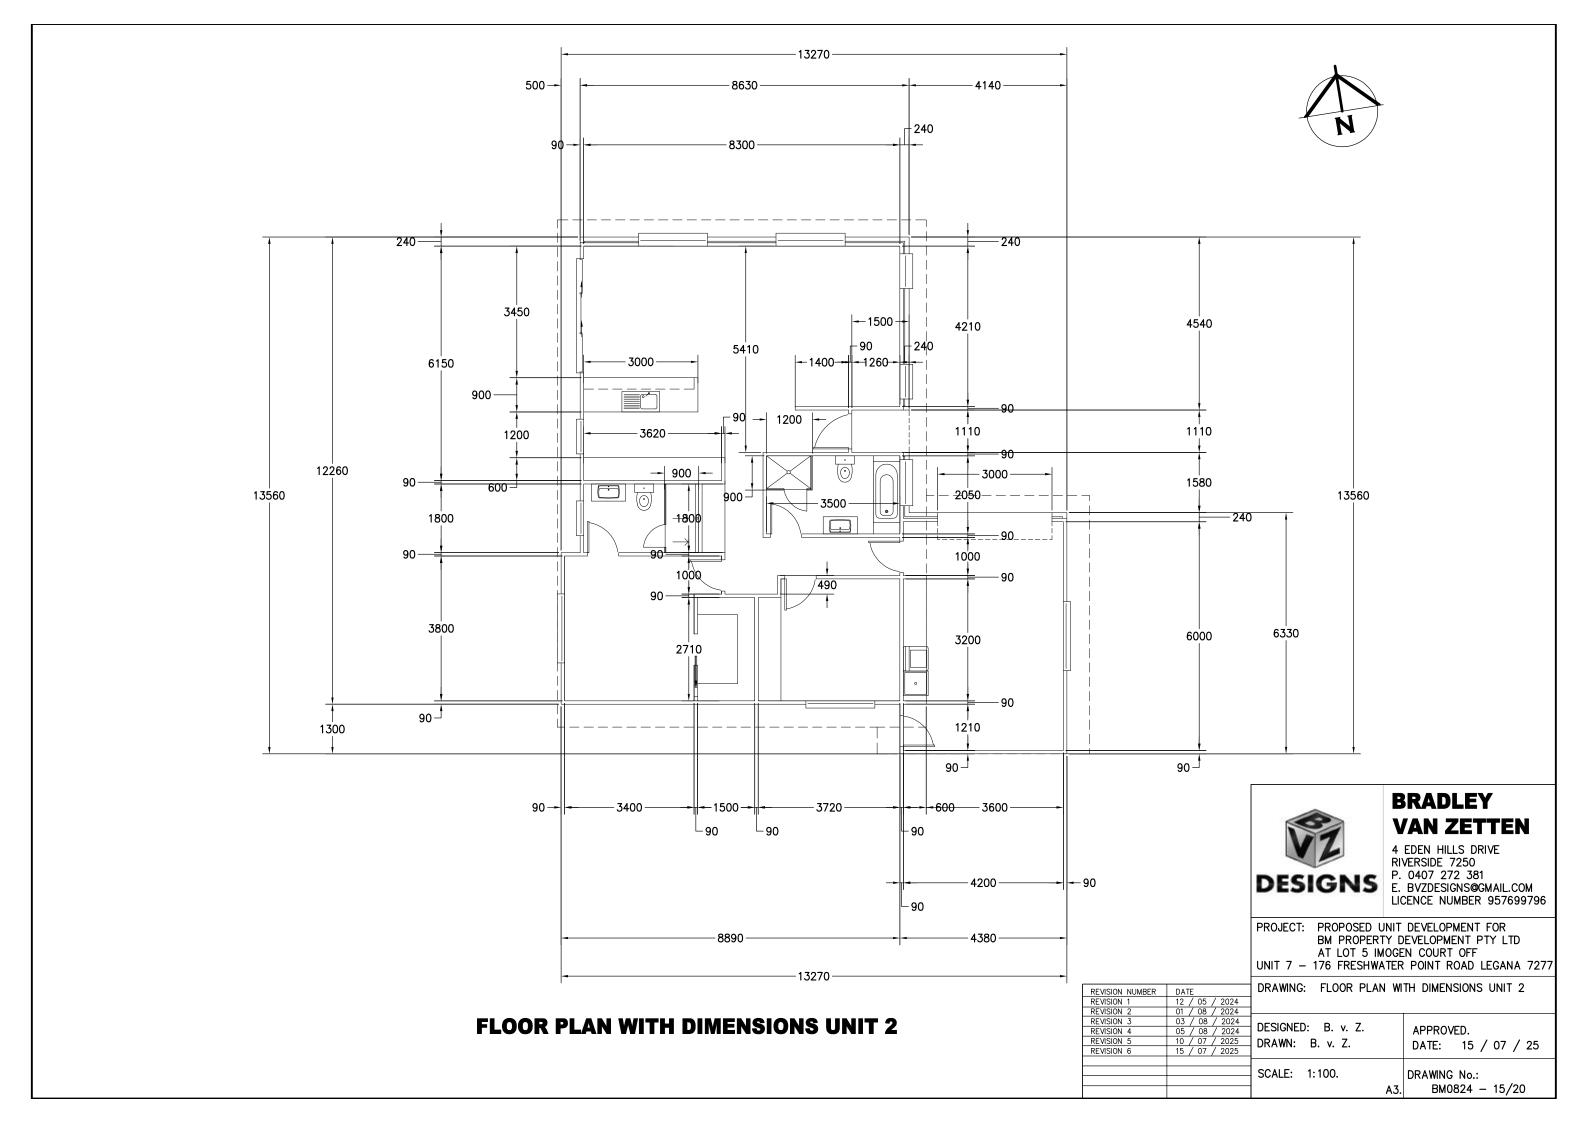



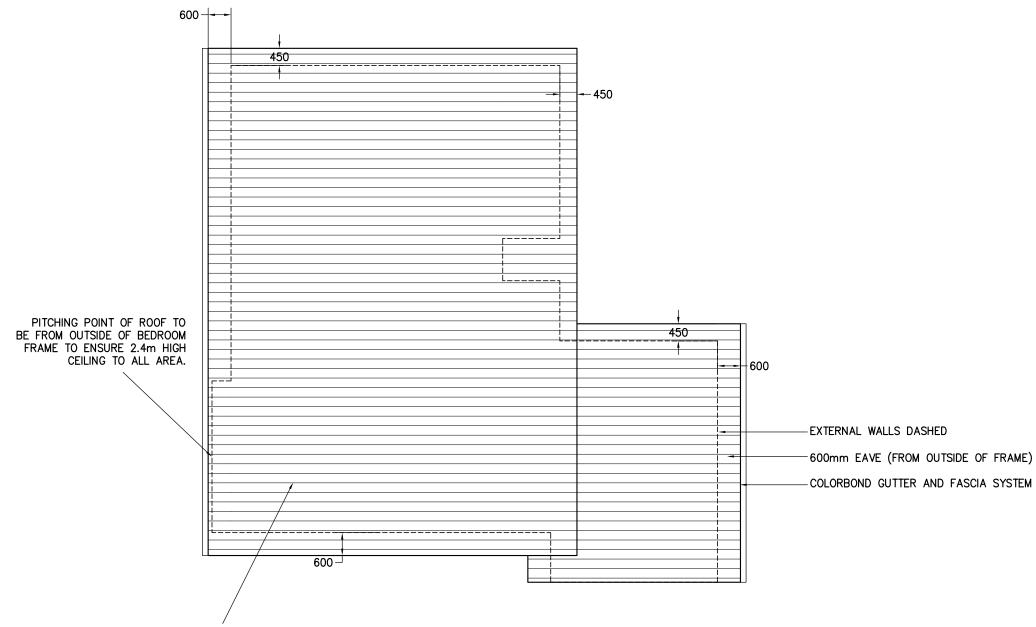

COLORBOND CUSTOM ORB ROOF SHEETING AT 5.0°. ONE AND A HALF CORRUGATION SIDE LAP (TYPICAL). FIXED AT SIDE LAPS. 3 FIXINGS FOR INTERNAL SPANS AND 5 FOR END SPANS. FIXED WITH ROOFZIPS M6-11x50mm FOR SOFTWOOD AND STEEL 0.55-1.0mm BMT BATTENS 12-14x35 METAL TEK 1.0-3.0mm BMT STEEL BATTENS 12-11x50mm FOR HARDWOOD

### **ROOF PLAN UNIT 2**

75x38mm HARD WOOD OR 70x35mm MGP12 BATTENS AT 900mm MAX 900mm CRS AND SPAN.

RANGEHOOD AND BATHROOM EXTRACTION FANS DUCTED TO EAVE/WALL VENT

ROOF CLADDING TO COMPLY WITH NCC PART 7.1-7.5

GUTTERS AND DOWNPIPES INSTALLED AS PER NCC PART 7.4 GUTTER MUST BE INSTALLED WITH A FALL NOT LESS THAN

• 1:500 FOR EAVES GUTTERS, UNLESS FIXED TO METAL FASCIAS

WHERE HIGH FRONTED GUTTERS ARE INSTALLED, PROVISION MUST BE MADE TO AVOID ANY OVERFLOW BACK INTO THE ROOF OR BUILDING STRUCTURE BY INCORPORATING OVERFLOW MEASURERS OR THE LIKE

DOWNPIPES MUST--

(A)NOT SERVE MORE THAN 12 M OF GUTTER LENGTH FOR EACH DOWNPIPE; AND

(B)BE LOCATED AS CLOSE AS POSSIBLE TO VALLEY GUTTERS:

(C)BE SELECTED IN ACCORDANCE WITH THE APPROPRIATE EAVES GÚTTER SECTION AS SHOWN IN TABLE 7.4.3A, TABLE 7.4.3B AND TABLE 7.4.3C.

FOR ROOF CATCHMENTS UP TO 50SQ/M PER DOWNPIPE MEDIUM RECTANGULAR GUTTERS OR 115MM 'D' GUTTERS MAY BE USED WITH 90ØMM DOWNPIPES

EAVE AND GUTTER OVERFLOW MEASURE TO BE INSTALLED FOR 1% ANNUAL EXCEEDANCE PROBABILITY

BOX GUTTERS AS PER AS3500.3

7.4.6 ACCEPTABLE CONTINUOUS OVERFLOW MEASURE

(1) FOR A FRONT FACE SLOTTED GUTTER WITH-

A MINIMUM SLOT OPENING AREA OF 1200 MM2 (A) PER METRE OF GUTTER; AND

(a) THE LOWER EDGE OF THE SLOTS INSTALLED A MINIMUM OF 25 MM BELOW THE TOP OF THE FASCIA.

THE ACCEPTABLE OVERFLOW CAPACITY MUST BE 0.5 L/S/M. CONSTRUCTED IN ACCORDANCE WITH FIGURE 7.4.6A.

(2) FOR A CONTROLLED BACK GAP WITH-

- A PERMANENT MINIMUM 10 MM SPACER INSTALLED BETWEEN THE GUTTER BACK AND THE FASCIA; AND
- (b) ONE SPACER PER BRACKET, WITH THE SPACER NOT MORE THAN 50 MM WIDE; AND
- (c) THE BACK OF THE GUTTER INSTALLED A MINIMUM OF 10 MM BÉLOW THE TOP OF THE FASCIA.

THE ACCEPTABLE OVERFLOW CAPACITY MUST BE 1.5 L/S/M, CONSTRUCTED IN ACCORDANCE WITH FIGURE 7.4.6B.

(3) FOR THE CONTROLLED BACK GAP OPTION, THE SPACER CAN BE À PROPRIETARY CLIP OR BRACKET THAT PROVIDES THE REQUIRED OFFSET OF

THE GUTTER FROM THE FASCIA.



### **BRADLEY VAN ZETTEN**

4 EDEN HILLS DRIVE RIVERSIDE 7250 P. 0407 272 381 DESIGNS E. BYZDESIGNS@GMAIL.COM LICENCE NUMBER 957699796

PROJECT: PROPOSED UNIT DEVELOPMENT FOR BM PROPERTY DEVELOPMENT PTY LTD AT LOT 5 IMOGEN COURT OFF UNIT 7 - 176 FRESHWATER POINT ROAD LEGANA 7277


REVISION NUMBER	DATE	DRAWING: ROOF PLAN UN	IT 2
REVISION 1	12 / 05 / 2024		
REVISION 2	01 / 08 / 2024		
REVISION 3	03 / 08 / 2024	DECIONED D 7	
REVISION 4	05 / 08 / 2024	DESIGNED: B. v. Z.	APPROVED.
REVISION 5	10 / 07 / 2025	DRAWN: B. v. Z.	DATE: 15 / 07 / 25
REVISION 6	15 / 07 / 2025	D. V. 2.	DAIL. 13 / 07 / 23
		SCALE: 1:100.	DRAWING No.:
		A3.	BM0824 - 16/20

BRICK VENEER WALL

90mm TIMBER FRAMED WALL WITH CEMENT SHEET CLADDING

90mm STUD WALL WITH 10mm PLASTER BOARD LINING THROUGHOUT. (WET AREA PLASTERBOARD TO WET AREA WALLS)



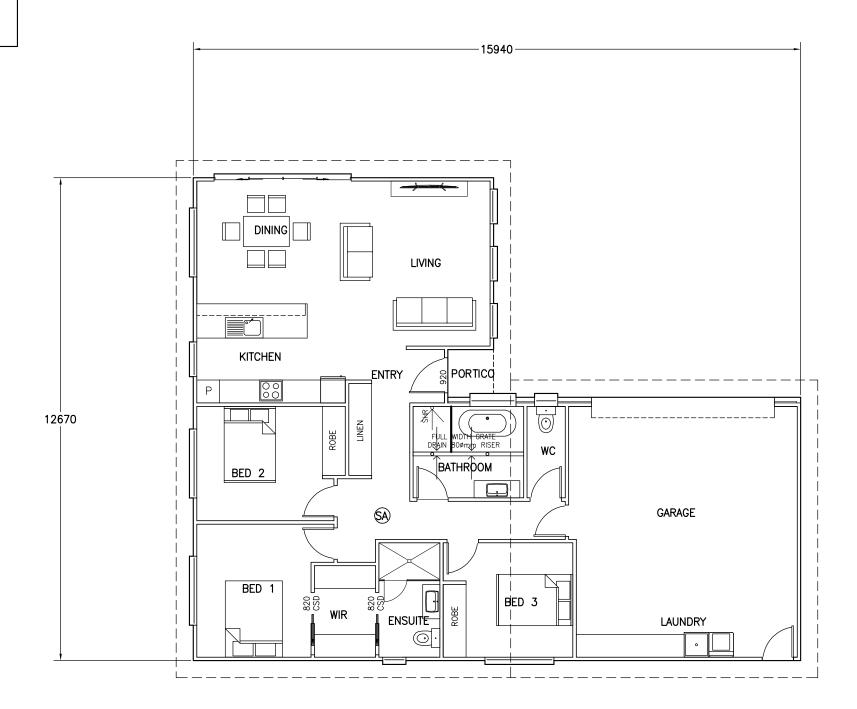

SA) – 240V HARD WIRED SMOKE ALARMS INSTALLED IN ACCORDANCE WITH NCC9.5 TO COMPLY WITH AS3786, BE CONNECTED TO MAINS POWER AND INTERCONNECTED WHERE THERE IS MORE THAN ONE ALARM



### **BRADLEY VAN ZETTEN**

4 EDEN HILLS DRIVE RIVERSIDE 7250 P. 0407 272 381 DESIGNS P. 0407 272 381 E. BVZDESIGNS@GMAIL.COM LICENCE NUMBER 957699796

PROJECT: PROPOSED UNIT DEVELOPMENT FOR BM PROPERTY DEVELOPMENT PTY LTD AT LOT 5 IMOGEN COURT OFF

UNIT 7 - 176 FRESHWATER POINT ROAD LEGANA 7277

DRAWING:	FLOOR	PLAN	UNIT	3	

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REVISION NUMBER DATE
REVISION 1 12 /
REVISION 2 01 /

REVISION 3 REVISION 4


REVISION 5

CALE:	1:100.		DRAWING No.:
		A3.	BM0824 - 17/20


### **FLOOR PLAN UNIT 3**

BRICK VENEER - DIMENSIONS AND AREA TO OUTSIDE CLADDING CLAD FRAME - DIMENSIONS AND AREA TO OUTSIDE OF TIMBER FRAMING. CLADDING IN ADDITION TO DIMENSIONS ALL INTERNAL DOORS ARE 820mm UNLESS OTHERWISE NOTED

AREA TABLE				
SQUARE METER BUILDING SQUARES				
FLOOR AREA	154.0	16.6		
PORTICO AREA	1.5	0.2		
TOTAL AREA	155.5	16.7		

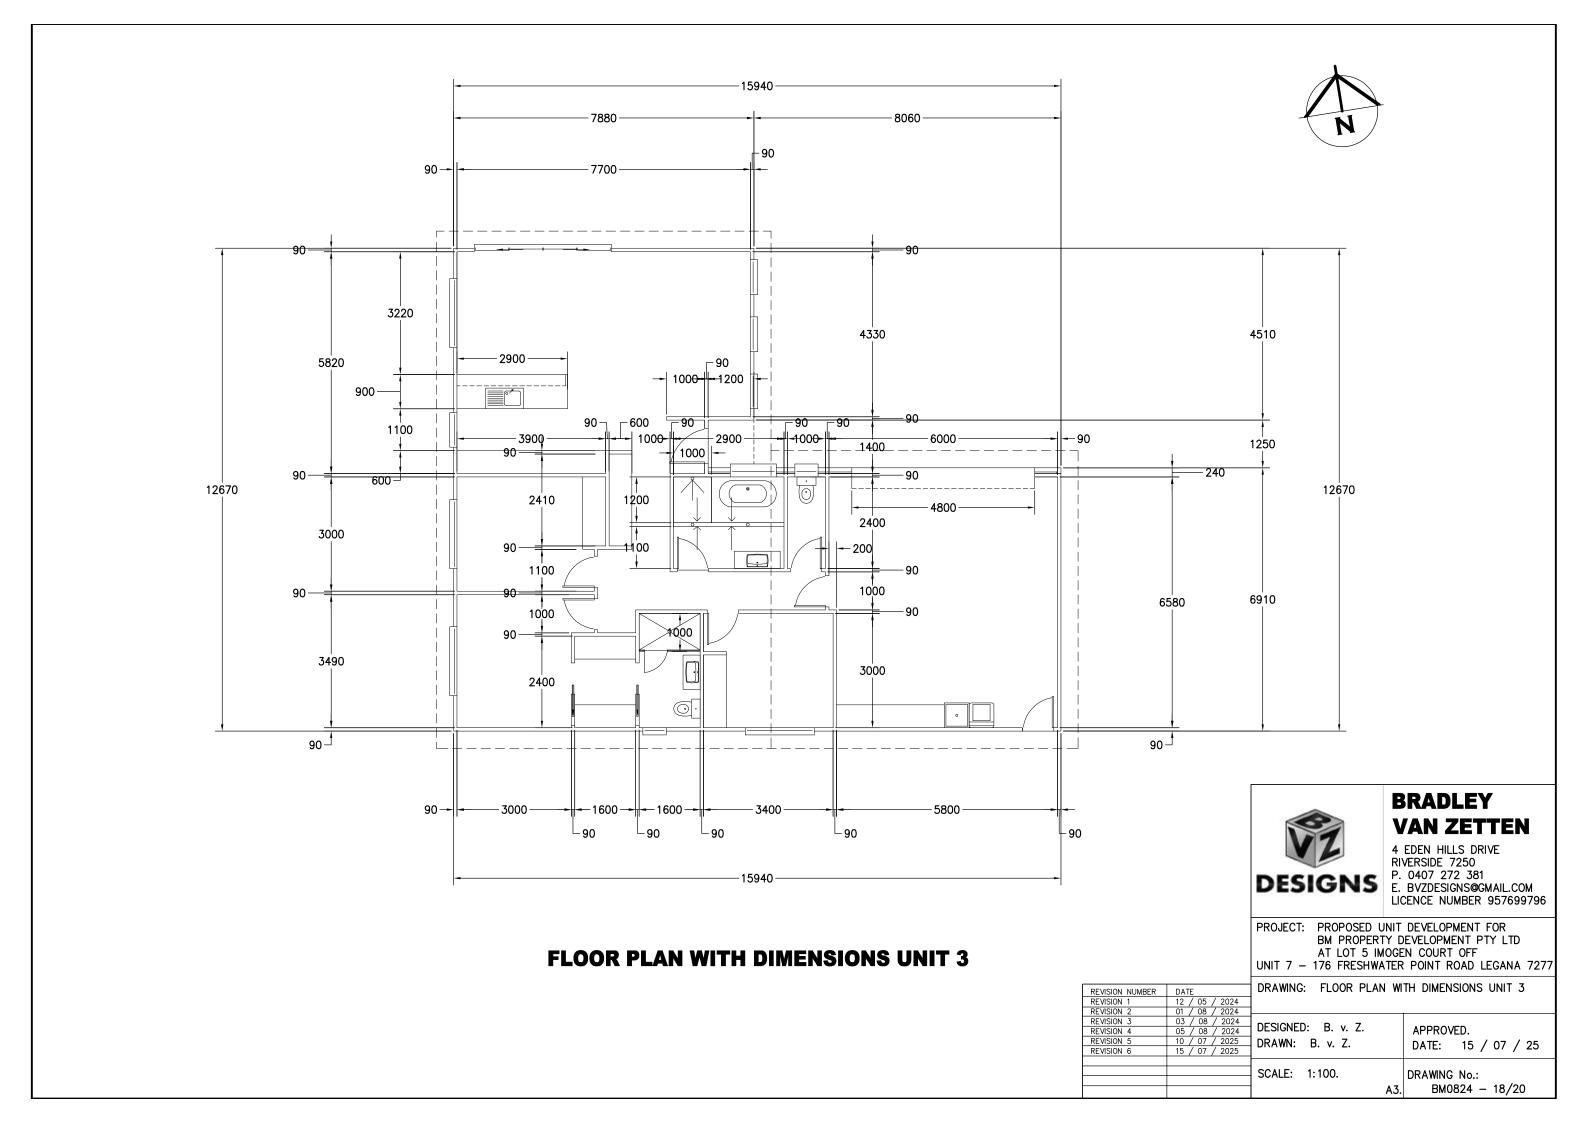



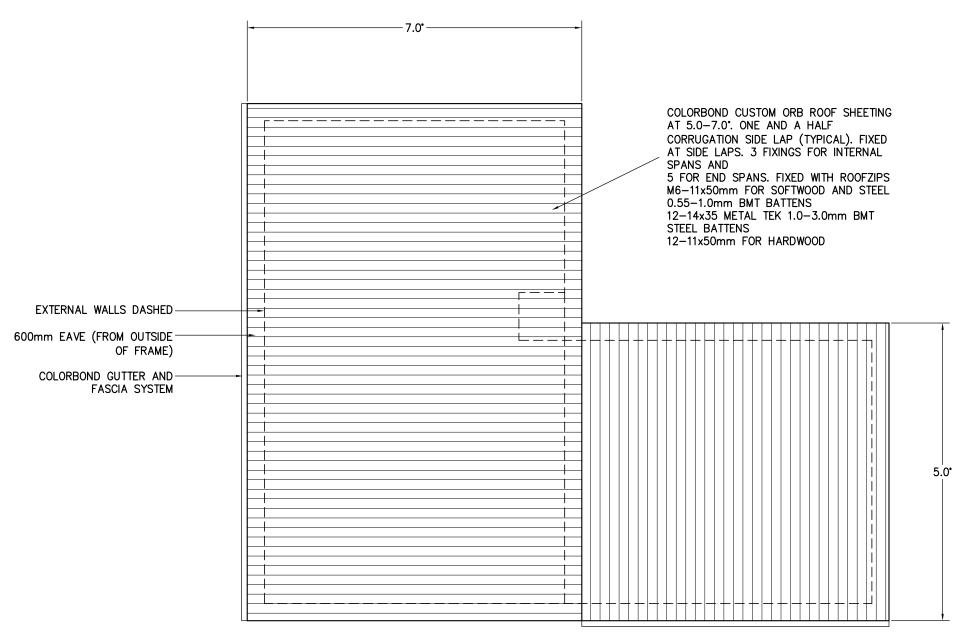

### **ROOF PLAN UNIT 3**

75x38mm HARD WOOD OR 70x35mm MGP12 BATTENS AT 900mm MAX 900mm CRS AND SPAN.

RANGEHOOD AND BATHROOM EXTRACTION FANS DUCTED TO EAVE/WALL VENT

ROOF CLADDING TO COMPLY WITH NCC PART 7.1-7.5

GUTTERS AND DOWNPIPES INSTALLED AS PER NCC PART 7.4 GUTTER MUST BE INSTALLED WITH A FALL NOT LESS THAN

• 1:500 FOR EAVES GUTTERS, UNLESS FIXED TO METAL FASCIAS

WHERE HIGH FRONTED GUTTERS ARE INSTALLED, PROVISION MUST BE MADE TO AVOID ANY OVERFLOW BACK INTO THE ROOF OR BUILDING STRUCTURE BY INCORPORATING OVERFLOW MEASURERS OR THE LIKE

DOWNPIPES MUST--

(A)NOT SERVE MORE THAN 12 M OF GUTTER LENGTH FOR EACH DOWNPIPE; AND

(B)BE LOCATED AS CLOSE AS POSSIBLE TO VALLEY GUTTERS:

(C)BE SELECTED IN ACCORDANCE WITH THE APPROPRIATE EAVES GÚTTER SECTION AS SHOWN IN TABLE 7.4.3A, TABLE 7.4.3B AND TABLE 7.4.3C.

FOR ROOF CATCHMENTS UP TO 50SQ/M PER DOWNPIPE MEDIUM RECTANGULAR GUTTERS OR 115MM 'D' GUTTERS MAY BE USED WITH 900MM DOWNPIPES

EAVE AND GUTTER OVERFLOW MEASURE TO BE INSTALLED FOR 1% ANNUAL EXCEEDANCE PROBABILITY

BOX GUTTERS AS PER AS3500.3

7.4.6 ACCEPTABLE CONTINUOUS OVERFLOW MEASURE

(1) FOR A FRONT FACE SLOTTED GUTTER WITH-

A MINIMUM SLOT OPENING AREA OF 1200 MM2 (A) PER METRE OF GUTTER; AND

(a) THE LOWER EDGE OF THE SLOTS INSTALLED A MINIMUM OF 25 MM BELOW THE TOP OF THE FASCIA.

THE ACCEPTABLE OVERFLOW CAPACITY MUST BE 0.5 L/S/M. CONSTRUCTED IN ACCORDANCE WITH FIGURE 7.4.6A.

(2) FOR A CONTROLLED BACK GAP WITH-

- (a) A PERMANENT MINIMUM 10 MM SPACER INSTALLED BETWEEN THE GUTTER BACK AND THE FASCIA; AND
- (b) ONE SPACER PER BRACKET, WITH THE SPACER NOT MORE THAN 50 MM WIDE; AND
- (c) THE BACK OF THE GUTTER INSTALLED A MINIMUM OF 10 MM BÉLOW THE TOP OF THE FASCIA.

THE ACCEPTABLE OVERFLOW CAPACITY MUST BE 1.5 L/S/M, CONSTRUCTED IN ACCORDANCE WITH FIGURE 7.4.6B.

(3) FOR THE CONTROLLED BACK GAP OPTION, THE SPACER CAN BE À PROPRIETARY CLIP OR BRACKET THAT PROVIDES THE REQUIRED OFFSET OF

THE GUTTER FROM THE FASCIA.



### **BRADLEY VAN ZETTEN**

4 EDEN HILLS DRIVE RIVERSIDE 7250 P. 0407 272 381 DESIGNS E. BYZDESIGNS@GMAIL.COM LICENCE NUMBER 957699796

APPROVED.

PROJECT: PROPOSED UNIT DEVELOPMENT FOR BM PROPERTY DEVELOPMENT PTY LTD AT LOT 5 IMOGEN COURT OFF UNIT 7 - 176 FRESHWATER POINT ROAD LEGANA 7277

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EVISION NUMBER	DATE	DRAWING:	ROOF	PLAN (	UNIT	3
EVISION 1	12 / 05 / 2024					
EVISION 2	01 / 08 / 2024					
EVISION 3	03 / 08 / 2024	DECIONED.	ъ	7		
EVISION 4	05 / 08 / 2024	DESIGNED:	B. V.	۷.	-   4	APF
EVISION 5	10 / 07 / 2025	DRAWN: B.	v 7		- 1 1	DA <sup>-</sup>
EVISION 6	15 / 07 / 2025	D	••• -•		-   '	ואט

DATE: 15 / 07 / 25

SCALE: 1:100. DRAWING No.:

BM0824 - 19/20

