**Eden Street** 

Riverside Tasmania 7250 Telephone: (03) 6323 9300 Facsimile: (03) 6323 9349



## PLANNING APPLICATION FORM

Section 57 & 58

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OFFICE USE ONLY

Application Number PA2025201

Assess No: A12302

PID No: 3199799

Applicant Name:	Dion Chellis		
Applicant Contact Name			
Postal Address:			
Contact Phone:	Home	Work	Mobile
Email Address:			

# **Planning Application Lodgement Checklist**

## The following documents have been submitted to support the consideration of this application:

- 1. A current copy of the property title text, folio plan and schedule of easements
- 2. A completed application form including a detailed description of the proposal x
- 3. A complete plan set:a) Floor plans
  - b) Elevations (from all orientations/sides and showing natural ground level and finished surface
  - c) Site Plan showing:
  - Orientation
  - All title boundaries
  - Location of buildings and structure (both existing and proposed)
  - Setbacks from all boundaries
  - Native vegetation to be removed
  - Onsite services, connections and drainage details (including sewer, water and stormwater)
  - Cut and/or Fill
  - Car parking and access details (including construction material of all trafficable areas)
  - Fence details
  - Contours
- 4. Other:



Application Number: «Application Number»

		APPLICANT DETAILS					
Applicant Name:	DION CHELLI	IS					
<b>Note:</b> Full name(	(s) of person(s)	or company making the application and postal address for correspondence.					
		LAND DETAILS					
Owner/Authority Name: (as per certificate of title)	DION CHELL	LIS					
Location / Address:	356 CLAREN	ICE POINT ROAD - CLARENCE POINT TAS 7270					
Title Reference:	TITLE REF : 1	163848/1					
Zone(s):	RURAL LIVII	NG					
Existing Development/Use:		VACANT RESIDENTIAL LAND					
Existing Developed Area:		NO CURRENT DEVELOPMENT VACANT					
E.g. Use and/or developmen	Are any of the components in this Application seeking retrospective approval?  E.g. Use and/or development that has commenced without a Planning Permit.  NO X  (If yes please specify the relevant components):						
	DE	EVELOPMENT APPLICATION DETAILS					
Proposed Use:							
Development Type:	Building work: X Demolition:  Description of development:  CLASS 1A RESIDENTIAL AND CLASS 10  NEW STEEL FRAMED 2 STOREY RESIDENTIAL HOME. NEW STEEL FRAMED SHED. NEW ACCESSWAY AND RAINWATER STORAGE						
New or Additional Area:		206M2 FOR HOUSE 288M2 FOR SHED					
Estimated construction cost proposed development:	Estimated construction cost of the \$300,000+GST						



Application Number: «Application\_Number»

Puilding Materials	Wall Type: STEEL FRAMED COLORBOND CLAD	Colour:COLORBOND BASALT
Building Materials:	Roof Type: STEEL FRAMED COLORBOND CLADDING	Colour:COLORBOND MIDNIGHT



Application Number: «Application\_Number»

		VISITOR ACCOM	INIODATION		□N/A
Gross Floor Are	ea to be used per		Number of Bedrooms to be used:		
Number of Car	parking Spaces:		Maximum Number of /isitors at a time:		
		SUBDIVISI	ON		□N/A
		300010131			
		Rounda	ry adjustment with no addit	ing additional lots	
		Bounda	Ty adjustificht with no addit		
Number of	Lots (existing):		Number of Lots (proposed):		
Description:					
If applying for	r a subdivision which c		e supply three proposed name	es for the road(s), in	order of
1.		preferer	nce:		
2.					
3.					
3.					
	COMMERCIAL, II	NDUSTRIAL OR OTHER	NON-RESIDENTIAL DEVEL	OPMENT/USE	□N/A
		Monday / Friday:		То	
Hours of Opera	ation:	Saturday:		То	
		Sunday:		То	
Existing Car Pa					
Proposed Car P	Parking:				
Number of Em	ployees:				
(Existing)					
Number of Empty (Proposed)	ployees:				
, , , , , , , ,					
Type of Machir	nery installed:				
Details of trade method of disp					
method of disp	103al.				



Application Number: «Application\_Number»

## APPLICANT DECLARATION

Owner:	As the owner of the land, I declare that the in accurate representation of the proposal and Officers to conduct inspections as required for	I consent to this application being submit	
	DION CHELLIS	Den Adde	20.06.2025
	Name (print)	Signed	Date
Applicant: (if not the owner)	As the applicant, I declare that I have notified the information contained in this application	- ·	• •
	DION CHELLIS	Then (Tiddle	20.06.2025
	Name (print)	Signed	Date
Please Note: If th	ne application involves Crown Land you will ne Minister, or a delegated officer of the C		form signed by the
Crown Consent			
(if required)	Name (print)	Signed	Date
Chief Executive			
Officer			
(if required)	Name (print)	Signed	Date
If the subje	ct site is accessed via a right of way, the owne	r of the ROW must also be notified of the	application.
Right of \	Way Owner:		
As the applicant,	I declare that I have notified the owner of the this application that w		my intent to lodge
	Name (print)	Signed	Date




## **FOLIO PLAN**

**RECORDER OF TITLES** 



Issued Pursuant to the Land Titles Act 1980

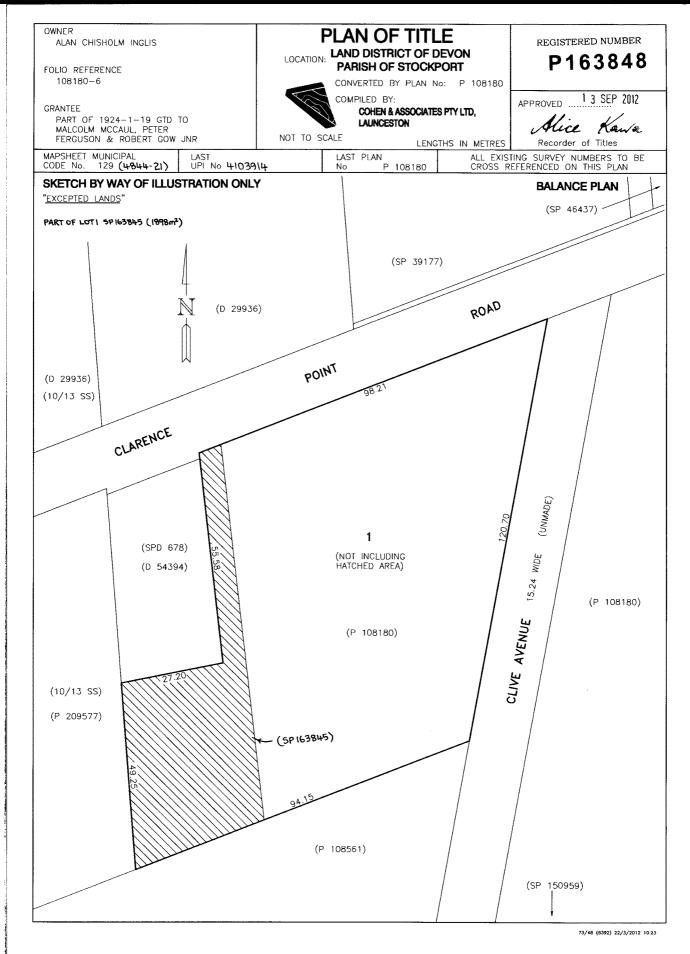

Search Date: 18 Jul 2025

Search Time: 12:24 PM

Volume Number: 163848

Revision Number: 01

Page 1 of 1

# PROPOSED NEW RESIDENCE AND SHED

356 CLARENCE POINT ROAD - CLARENCE POINT TAS 7270


TITLE REF: 163848/1 WEST TAMAR COUNCIL

# **STAGE: PLANNING PERMIT**

### DRAWING SCHEDULE Sheet Name Sheet Number A000 COVERPAGE A001 STANDARD NOTES A002 SITE ANALYSIS PLAN A003 WASTE MANAGEMENT PLAN A004 EARTHWORKS AND SEDIMENT CONTROL PLAN A005 STORMWATER AND WATE REUSE PLAN A100 SITE PLAN A101 FLOOR PLANS A102 ROOF PLAN A103 SHED PLAN A104 SHED ROOF PLAN A105 SHIPPING CONTAINER SITE PLAN A300 EXTERNAL ELEVATIONS A301 EXTERNAL ELEVATIONS A400 SECTIONS A401 SECTIONS A500 3DS A501 3DS A600 NATHERS A601 **NATHERS** A700 WINDOW AND DOOR SCHEDULE A800 NOTIFICATION PLAN A900 **BAL12.5 REQUIREMENT** A901 BAL12.5 REQUIREMENT




## ALL CONSTRUCTION TO MEET BUSHFIRE HAZARD REPORT REQUIREMENTS AND BAL12.5 FIRE RATING

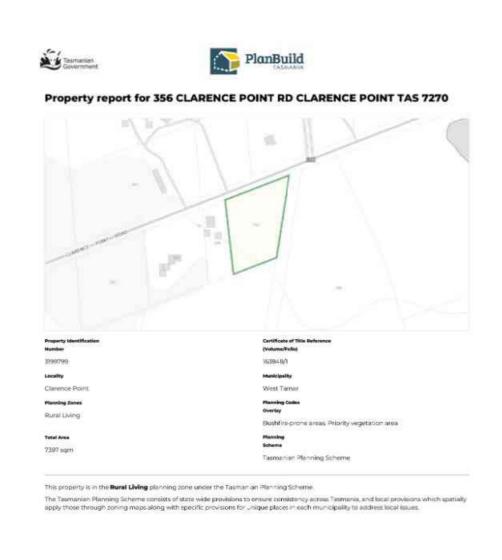


14/05/2025 1.29PM Page 1 of 4

ISSUE: 8

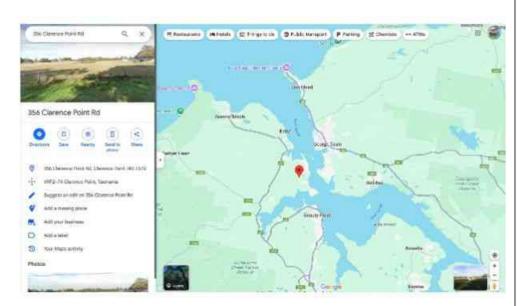

## **LOCATION MAP 01**

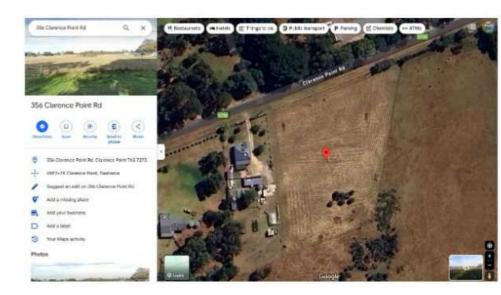

**LOCATION MAP 02** 

WEB: www.playdesignstudio.com.au

### PLANNING CERTIFICATE

SCALE:

REV: 8	DATE: 25.08.2025	CLIENT:	PLAY FOR DION CHELLIS	SHEET TITLE: COVERPAGE	DI AV DESIGN STUDIO
ISSUED BY: HW	ISSUED TO: CLIENT	ADDRESS:	356 CLARENCE POINT ROAD - CLARENCE	SHEET NUMBER: A000	LETS GET STARTED!!
DESCRIPTION OF CHANGES			POINT TAS 7270		-
			TITLE REF : 163848/1 - WEST TAMAR	JOB NUMBER: 2025023	PHONE: 0435832810
FOR APPROVALS		DRAWN: P	COUNCIL PLAY DESIGN STUDIO	DATE DRAWN: APRIL 2022	DESIGNING ACROSS NEW SOUTH WALES
		1			EMAIL: info@nloydosignoutdio.com.gu

CHECKED: PLAY

COPPOSED THE STREAMS FEMANS THE PROPERTY OF BUILDING DESIGN DRECT PTULD. IT MAY ONLY BE INSTITUTE TO THE PROPERTY OF BUILDING FOR MANON ACCORDANCE WITH THE TERMS OF BNGAGEMENT FOR THE COMMISSIONS OF THIS DRAWN OF SPROMBITED FANT DESCRIPTIONS. OF THIS DRAWN OF SPROMBITED FANT DESCRIPTIONS.



FLOOR PLAN DIMENSIONS ARE TO FRAME

INTERNAL ELEVATION DIMENSIONS ARE TO PLASTERBOARD.
THERE ARE NO ATYPICAL DESIGN FEATURES THAT PRESENT UNUSUAL WORKPLACE HEALTH & SAFETY ISSUES IN THE CONSTRUCTION, MAINTENANCE, USE, OR DEMOLITION OF THIS

ROOFING AND GUTTERS

Australian standards for roofing and gutters are primarily outlined in the

Wall Cladding). These standards ensure safe, durable, and effective

MUST COMPLY WITH Part 3.5.3 Gutters and downpipes NCC

installation of roof coverings and drainage system

National Construction Code (NCC) and relevant Australian Standards like AS/NZS 3500.3 (Plumbing and Drainage) and AS 1562.1 (Metal Roofing and

SITE & FARTHWORKS

SITE PREPARATION & BATTERS TO COMPLY WITH ENGINEER'S SPECIFICATIONS.

ALL LEVELS TO BE VERIFIED ON SITE BY CONTRACTOR.

STORMWATER FROM ROOF TO BE CONNECTED TO LEGAL POINT OF DISCHARGE AS PER SITE PLAN. WHERE DISCHARGE IS TO KERB, AN APPROVED ADAPTOR MUST BE USED.

TERMITE PROTECTION INSTALLED IN ACCORDANCE WITH AS3660.1

SLAB & FOOTINGS

CONCRETE SLAB, PIERS AND REINFORCING TO COMPLY WITH ENGINEERS DESIGN AND -VAPOUR BARRIER TO BE INSTALLED AS PER AS2870 AS PER STATE REQUIREMENTS -50mm SAND FILL LAYER TO BE PLACED BY CONCRETER PRIOR TO SLAB PREP

TIMBER FRAMING (WHEN APPLICABLE)

ALL TIMBER FRAMING TO BE IN ACCORDANCE WITH NCC H1D6 & TO COMPLY WITH AS1684.2-2021 (N2/N3/N4 WIND RATING AREAS) & AS1684.3-2021 (C1/C2 WIND RATING AREAS). PREFAB TIMBER ROOF TRUSSES @ 600mm MAX\_CENTRES TO MANUFACTURER'S ALL BRACING, FIXING & TIE DOWN REQUIREMENTS TO COMPLY WITH ENGINEER'S DESIGN AND

ALL BULKHEAD & SQ SET DEPTHS NOTED ON FLOOR PLAN ARE FINISH PLASTERBOARD

INTERNAL CEILING BATTENS INSTALLED @ 600mm CENTRES

GARAGE CEILING TO HAVE MINIMUM PERIMETER SUPPORT @ 300mm CENTRES. STEEL FRAMING (WHEN APPLICABLE)

ALL STEEL FRAMING TO BE IN ACCORDANCE WITH NCC H1P1 & TO COMPLY WITH AS4100-2020, AS4055-2021, AS1170.0-2002, AS 1170.1-2002 & AS/NZS 4600-2018.

PREFAB. STEEL ROOF TRUSSES @  $900 \, \mathrm{mm}$  CENTRES MAXIMUM WITH INTERMEDIATE CEILING

PREFAB. STEEL ROOF TRUSSES @ 600mm CENTRES FOR TILED ROOF UP TO N4 WITH INTERMEDIATE CEILING JOISTS.

PREFAB. STEEL ROOF TRUSSES @ 600mm CENTRES TO ALL RAKED CEILINGS WITH

INTERMEDIATE CEILING JOISTS.
INTERNAL & EXTERNAL TRUSS & INTERMEDIATE CEILING JOISTS ARE TO BE SPACED @ MAX 600mm CENTRES WITH INTERMEDIATE CEILING JOISTS.

INTERNAL CEILING BATTENS INSTALLED @ 600mm CENTRES WITH INTERMEDIATE CEILING

ALL BULKHEAD & SQ SETS DEPTHS NOTED ON FLOOR PLAN ARE FINISH PLASTERBOARD

GARAGE CEILING TO HAVE MINIMUM PERIMETER SUPPORT @ 300mm CENTRES.

ROOF & WALL CLADDING
BRICK VENEER WALLS TO COMPLY WITH NCC H1D1 & MUST COMPLY WITH AS4773.1, AS4773.2 &

ALL EAVE SHEETS AND FIBRE CEMENT LININGS MUST COMPLY WITH AS2908.2.

PLASTERBOARD TO BE INSTALLED TO MANUFACTURER'S SPECIFICATIONS.
ROOF AND WALL CLADDING TO BE IN ACCORDANCE WITH NCC H2D6 & MUST COMPLY WITH THE FOLLOWING STANDARD WHEN APPLICABLE (SHEET ROOF: AS1562.1 / ROOF TILING: AS2050 /

AAC:AS5146.1 / HARDBOARD:AS1859.4).
ALL FLASHINGS MUST COMPLY WITH AS2904.

ALL SARKING MUST COMPLY WITH AS4200.1

GLAZING
WINDOWS TO COMPLY WITH NCC H5P2 & PART 11.3.7 & 11.3.8 OF THE ABCB HOUSING PROVISIONS.
GLAZING TO BE IN ACCORDANCE WITH NCC H1D8 & MUST COMPLY WITH AS1288 & AS2047.

WATER PROOFING

WATER PROOFING IS TO BE IN ACCORDANCE WITH NCC H4D1 & PART 10.2 OF THE ABCB HOUSING PROVISIONS

WHERE FLOOR WASTES ARE PROVIDED, FLOOR GRADES ARE MINIMUM 1:80 AND MAXIMUM 1:50 IN ACCORDANCE WITH PART 10.2.12 OF THE ABCB HOUSING PROVISIONS OR RELEVANT PERFORMANCE SOLUTION.

EXTERNAL WATERPROOFING TO BE IN ACCORDANCE WITH NCC PART H2D8 & MUST COMPLY WITH AS4654 1 & AS4654 2

TILED WET AREA FLOORS AND SHOWER FLOORS WHERE A 'FLOOR WASTE' IS REQUIRED, WILL GENERALLY REQUIRE TILES TO BE DIAGONALLY CUT TO ACHIEVE COMPLIANT FALLS

CONDENSATION MANAGEMENT AND VENTILATION

EXHAUST FAN TO WC (WHEN APPLICABLE) TO COMPLY WITH NCC H4D9 & AS1668.2. EXHAUST FANS, RANGEHOODS, COMBINATION EXHAUST FANS ARE DUCTED EXTERNALLY AT A MINIMUM RATE IN ACCORDANCE WITH NCC H4P7 & PART 10.8 OF THE ABCB HOUSING PROVISIONS.

BATHROOMS OR SANITARY COMPARTMENTS WITHOUT NATURAL VENTILATION TO HAVE 10 MINUTE RUN ON TIMER LINKED TO LIGHT SWITCH.

ANY ROOM THAT DOES NOT MEETING NATURAL VENTILATION REQUIREMENTS MUST BE PROVIDED WITH MAKE-UP AIR FROM AN ADJACENT ROOM IN ACCORDANCE WITH AS 1668.2. WET AREAS WITHOUT SUFFICIENT NATURAL VENTILATION MUST HAVE A MINIMUM 20MM GAP TO

THE UNDERSIDE OF THE DOOR TO ACHIEVE COMPLIANT VENTILATION. STAIRS & BALUSTRADE (WHEN APPLICABLE)

ALL STAIRS, BARRIERS, BALUSTRADES & HANDRAILS TO BE IN ACCORDANCE WITH NCC H5 & PART 11.2 & 11.3 OF THE ABCB HOUSING PROVISIONS & MUST COMPLY WITH AS1170.1 & AS4586. OTHER

PASSAGE DOORS TO SANITARY COMPARTMENTS TO BE IN ACCORDANCE WITH NCC H4F3 PART 10.4.2 OF THE ABCB HOUSING PROVISIONS

BUILT TO BOUNDARY WALLS TO BE BUILT IN ACCORDANCE WITH NCC H3D1 AND PARTS 9.1 TO 9.3 OF THE ABCB HOUSING PROVISIONS & AS1530. SEPARATING & EXTERNAL WALLS TO BE BUILT TO FRL 60/60/60 (WHERE APPLICABLE). PROVIDE MINIMUM 115mm SLOTTED GUTTER TO SUIT MAX 40m2 OF ROOF AREA PER

DOWNPIPE SMOKE ALARMS INSTALLED IN ACCORDANCE WITH NCC H3D6 & PART 9.5 OF THE ABCB HOUSING PROVISIONS & MUST COMPLY WITH AS3786 & AS1670.1.

FLUES FOR ALL FIREPLACES & HEATERS (WHERE APPLICABLE) ARE TO BE INSTALLED TO MANUFACTURER'S SPECIFICATIONS AND PART 12.4 OF THE ABCB HOUSING PROVISIONS.

SITE COVERAGE

SITE AREA: 8242M2

SITE COVERAGE CONTAINERS ONLY

60M2 = 0.7% SITE COVERAGE

SITE COVERAGE CONTAINERS AND HOUSE/SHED

495M2 = 6.0% SITE COVERAGE

CONTAINERS USED FOR STORAGE ONLY TO BE REMOVED AFTER HOUSE OCCUPATION CERTIFICATE ISSUED

**BAL12.5 CONSTRUCTION** 

DATE: 25.08.2025 PLAY FOR DION CHELLIS REV: 8 CLIENT: SHEET TITLE: STANDARD NOTES AY DESIGN STUDIO
LETS GET STARTED!! ISSUED TO: CLIENT ISSUED BY: HW 356 CLARENCE POINT ROAD - CLARENCE ADDRESS: SHEET NUMBER: A001 POINT TAS 7270 DESCRIPTION OF CHANGES TITLE REF: 163848/1 - WEST TAMAR JOB NUMBER: 2025023 PHONE: 0435832810 FOR APPROVALS DRAWN: PLAY DESIGN STUDIO DESIGNING ACROSS NEW SOUTH WALES DATE DRAWN: APRIL 2022 EMAIL: info@playdesignsutdio.com.au CHECKED: PLAY SCALE: 1:100 ISSUE: 8 WEB: www.playdesignstudio.com.au

AND IN ACCORDANCE WITH THE TERMS OF ENGAGEMENT FOR




# WEATHER BY MONTH // WEATHER AVERAGES LAUNCESTON

	January	February	March	April	May	June	July	August	September	October	November	December
Avg. Temperature °C (°F)	16.9 °C	16.6 °C	14.8 °C	11.6 °C	8.9 °C	7 °C	6.5 °C	7.1 °C	8.7 °C	10.6 °C	13.2 °C	15.1 °C
	(62.5) °F	(61.9) °F	(58.6) °F	(52.8) °F	(48.1) °F	(44.6) °F	(43.6) °F	(44.7) °F	(47.6) °F	(51.1) °F	(55.7) °F	(59.1) °F
Min. Temperature °C (°F)	11.6 °C	11.7 °C	10.1 °C	7.4 °C	5.4 °C	3.7 °C	3.1 °C	3.4 °C	4.5 °C	5.9 °C	8.3 °C	9.9 °C
	(52.9) °F	(53.1) °F	(50.1) °F	(45.3) °F	(41.6) °F	(38.6) °F	(37.5) °F	(38.1) °F	(40.1) °F	(42.7) °F	(47) °F	(49.9) °F
Max. Temperature °C (°F)	22.6 °C	22 °C	20.1 °C	16.4 °C	13.2 °C	11 °C	10.5 °C	11.4 °C	13.3 °C	15.6 °C	18.3 °C	20.4 °C
	(72.7) °F	(71.6) °F	(68.2) °F	(61.5) °F	(55.8) °F	(51.8) °F	(50.9) °F	(52.5) °F	(56) °F	(60) °F	(64.9) °F	(68.7) °F
Precipitation / Rainfall	54	49	49	53	62	65	81	86	80	67	64	60
mm (in)	(2)	(1)	(1)	(2)	(2)	(2)	(3)	(3)	(3)	(2)	(2)	(2)
Humidity(%)	63%	68%	71%	77%	83%	88%	86%	84%	79%	74%	71%	66%
Rainy days (d)	5	5	5	5	6	7	8	8	9	8	8	6
avg. Sun hours (hours)	9.6	8.0	6.9	5.6	4.9	4.3	4.4	4.9	5.9	7.0	7.9	9.2



<>

## LAUNCESTON WEATHER INFORNMATION

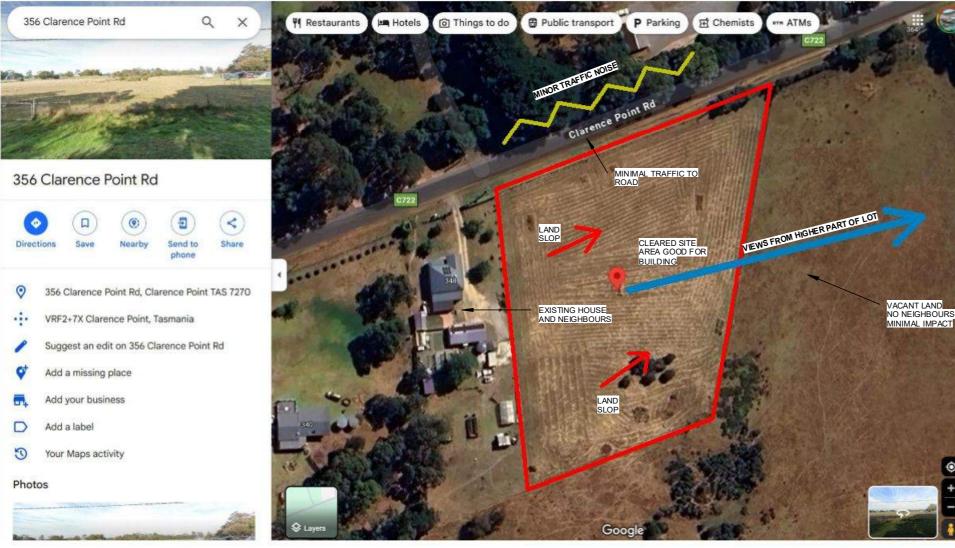

### 356 CLARENCE POINT ROAD - CLARENCE POINT TAS 7270 TITLE REF: 163848/1 BAL12.5 CONSTRUCTION SITE DETAILS BUSHFIRE ATTACK LEVEL = BAL 12.5 WEST TAMAR COUNCIL AREA RURAL LIVING ZONING SITE AREA 7397M2 PROPOSED FLOOR AREA s HOUSE LEVEL 01 HOUSE LEVEL 02 HOUSE DECKS SHED = 150M2 = 56M2 = 288M2 ROOF AREA ENTER ROOF AREA =296M2 HOUSE =291M2 SHED CONDITIONED FLOOR SPACE =191M2 UN CONDITIONED FLOOR SPACE =15M2 LANDSCAPE AREA ENTER LANDSCAPE AREA =200M2 AREA INCLUDES DRIVEWAYS AND FOOTPATHS HARD LANDSCAPE AREA PROPOSED SITE COVERAGE BUILDING FOOTPRINT + DRIVEWAY+FOOTPATHS-DECKS PROPOSED ESR FLOOR SPACE RATIO - TOTAL LIVING AREA DIVIDED BY SITE AREA 0.027 to 1 LIVING/SITEX100 MAX. BUILDING HEIGHT 7M ABOVE FFL 7.5M ABOVE FGL



(CHECK GEOTECH REPORT)

N3 (CHECK WINDSPEED)

T0 / CATEGORY 01 /

NO SHIELDING

SOIL CLASSIFICATION

WIND SPEED
TERRAIN CATEGORY

REGION

SHIELDING



SITE PHOTOGRAPHS


**FOR APPROVALS** 

REV: 8	DATE: 25.08.2025	CLIENT: PLAY FOR DION CHELLIS	SHEET TITLE: SITE ANALYSIS PLAN	DI AV DESIGN STUDIO
ISSUED BY: HW	ISSUED TO: CLIENT	ADDRESS: 356 CLARENCE POINT ROAD - CLAI	RENCE SHEET NUMBER: A002	LAT LETS GET STARTED!!
DESCRIPTION OF CHANG	ES	POINT TAS 7270 TITLE REF : 163848/1 - WEST TAMA	JOB NUMBER: 2025023	PHONE: 0435832810
FOR APPROVALS		DRAWN: PLAY DESIGN STUDIO	DATE DRAWN: APRIL 2022	DESIGNING ACROSS NEW SOUTH WALES
		CHECKED: PLAY	SCALE: 1:100   ISSUE: 8	EMAIL: info@playdesignsutdio.com.au

THIS DRAWNO REMANS THE PROPERTY OF BULDING DESIGN DRECT PTVLTD. IT MAY ONLY BE LIST OF THE PLIBOYER FOR WHICH IT WAS COMMISSIONED WHICH IT WAS COMMISSIONED THE PROPERTY OF THE COMMISSION THE COMMISSION. IN AN ITTORISET HIS FOR THE DRAWNO IS PROHIBITED FAMTUS SOPREMISSION DRAWNOG SEPROHETED OF THE COMMISSION.

FAMTUS SOPREMISSION DRAWNOG PLEASE CONTACT BOO DRAWNOG PLANG PLA



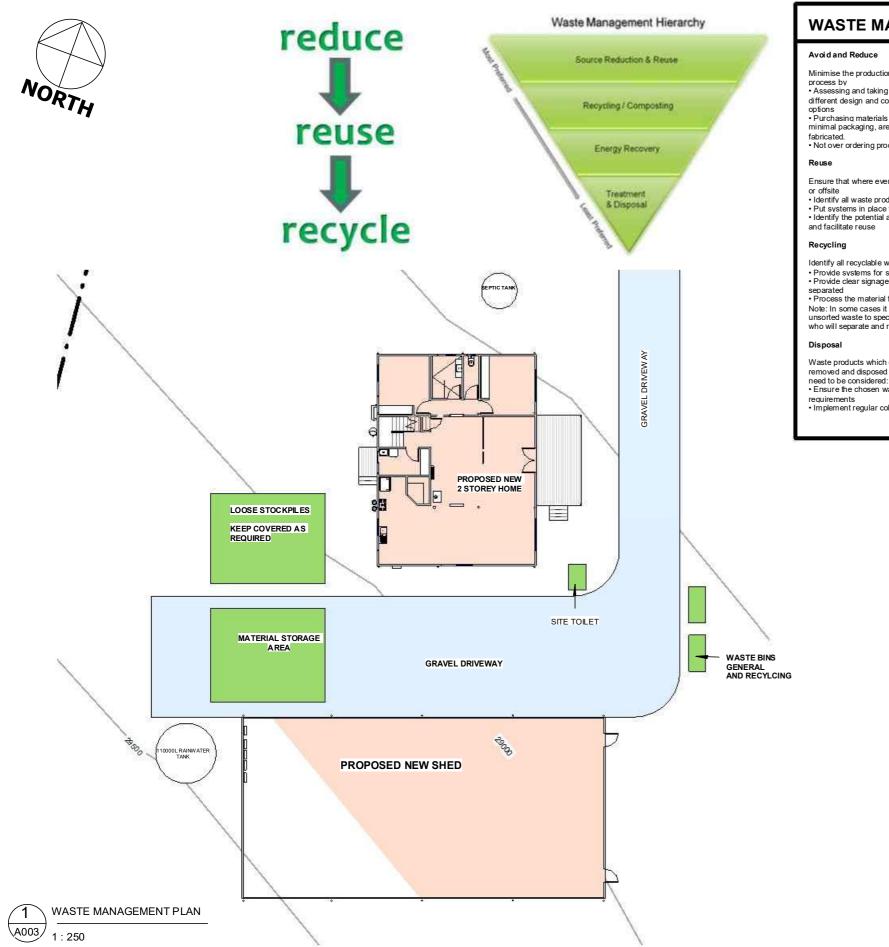

## **WASTE MANAGEMENT STRATEGY**

### Avoid and Reduce

Minimise the production of waste materials in the construction

- process by Assessing and taking into consideration the resultant waste from different design and construction
- options
   Purchasing materials that will result in less waste, which have minimal packaging, are pre-cut or
- Not over ordering products and materials

Ensure that where ever possible, materials are reused either on site

- Identify all waste products that can be reused
- Put systems in place to separate and store reusable items
- · Identify the potential applications for reuse both onsite and offsite and facilitate reuse

Identify all recyclable waste products to be produced on site

- Provide systems for separating and stockpiling of recyclables
   Provide clear signage to ensure recyclable materials are
- separated Process the material for recycling either onsite or offsite
- Note: In some cases it may be more economical to send the unsorted waste to specialised waste contractors who will separate and recycle materials at an offsite location.

Waste products which cannot be reused or recycled will be removed and disposed of. The following will

- Ensure the chosen waste disposal contractor complies with OEH
- Implement regular collection of bins

# WASTE MANAGEMENT BAL12.5 CONSTRUCTION

### GENERAL WASTE

ALL GENERAL WASTE TO BE STORED IN A SECURE BIN AREA ON SITE . WASTE TO COVERED AND SECURED AS NOT TO ALLOW WASTE TO BLOW OUT OF BIN AND STOP ANIMALS SCAVAGING WASTE BIN TO BE BEHIND SECURE FENCE OR TEMPORARY CONSTRUCTION FENCE. BIN TO BE LOCATED IN EASILY ACCESSIBLE LOCATION FOR WASTE COLLECTION TRUCK OR CONTRACTOR TO ACCESS

### RECYCABLE WASTE

- ALL RECYCLABLE REUSEABLE MATERIALS INLCUDING EXCESS FRAMING TIMBER LENGTHS
- CLADDING SHEETS
- FLASHINGS WINDOWS AND DOORS
- ROOF SHEETS - FITTINGS AND HARDWARE
- DECKING

TO BE TAKEN BY BUILDER TO BE REUSED ON OTHER PROJECTS OR STORED AT THE BUILDERS WORKSHOP FOR FUTURE USE

ADDITIONAL RECYCABLE OR REUSEABLE WASTE TO BE STORED ON SITE IF OWNER/BUILDER AGREE TO THE MATTER

### STOCK PILES

ALL STOCKPILES TO BE LOCATED SECURELY BEHIND THE BUILDING LINE OR SITE FENCING. ALL LOOSE STOCKPILES TO BE SECURELY COVERED IF REQUIRED TO PREVENT DUST AND MATERIAL LEAVING SITE

STOCKPILES TO BE LOCATED IN ACCESSIBLE LOCATION FOR EASE OF DELIVERY AND COLLECTION

### HAZARDARDOUS WASTE

ALL HAZARDARDOUS MATERIAL TO BE REMOVED FROM SITE BY A FULLY QUALIFIED PERSON/COMPANY ACCORDING TO ALL RELEVANT AUSTRALIAN STANDARDS, BCA REQUIREMENTS AND LOCAL AUTHORITY REQUIREMENTS.

HAZARDARDOUS WASTE TO BE REMOVED ACCORDING TO ANY RELEVANT HAZARDARDOUS

IF ANY UNKNOWN HAZARDARDOUS WASTE IS FOUND ON SITE ALL WORK MUST STOP IMMEDIATELY AND BUILDER NOTIFIED - AWAIT INSTRUCTION

### ONSITE TOILET

AN ONSITE TOILET IS TO BE PROVIDED . TOILET LOCATED IN A SECURE LOCATION BEHIND THE

TOILET TO BE MAINTAINED IN HYGENIC MANNER BY ALL PERSONS USING IT

ADVISE BUILDER OF ANY ISSUES

### **FENCING**

SECURE SITE FENCING TO BE PROVIDED ON SITE AND MAINTAINED IN A SAFE AND SECURE

ALL RELEVANT SAFETY SIGNAGE TO BE PLACED ON FENCE AT ENTRY

SITE TO BE FULLY SECURE ON ALL SIDES

ALL RELEVANT CONTACT NUMBERS AND APPROVALS TO BE LOCATED ON FRONT OF SITE

LOCAKBLE AND SECURE ENTRY GATE TO BE PROVIDED ON SITE

DATE: 25.08.2025 PLAY FOR DION CHELLIS AY DESIGN STUDIO REV: 8 CLIENT: SHEET TITLE: WASTE MANAGEMENT PLAN ISSUED BY: HW ISSUED TO: CLIENT LETS GET STARTED!! 356 CLARENCE POINT ROAD - CLARENCE ADDRESS: SHEET NUMBER: A003 POINT TAS 7270 DESCRIPTION OF CHANGES TITLE REF: 163848/1 - WEST TAMAR JOB NUMBER: 2025023 PHONE: 0435832810 FOR APPROVALS DRAWN: PLAY DESIGN STUDIO DESIGNING ACROSS NEW SOUTH WALES DATE DRAWN: APRIL 2022 EMAIL: info@playdesignsutdio.com.au CHECKED: PLAY SCALE: As indicated ISSUE: 8 WEB: www.playdesignstudio.com.au

AND IN ACCORDANCE WITH THE TERMS OF ENGAGEMENT FOR



# SEDIMENT CONTROL FENCING SEPTIC TANK 5500 10500 HOUSE ON BEARERS AND JOISTS - BORED PIERS NO MAJOR EXCAVATION REQUIRED 29450 4557 BATTERED BANK GRAVEL ROAD CONFIRM FILL TO SUIT GRAVEL TURNING AREA **CUT 412M2 CUT 412M2** WATER TANK 29300 FSL CONCRETE SLAB Poor SEDIMENT CONTROL FENCING 3000 BAT BATTERED BANK BATTERED BANK 24000

# EARTHWORK BAL 12.5 CONSTRUCTION

CONTACT DIA BEFORE YOU DIG PRIOR TO ANY EARTHWORKS ON SITE

- ANY CONTRACTORS WORKING ON SITE UNDERTAKING EXCAVATIONS TO REQUEST DIAL BEFORE DIG PLAN BEFORE PROCEEDING WITH WORKS

WORKS
- ALL CONTRACTORS WORKING ON SITE UNDERTAKING EXCAVATIONS
TO REQUEST BRIEFING ON SERVICES LOCATION FROM SITE FOREMAN
OR LEADING HAND PRIOR TO STARTING ANY WORK
- SEDIMENT CONTROL FENCING TO LOCAL AUTHORITY ENGINEERING
STANDARDS TO BE ERECTED PRIOR TO ANYTH EARTHWORKS ON

- EARTHWORKS TO BE HOSED DOWN AS REQUIRED DEPENDING ON NIEGHBOURS REQUIREMENTS/PROXIMITY AND WEATHER

ON NIEGHBOURS REQUIREMENTS PROXIMITY AND WEATHER CONDITIONS

- ALL EARTHWORKS TO BE COMPLETED IN ACCORDANCE WITH THE EARTHWORKS AND SED MENT CONTROL PLAN


- IF ANY UNFORESEEN SERVICES ARE FOUND ON SITE EXCAVATION MUST CEASE AND CAN ONLY START WITH PERMISSION FROM SITE

MUSI CEASE AND CAN ONLY START WITH PERMISSION FROM SITE FOREMAN OR LEADINING HAND AFTER CONFIRMATION OF SERVICES AND ANY ADDITIONAL REQUIREMENTS
- EARTHWORKS ARE NOT TO EFFECT THE AMNENITY OF THE SURROUNDING PROPERTIES PUBLIC/PRIVATE LAND
- ALL EXCAVATION AREAS TO BE FENCED AND SECURED AS REQUIRED


BY LOCAL GOVERNMENT REQUIREMENTS
- ALL LOOSE STOCKPILES TO BE COVERED IF REQUIRED DO TO WEATHER AND WIND ISSUES

### LANDSCAPE FALLS

ALL LANDSCAPING TO FALL AWAY FROM RAINWATER TANK AND FLOOR SLAB EDGE. DO NOT LANDSCAPE TO FLOOR LEVEL. STORMWATER SURGE PITS TO BE LOCATED WHERE POSSIBLE AWAY FROM HOUSE AND TO FALL AWAY FROM HOUSE TO STREET OR DESIGNATED STORMWATER PIT

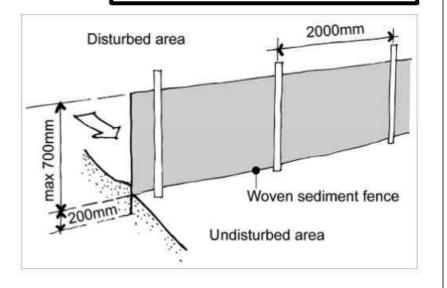

### SEDIMENT FENCING

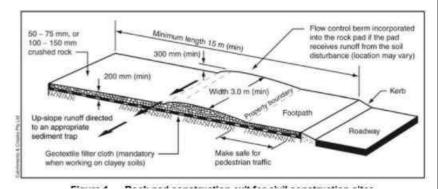

STABLISED SITE ENTRY DETAIL


# **FOR APPROVALS**

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REV: 8	DATE: 25.08.2025	CLIENT:	PLAY FOR DION CHELLIS	SHEET TITLE: EARTHWORKS	AND SEDIMENT CONTROL PLAN	DI AVDESIGN STUDIO
ISSUED BY: HW	ISSUED TO: CLIENT	ADDRESS:	356 CLARENCE POINT ROAD - CLARENCE	SHEET NUMBER: A004		LAY LETS GET STARTED!!
DESCRIPTION OF CHANGES		-	POINT TAS 7270 TITLE REF : 163848/1 - WEST TAMAR	JOB NUMBER: 2025023		PHONE: 0435832810
FOR APPROVALS		DRAWN: F	COUNCIL PLAY DESIGN STUDIO	DATE DRAWN: APRIL 2022		DESIGNING ACROSS NEW SOUTH WALES
		CHECKED:	PLAY	SCALE: As indicated		EMAIL: info@playdesignsutdio.com.au WEB: www.playdesignstudio.com.au

**EARTHWORKS PLAN** 

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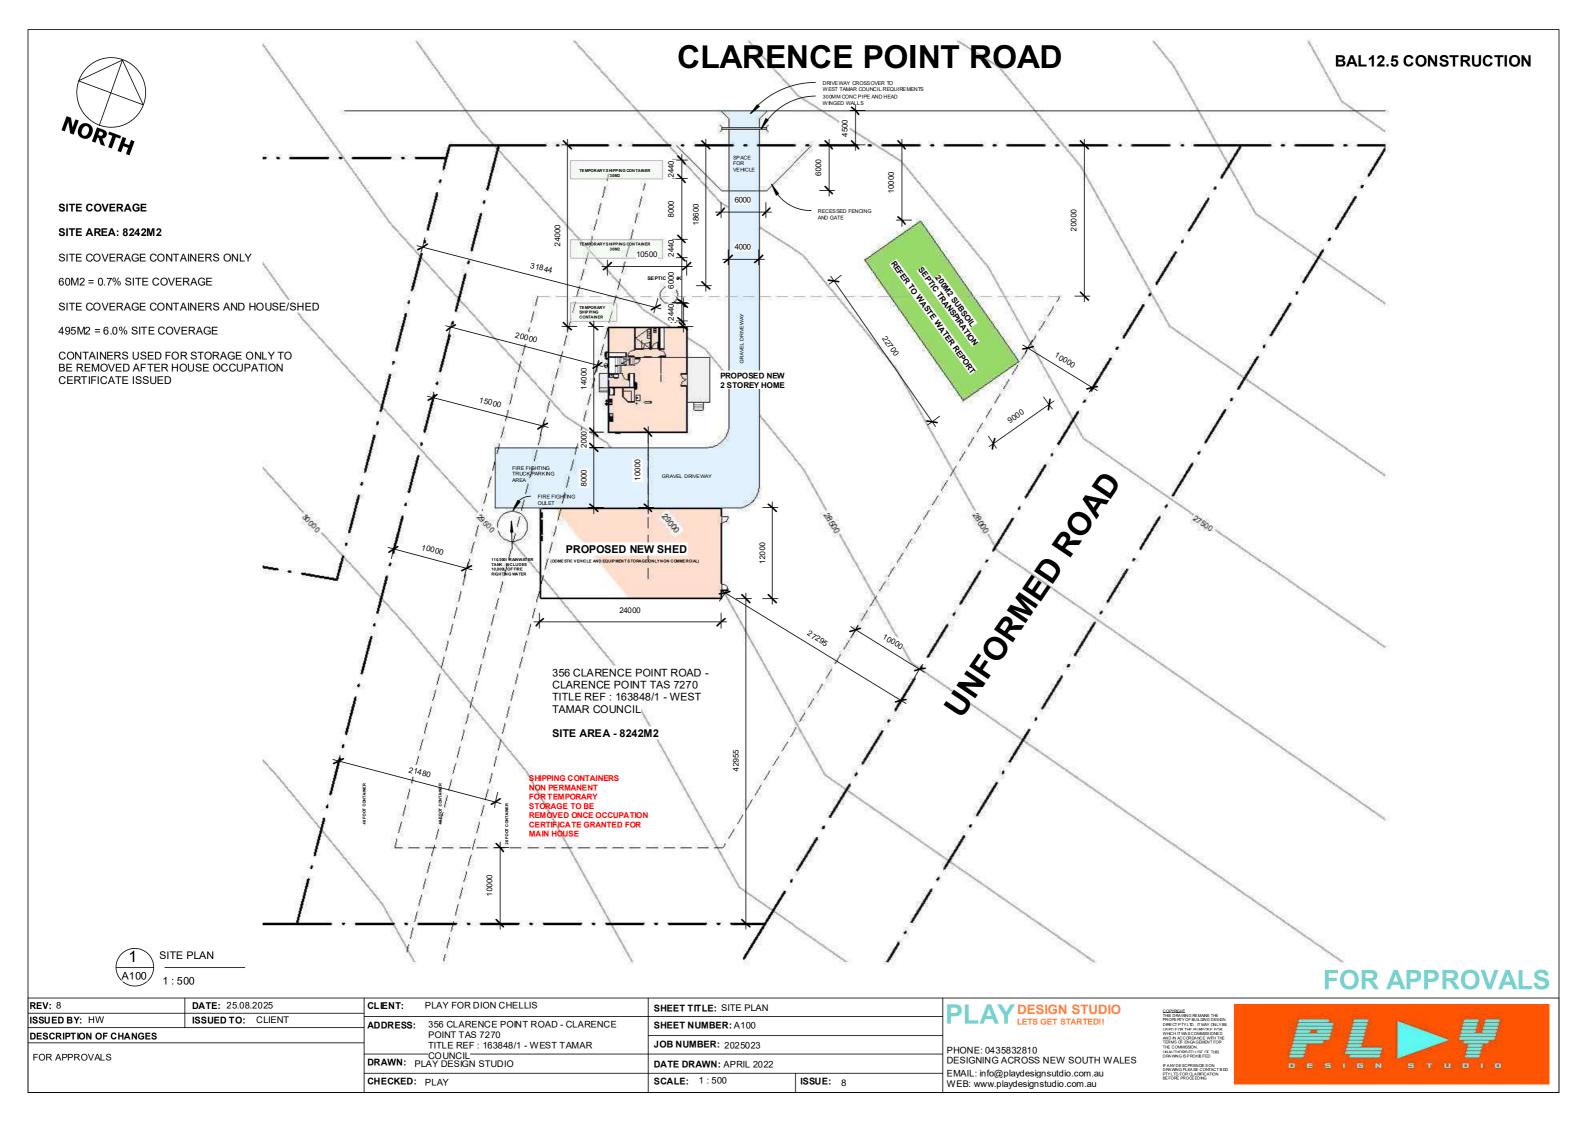



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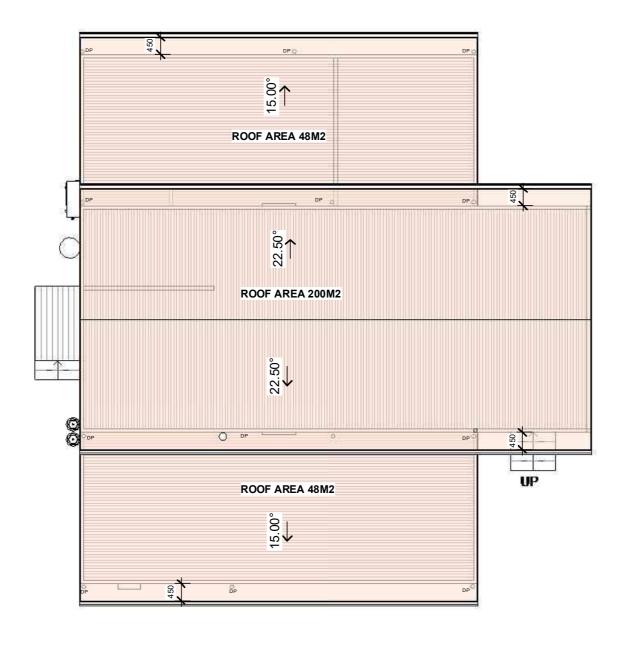
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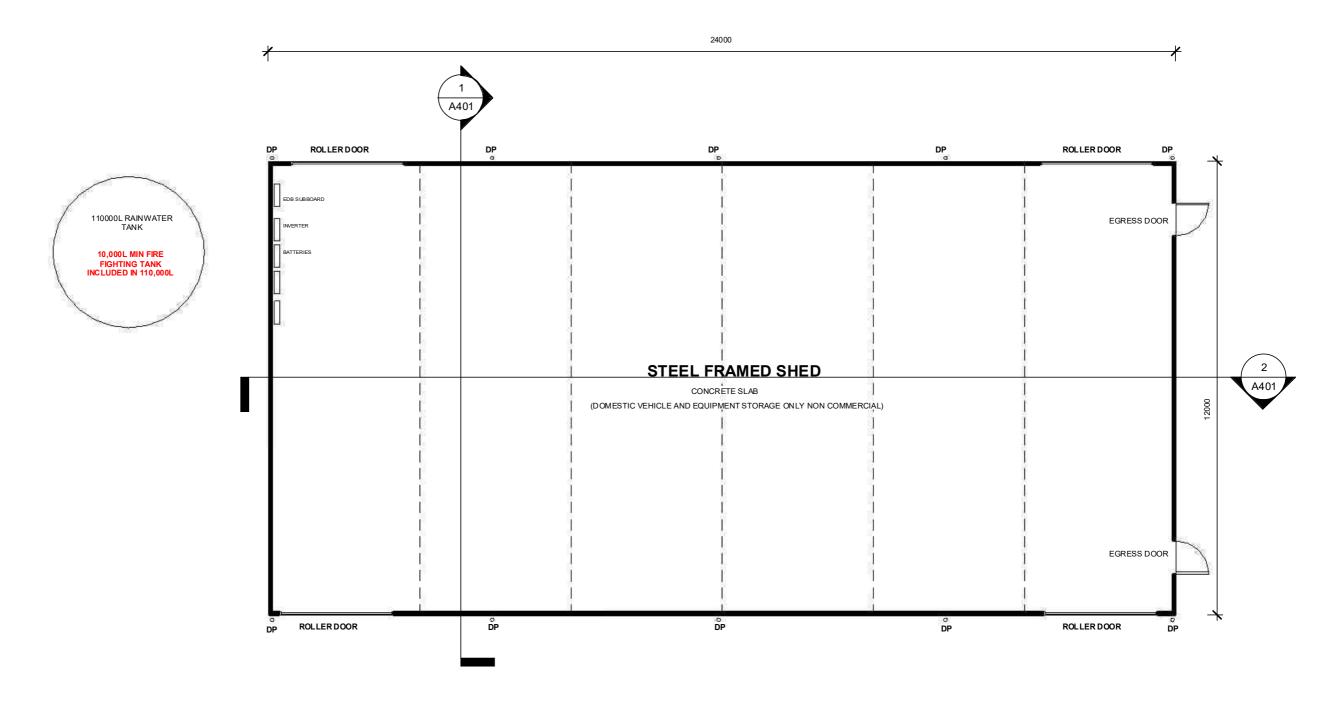

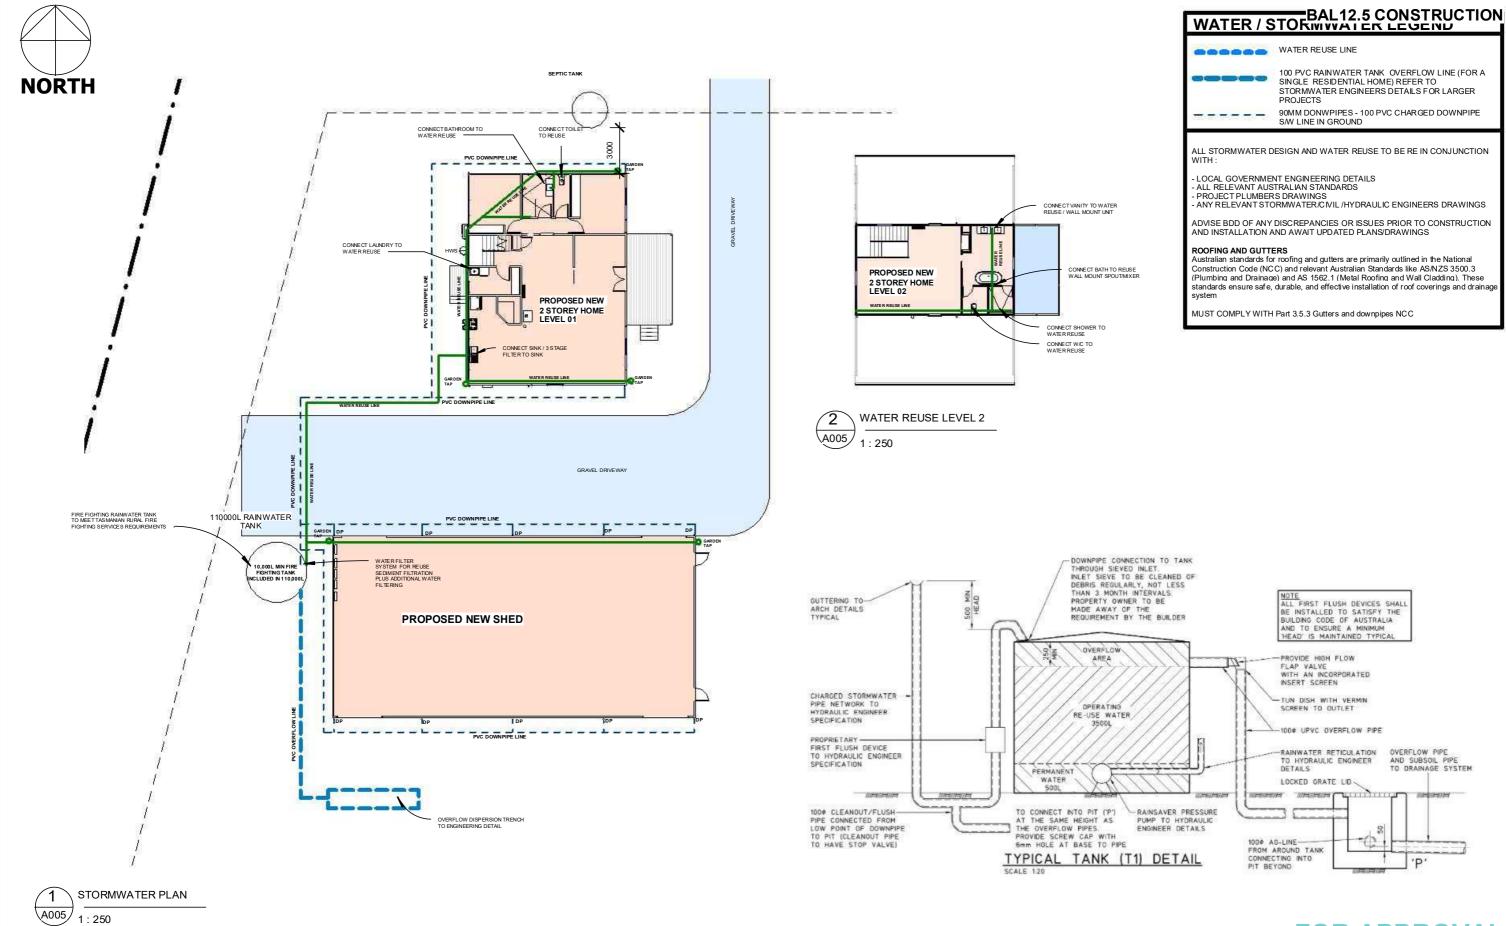
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		CHECKED	: PLAY	SCALE: 1:100	ISSUE: 8	WFB: www.playdesignstudio.com.au	BEFORE PROCEEDING







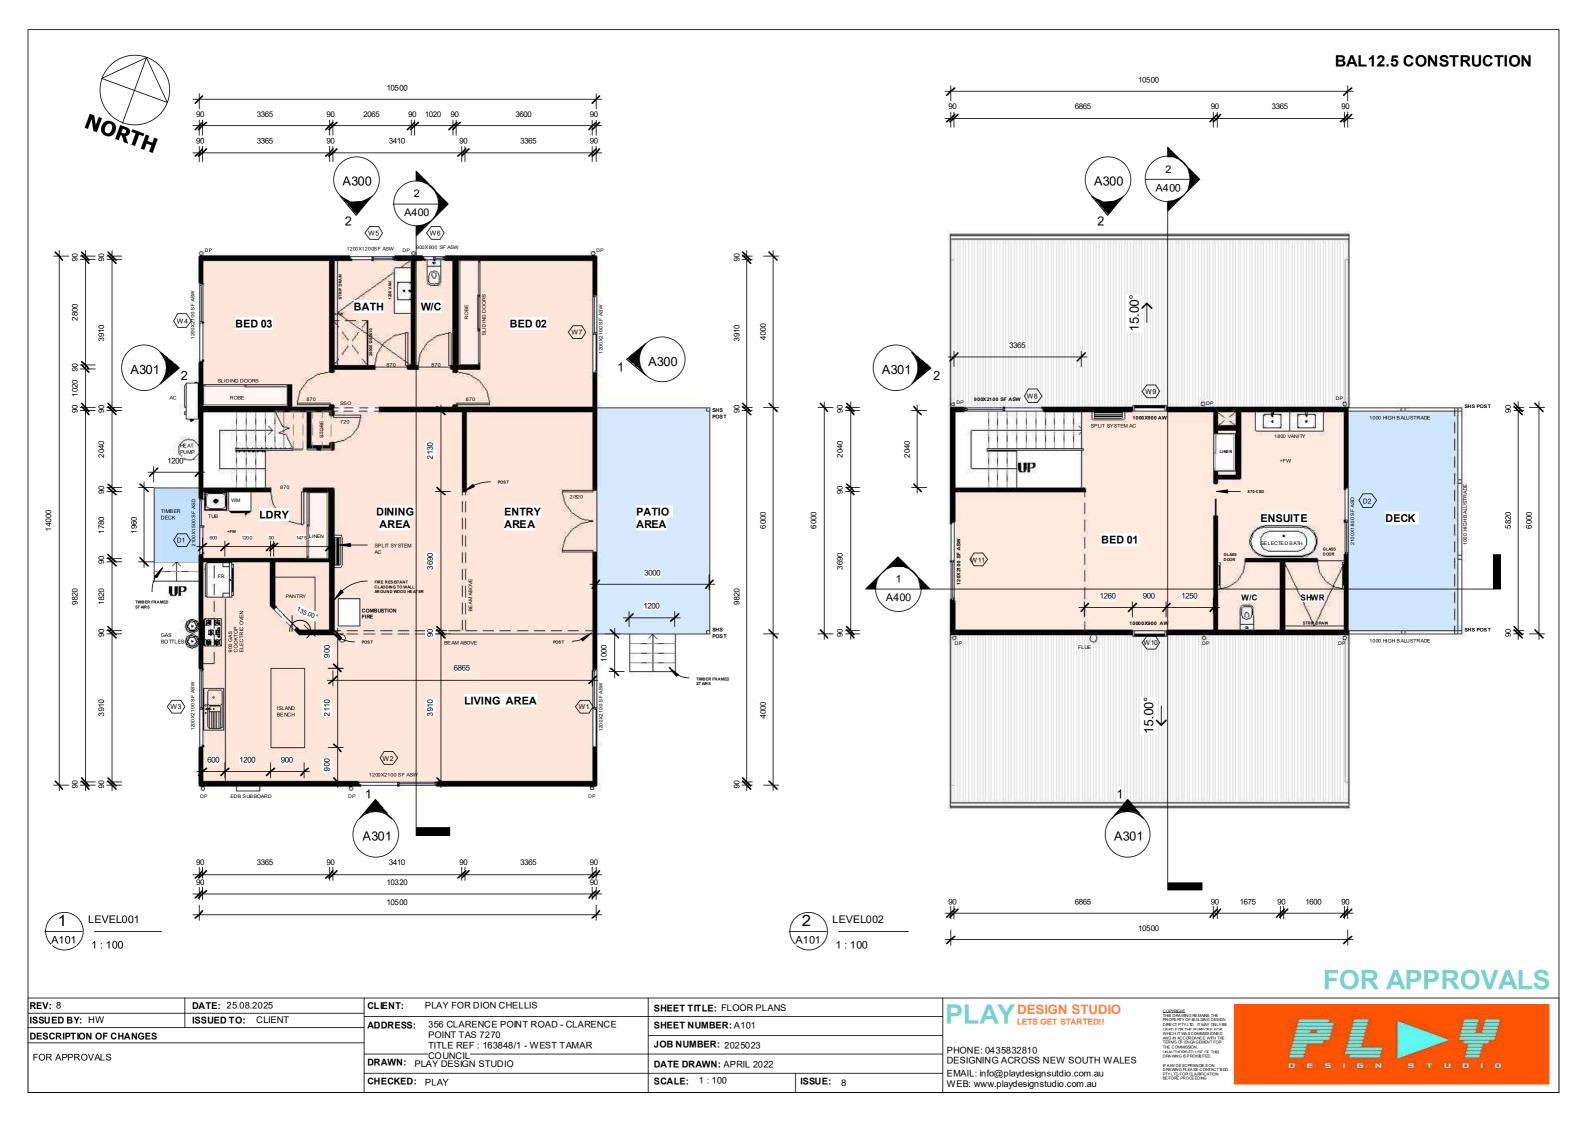


1 SHED PLAN 1:100

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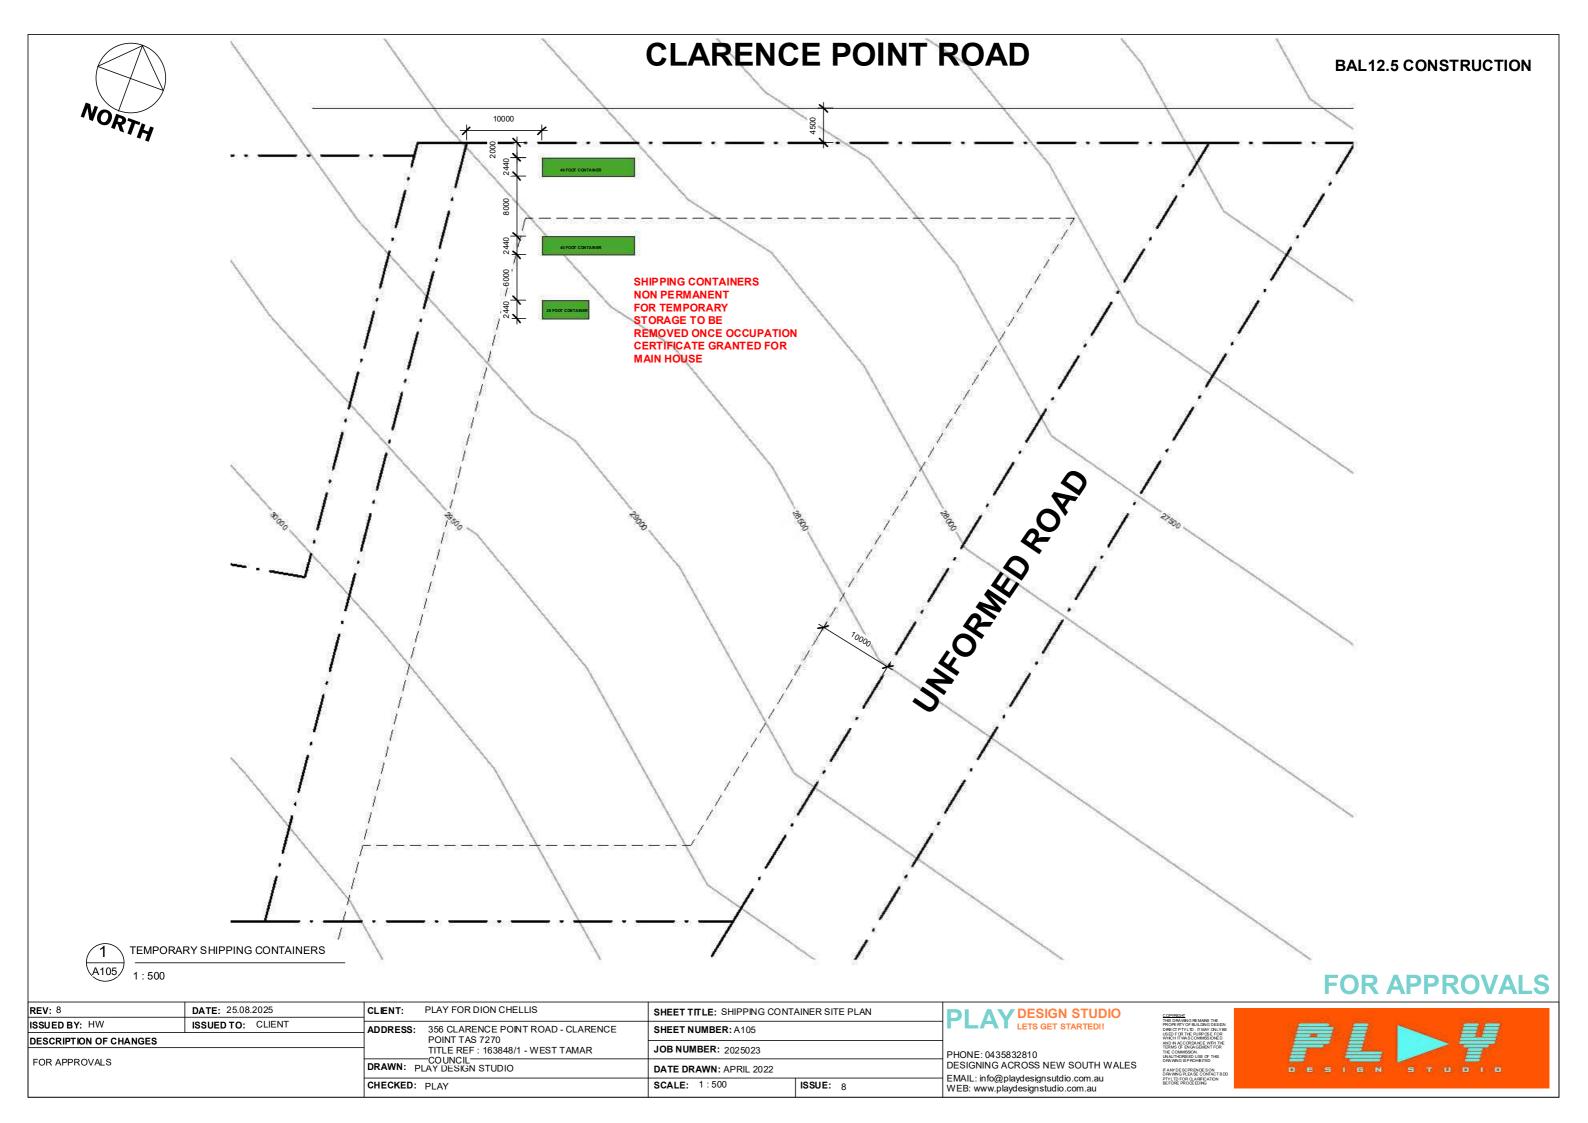
110000L RAINWATER
TANK

10,000L MIN FIRE
FIGHTING TANK
INCLUDED IN 110,000L



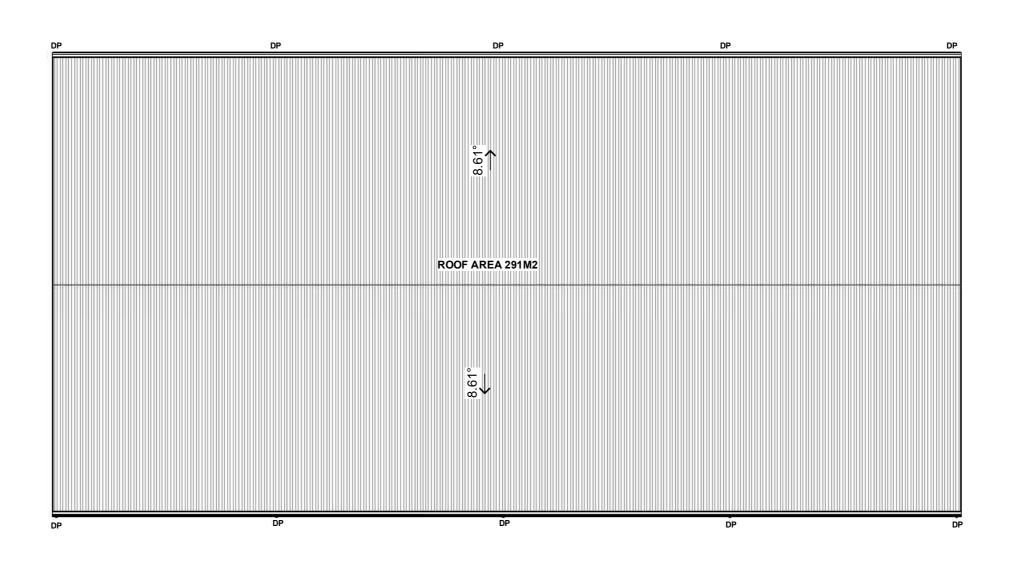

<b>REV</b> : 8	DATE: 25.08.2025	CLIENT:	PLAY FOR DION CHELLIS	SHEET TITLE: SHED ROOF PL	_AN	DI AV DESIGN STUDIO	COPYRIGHT	and the same of th
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NORTHERN ELEVATION A300 1:100

Part

Walls - CORODEK®

Roof - CORODEK®

Gable End Capping

Corner Flashings

Opening Flashings

Personal Access Doors

Roller Doors

Gutters

Colour

BASALT®

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A300

REV: 8	DATE: 25.08.2025	CLIENT: PLAY FOR DION CHELLIS		SHEET TITLE: EXTERNAL ELEV	/ATIONS	DI AV DESIGN STUDIO	COF
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		CHECKED:	PLAY	SCALE: 1:100		EMAIL: info@playdesignsutdio.com.au	PTY





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		CHECKED: PLAY		SCALE: 1:100		EMAIL: info@playdesignsutdio.com.au WEB: www.playdesignstudio.com.au	

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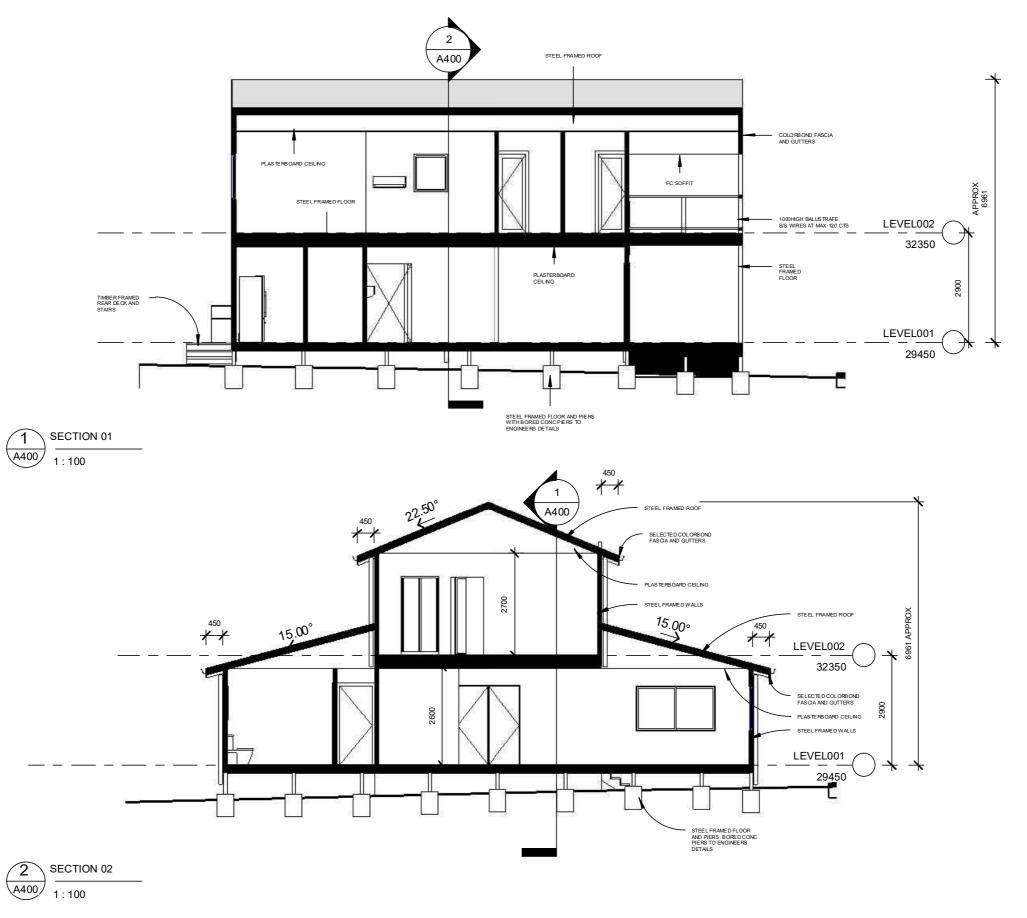
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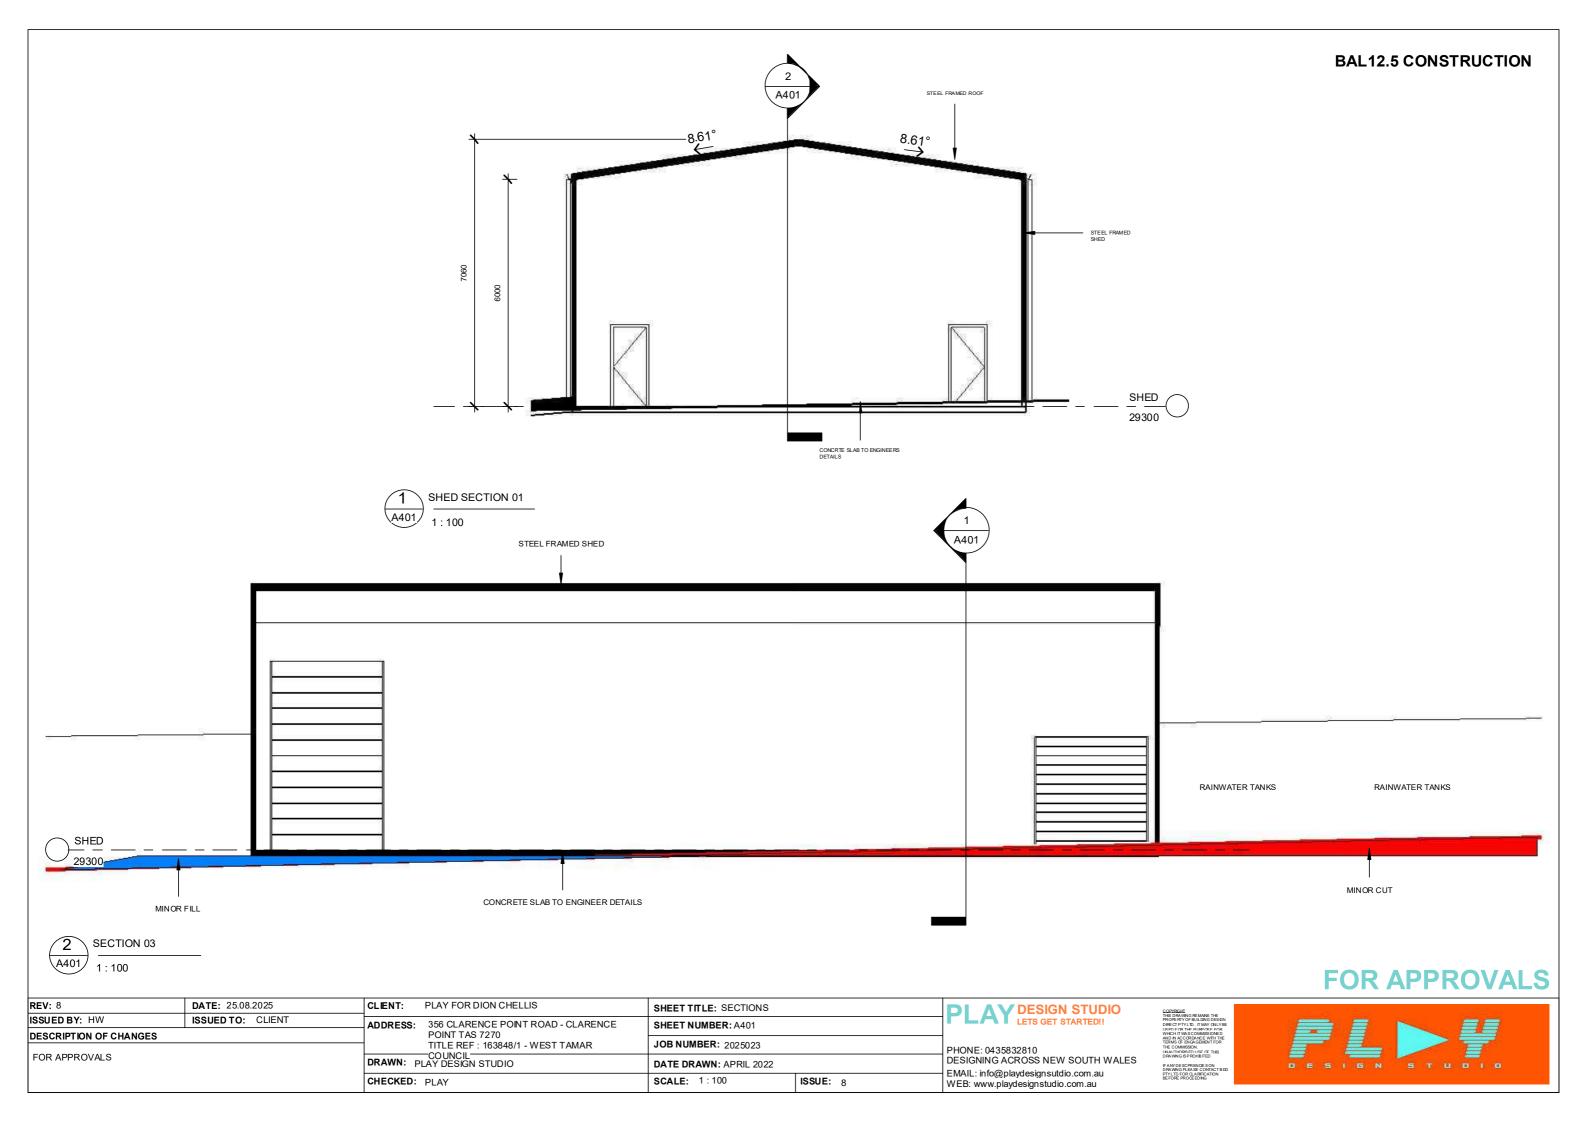



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	DESCRIPTION OF CHANGES		POINT TAS 7270				_	
	FOR APPROVALS		DRAWN: PLAY DESIGN STUDIO		JOB NUMBER: 2025023		PHONE: 0435832810	
					DATE DRAWN: APRIL 2022		DESIGNING ACROSS NEW SOUTH WALES  EMAIL: info@playdesignsutdio.com.au  WEB: www.playdesignstudio.com.au	
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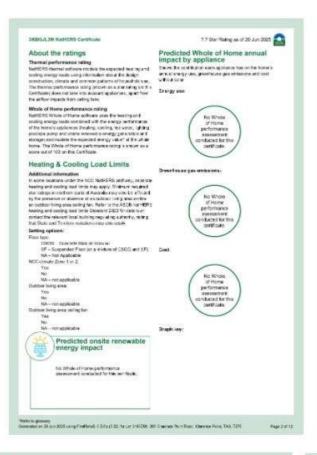
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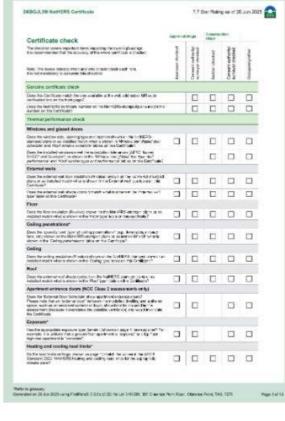
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	DESCRIPTION OF CHANGES		POINT TAS 7270				-	
			1	TITLE REF: 163848/1 - WEST TAMAR	JOB NUMBER: 2025023		PHONE: 0435832810	
	FOR APPROVALS		DRAWN: PLAY DESIGN STUDIO		DATE DRAWN: APRIL 2022		DESIGNING ACROSS NEW SOUTH WALES  EMAIL: info@playdesignsutdio.com.au  WEB: www.playdesignstudio.com.au	
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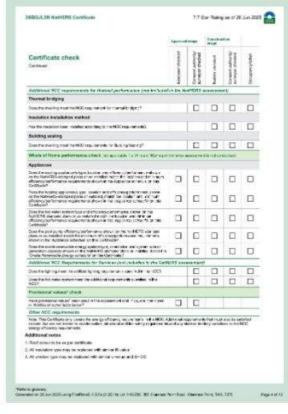
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## Nationwide House Energy Rating Scheme\* NatHERS" Certificate No. 316BGJL391 \*\*\*\* Generated on 28 Jun 2025 using FirstRolofs 5.5.5a (3.22) 7.7 Address HOUSE Plans Mais plan 30.05.2025 Prepared by INV 87.7 MJ/m<sup>2</sup> Assessed floor area [er]\* Considered\* 172.5 Unconditioned\* 14.1 Total 166.6 Carage Exposure type sustants Nati-ERS dimute zone 67 Low Hest Thermal performance (MJan) Accredited assessor Heating Cooking Workflood 86.4 1.3 Load Brid's No.5 No.5 Practice challens PAUL IS DAY D 91-30-com/militim mm au 049(01-005 131(25) NCC Requirements Whole of Home performance rating National Construction Code (NOC) requirements No Whole of Home performance rating generated for this NCC 2022 includes estimated them algorithm in the feet in the fit and and appropriate the control of the contro







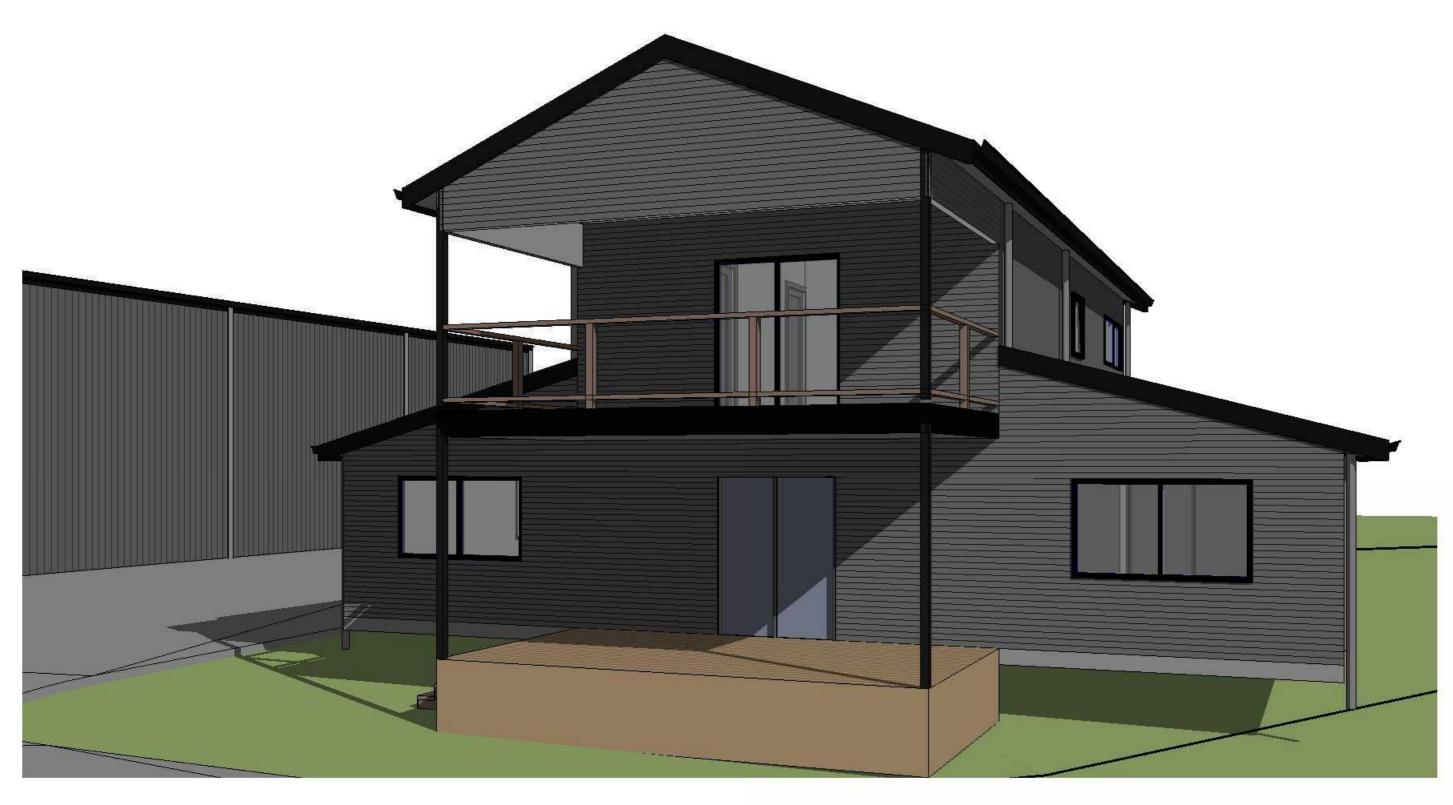

Their to growing General Anni 2025 using Pre-Rand CS Social 25 for us 2 HV-200. 25 C general Perin Rand Cleaner Perin TWO, FUT

**BAL12.5 CONSTRUCTION** 





Kitchen Living	IIIS - Timber	40.5 Oo	in	R2.5	Th	mber"
Stars	Pis-Tinter	63 Do	in	R2.0	70	ntw'
Biodropers 10	7RS - Timber Lines	OA D	itsed	R2.5	70	mber:
ENR	MS Yestert each		miel .	Rose		-
WC .	M5-TesterLnec	1 10	test	62.0	- 1	
teranii	His - Total Load	tit te	front	806	19	100
Ceiling type						
		Constitucion:	Bide mink			<b>Autocited</b>
Location		inclose type	part perpa	in order too	f educe)	wint,
Hedrours 2		Photoconi	Hye:			Tes.
Bedroom 0		Photocont	ROS			Yes
Both		Political	Mile			Yes
WC		Photocost	R66			The
Duy 5		Phyloniani	MED			Tre
LDRY		FRE-Transland	R2.1			No.
Puelry		FRS - Tener and	F21			No
Kiloten/Living		FRS - Transport	R23			No
KilohoviLiving		PRO-Tempulari	M2.5			No
KildrenLiving		Philaret	850			Yes.
Stairs		FRC Tests Land	MES			No.
Sedroon 10		Photocorr	PAG.			Yes
ENS		Ploteixen	PAGE 1			Yes
NVC .		Plotocet	P64			Tec
DHAM		Photocory	Mile			700
Ceiling penetra	ations*					
Location	Charity	Type	regis	West.	Benedia	annie i
Deproors 7	1	Booring #1	94	100	Tested	
Sedicary II	2	Booriges.	510	70.00	Deservi	
Ruth:	1	fauntes	24	250	Swelet	
WC	(6)	forestee	214	216	Darwins.	
Dies 5	1	Boorig to	16	100	Sealed	
1.089	X.	Exertise	316	290	Service.	
Killchand.umg	17	Door by the	100	100	Swated.	
Kitchen/Living	*	fawerfew	398	240	Seidel	
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INS		Donactive	216	250	Desired	
WC .	*	Dwarfre.	216	290	Sweet	





## FOR APPROVALS

<b>REV</b> : 8	DATE: 25.08.2025	CLIENT:	PLAY FOR DION CHELLIS	SHEET TITLE: NATHERS		DI AV DESIGN STUDIO		
ISSUED BY: HW	ISSUED TO: CLIENT	ADDRESS:	356 CLARENCE POINT ROAD - CLARENCE	SHEET NUMBER: A600		LAT LETS GET STARTED!!		
DESCRIPTION OF CHANGE	DESCRIPTION OF CHANGES		POINT TAS 7270 TITLE REF: 163848/1 - WEST TAMAR	JOB NUMBER: 2025023		FUENE MASSOCIA		
FOR APPROVALS		DRAWN: F	COUNCIL PLAY DESIGN STUDIO	DATE DRAWN: APRIL 2022		PHONE: 0435832810 DESIGNING ACROSS NEW SOUTH WALES		
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THE COMMISSION.









# Certificate No. # 3I6BGJL39I

Scan QR code or follow website link for rating details.

Assessor name

Pranab chakma

Accreditation No.

101225

Property Address 356 Clarence Point Road,

Clarence Point, TAS, 7270



https://www.fr5.com.au/QRCodeLanding?PublicId=3I6BGJL39I

REV: 8 DATE: 25.08.2025		CLIENT: PLAY FOR DION CHELLIS		SHEET TITLE: NATHERS		PLAY DESIGN STUDIO LETS GET STARTED!!	COL
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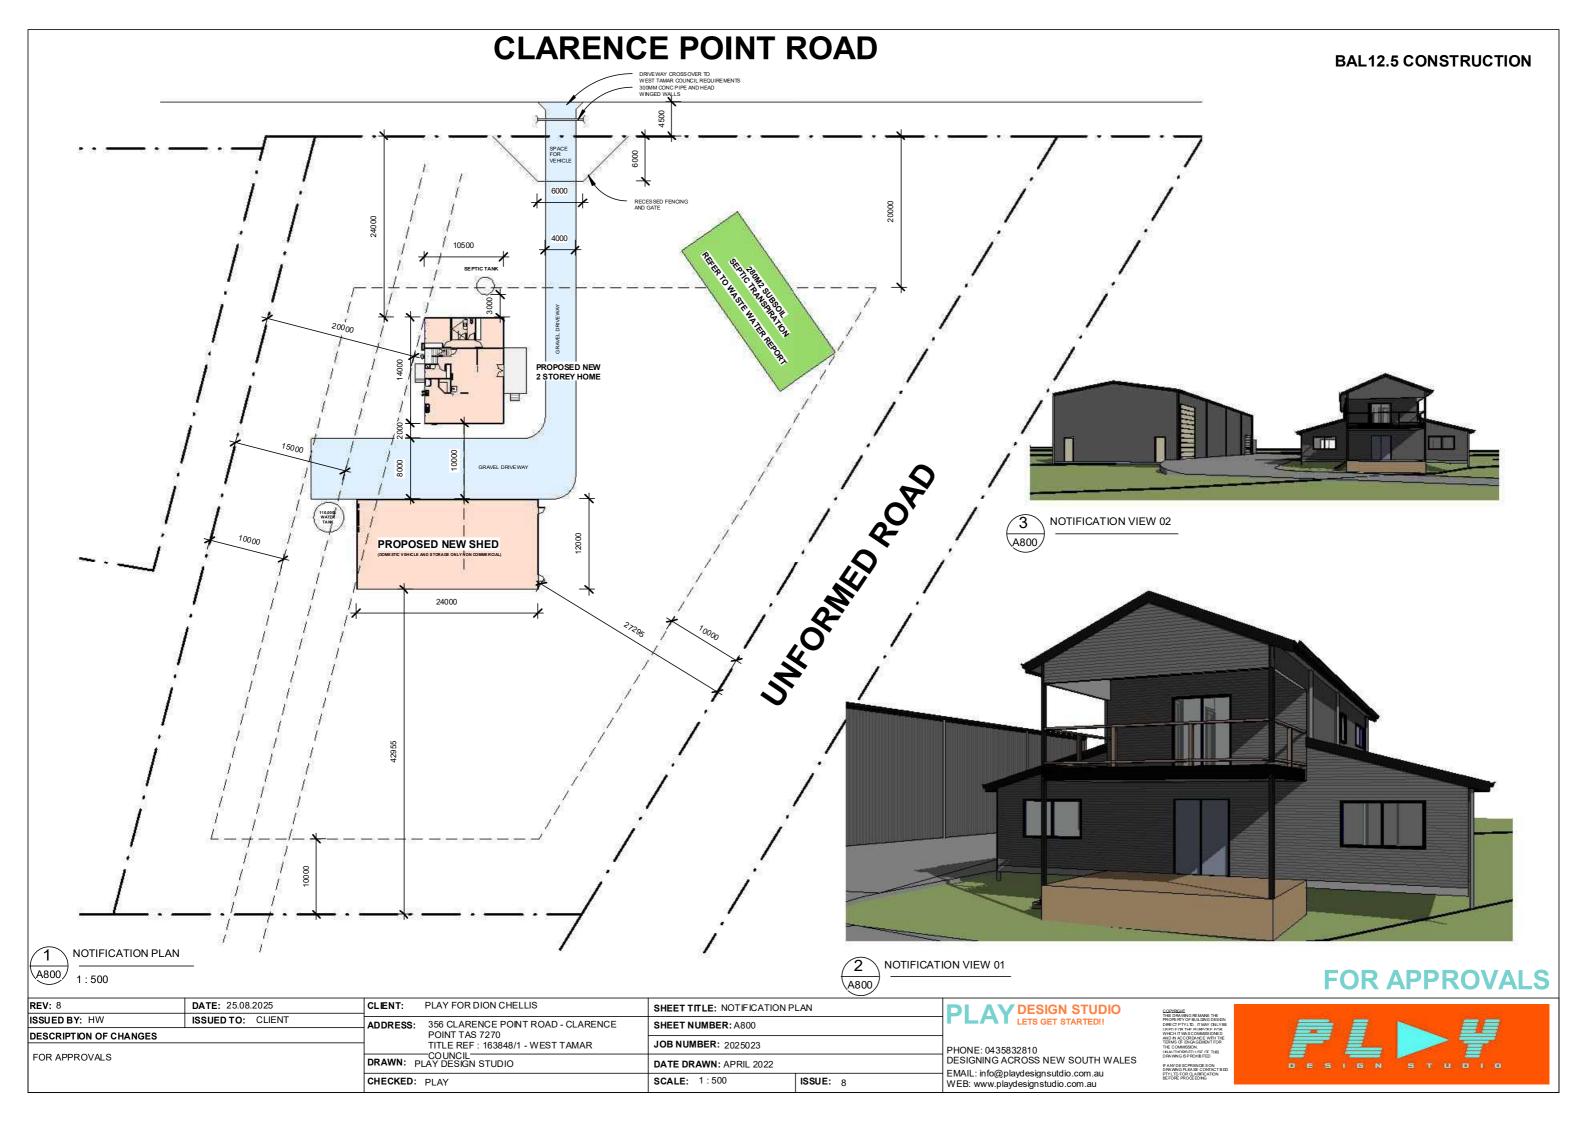
	WINDOW AND DOOR SCHEDULE													
WIN NO.	Window Location	WINDOW SIZE	Orientation	WINDOW AREA	GLAZING TYPE	Shading Type and Size	Overshadowing	Frame Material	Frame Colour	U-Value	SHGC	COMMENTS		
D1	LDRY	2100X1500 SF ASD	SOUTH	3.15	CLEAR	EAVE 450MM	NONE	ALUMINIUM	MONUMENT	4.3	0.45-0.49			
D2	ENSUITE	2100x1800MM SF ASD	NORTH	3.78	CLEAR	VERANDAH 3000	NONE	ALUMINIUM	MONUMENT	4.3	0.45-0.49			
W1	BATH	1200x2100mm SF ASW	SOUTH	2.52	CLEAR	NONE	NONE	ALUMINIUM	MONUMENT	4.3	0.45-0.49			
W2	LIVING	1200x2100mm SF ASW	EAST	2.52	CLEAR	EAVE 450MM	NONE	ALUMINIUM	MONUMENT	4.3	0.45-0.49			
W3	KITCHEN	1200x2100mm SF ASW	SOUTH	2.52	CLEAR	NONE	NONE	ALUMINIUM	MONUMENT	4.3	0.45-0.49			
W4	BED 3	1200x2100mm SF ASW	SOUTH	2.52	CLEAR	NONE	NONE	ALUMINIUM	MONUMENT	4.3	0.45-0.49			
W5	BATH	1200X1200 SF ASW	WEST	1.44	CLEAR	EAVE 450MM	NONE	ALUMINIUM	MONUMENT	4.3	0.45-0.49			
W6	WC	900X600 SF ASW	WEST	0.54	CLEAR	EAVE 450MM	NONE	ALUMINIUM	MONUMENT	4.3	0.45-0.49			
W7	BATH	1200x2100mm SF ASW	SOUTH	2.52	CLEAR	NONE	NONE	ALUMINIUM	MONUMENT	4.3	0.45-0.49			
W8	BED 01	900X2100 SF ASW	WEST	1.89	CLEAR	EAVE 450MM	NONE	ALUMINIUM	MONUMENT	4.3	0.45-0.49			
W9	BED 01	1000X900 AWNING	WEST	.0.9	CLEAR	EAVE 450MM	NONE	ALUMINIUM	MONUMENT	4.3	0.45-0.49			
W10	BED 01	1000X900 AWNING	EAST	.0.9	CLEAR	EAVE 450MM	NONE	ALUMINIUM	MONUMENT	4.3	0.45-0.49			
W11	BED 01	1200x2100mm SF ASW	SOUTH	2.52	CLEAR	NONE	NONE	ALUMINIUM	MONUMENT	4.3	0.45-0.49			
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# FOR APPROVALS

REV: 8	DATE: 25.08.2025		PLAY FOR DION CHELLIS	SHEET TITLE: WINDOW AND D	OOR SCHEDULE	DI AV DESIGN STUDIO	
ISSUED BY: HW ISSUED TO: CLIENT		ADDRESS: 356 CLARENCE POINT ROAD - CLARENCE		SHEET NUMBER: A700		LETS GET STARTED!!	
DESCRIPTION OF CHANGES	DESCRIPTION OF CHANGES		POINT TAS 7270 TITLE REF : 163848/1 - WEST TAMAR	JOB NUMBER: 2025023		PHONE: 0435832810 DESIGNING ACROSS NEW SOUTH WALES	
FOR APPROVALS		DRAWN: F	COUNCIL— PLAY DESIGN STUDIO	DATE DRAWN: APRIL 2022			
		CHECKED: PLAY		SCALE:	ISSUE: 8	EMAIL: info@playdesignsutdio.com.au WEB: www.playdesignstudio.com.au	

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## SECTION 5 CONSTRUCTION REQUIREMENTS FOR BAL-12.5

of in Section 2 as being BA  $I_r$ —12.5 shall conform with Section 3 and

Any element of construction or system that satisfies the test criteria of AS 1530.8.1 may be used in lieu of the applicable requirements comained in Clauses 5.2 to 5.8 (see Clause 3.8). NOTE: BAL-12.5 is grasselly concerned with protection from other stack and reduct here to and including 12.6 kM/m<sup>-2</sup> where the size is less than 100 m from the source of bushfire attack.

This Standard does not provide construction requirements for subfloor support where the subfloor space is enclosed with—

- (a) a wall that conforms with Clause 5.4; or
- a mesh or perforated sheet with a maximu in aperture of 2 mm, made of correspondentiates, bronze or aluminium; or
- Where the subfloor space is unanclosed, the support posts, columns, stumps, piers and poles shall be constructed of -
- (ii) bushfire-resisting limber (see Appendix F); or
- (iii) a timber species as specified in Appandix E Paragraph E1; or
- (iv) a combination of Items (5, 50 and 50.
- NOTE: This requirement applies to the subject pulkting only and not to venerities, decks, steps, namps and landings (see Clause 5.7).
- Combustible material should not be stored in the subfloor space as these may be ignited by embers and cause an additional impact to the building.

### 5.3 FLOORS

### 5.3.1 General

This Standard does not provide construction re-quirements for concrete slabs on the ground

5.3.2.1 Enclosed autiliour space This Standard does not provide construction requirements for elevated floors, including bearers, joixts and flooring, where the subfloor space is enclosed with—

- (a) a wall that conforms with Clause 5.4; or
- a mash or perforated sheet with a maximum aperture of 2 mm, made of corrosion-resistant steet, bronze or aluminium; or

BAL-12.5

(ii) Door from material Door frame material shall be-

(A) bushfire resisting timber (see Appendix F); or

hollow core, solid timber, am nated timber or reconstituted timber protected externally by a screen that conforms with Clause 5.5.2; or

(E) for fully framed plazed door canels, the framing shall be made from metal or bushfire resisting timber (see Appendix F) or a timber species as specified in Paragraph E2. Appendix E or uPVC.

(B) a timber species as specified in Paragraph E2 of Appendix E; or

Herdwere. There are no specific requirements for hardware at this BAL

(D) metal-reinforced uPVC. The reinforcing members shall be made from aluminium, stainless steet, or consistent steet.

Olazing: Where doors incorporate glazing, the glazing shall be Grade A safety glass a minimum of 4 mm in thickness, or glass tracks with no restriction on

Seak and weather office. Weather strips, draught excluders or draught seals shall be installed.

Doors shall be tight-fitting to the door frame and to an abutting door, if

(vi) Screens. There is no requirement to extrem the operation part of the door at this BAL.

(a) be completely protected by a bushfire shulter that conforms with Cause 3.7 and Clause 5.5.1.

A2 | (c) a combination of items (a) and (b).

Sliding doors shall-

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5.3.2.2 Upenclosed supplier space Where the subfloor space is unenclosed, the bear-ers, joists and flooring, less than 400 mm above finished ground level, shall be one of the following:

- (a) Material that conform with the following:
- (i) Bourers and joints shall be-
  - (B) bushfire-resisting finiter (see Appendix F) or
  - (C) a combination of items (A) and (B).
  - (ii) Flooring shall be-

  - (B) bushfire-resisting Ember (see Appendix F); or
  - (C) Simber (other than bushfire-rewaing limber), pertoleboard or phywood flooring where the uncors so is lined with sarking-type material or mineral wool insulation; or
  - (D) a combination of any of items (A), (B) or (C);

## (b) A system that conforms with AS 1550.5.1

This Standard does not provide construction requirements for elements of elevated floors, including bearins, joists and flooring, if the enderside of the element is 400 mm or more above finished ground level.

### 5.4.1 General

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5.6.1 General

AS 3859:3019

The exposed components of an external well that are less than 400 mm from the ground or less than 400 mm above docks, carport noch, sentings and similar elements or fittings having an englied of less than 15 degrees to the horizontal and entending recent than 110 mm in width from the wall (see Figure 03, Appendix 0) shall be as follows:

- Non-combustible material including the following provided the minimum thickness is 90 mm;
  - Full masonry or masonry veneer walks with an outer leaf of day, concrete, caldium alliquite or natural stone.
  - (ii) Precast or in situ walls of concrete or aerated concrete
  - (iii) Earth wall including mud brick; or
- (b) Timber logs of a species with a density of 680 kg/hrf or greater at a 12% moisture content; of a minimum contrain deveral thickness of 90 mm and a minimum thickness of 70 mm (see Clause 3.11); and gauge claimed, or
- (c) Cladding that is fixed externally to anabor-framed or a stool-framed wall and is-
- fibre-cement a minimum of  $\boldsymbol{\theta}$  mm in thickness, or
- (iii) bushfire-resisting timber (see Appendix F); or
- (iv) a limber species as specified in Paragraph E1, Appendix E; or

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Glazing: Where doors incorporate glazing, the glazing shall be Grade A safety glass a minimum of 4 mm in thickness.

See's and weather africe. There are no specific requirements for seets and weather ships at this BAL.

Screen: There is no requirement to screen the operable part of the sliding door at this BAL.

(a) The tower portion of a vehicle access door that is within 400 mm of the ground when the door is closed (see Figure D4, Appendix D) shall be made from—

All vehicle access doors shall be protected with suitable weather strips, draught excluders, draught seals or brushes. Door assemblies fitted with guide tracks do not need edge gap protection.

C8.5.6(b) These guide treaks do not provide a direct passage for embars into the

Vehicle access doors with ventiletion state shall be protected in accordance with Clause 3.8.

5.8 ROOFS (INCLUDING PENETRATIONS, EAVES, FASCIAS AND GABLES, AND GUTTERS AND DOWNPIPES)

The roof/wall and roof/roof junction shall be sealed or otherwise protected in accordance with Clause 3.8.

Only evaporative coolers manufactured in accordance with AS/NZS 60335.2.96 shall be used. Evaporative coolers with an internal damper to prevent the entry of embers

(i) Blandards Audrelle vores Mandards organi.

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Roof ventilation openings, such as gable and roof vents, shall be fitted with ember guerts made of non-combusticle mater of or a meet or perforated sheet that conforms with Clause 3.6 and, made of corrosion-resistant sites), bronze or aluminium.

The following applies to all types of roofs and roofing systems:

(a) Roof tiles, roof sheets and roof-covering accessories shall be non-combined.

nto the roof space need not be screened externally

Refer to AS/NZS 4505 for door Gaps of door edges or building

(vi) Silding panels. Silding panels shall be tight-fitting in the frame:

(iv) a timber species as specified in Paragraph E1, Appendix E; or

v) a combination of any of flams (i), (ii), (iii) or (iv).

5.5.6 Doors-Vehicle occess doors (garage doors)

BAL-FZ 9.5.2 Screens for windows and doors

Where fitted, screens for windows and doors shall have a most or perforated sheet made of

Screen assemblies shall be utached using metal fixing

- 9.5.3 Windows and sidelights
- be completely protected by a basisfine shader that conforms with Clause 3.7 and Clause 9.5.1; or
- (b) the operable portion of the window shall be serected internally or externally with a screen that conforms with Cinnac 3.6 and Clause 9.5.2, and either
- (i) the window system shall have an FRL of st Joses -/306-; or (ii) the window system shall powfurn with A5:1530.5.2 when tested from the
- 9.5.4 Doors-Side-hung external doors (including French doors, panel fold and bi-fold doors)

- Side-hung external doors, including French doors, penel feld and bi-fold doors, shall-(a) be completely processed by Yuchfire Shapers that conform with Clause 3.7 and Clause 9.3.1.
- (i) All door systems, including door frames and doors with glasted punels, shall-
- (B) conform with AS 1530.8.2 when tested from the autoide.
- (ii) Deers shall be right-fitting to the door frame and to an abutting door, if applicable
- (iii) Weather sings, draught excluders or draught scale shall be installed at the base of side-hung exernal doors.
- (v) Seals shall not compromise the FRL or the performance achieved in AS 3530.4

### Sliding doors shall-

- be completely protected by a highling shutter that conforms with Clause 3.7 and Clause 9.5.1;

  - (i) All sliding door systems, including those with glazed panels, shall-
  - (A) have an FRL of at least 90'; or
  - (B) conform with AS 1550,8,2 when tested from the outside
  - (ii) Sliding doors shall be right-fitting in the frames.

- 5.6.2 Tiled roofs
- (a) be located on top of the roof from  $n_{\rm S}$  , except that the roof bettern may be fixed above the sarking:

BAL-12.5

- (b) cover the entire roof area including rispes and blos; and

### 5.6.3 Sheet roofs

- be fully sarked in accordance with Clause 5.6.2, except that to i-backed insulation blankets may be installed over the battons; or
- (b) have any gaps scaled at the flaress or wall line, hips and ridger by-
- a mesh or perforated sheet that comforms with Clause 3.8 and that is made of comosics-resistant steel, bronze or all minium; or
- (ii) mineral woot; or
- (v) a combination of any of tierrs (\*), (ii) or (iii)

# C5.6.3 Sarking is used as a secondary form of ember protection for like roof space to account for mixor gaps that may develop in show routing.

- The following applies to verands, carport and awning roofs:
- (a) A versinda, carport or awning mof forming part of the main noof space [see Figure O1(a), Appendix O) shall meet all the requirements for the main roof, as specified in Closes 6.6.1.1.0.6.0.5.
- (b) A veranda, carport or awning roof separated from the main roof space by an external val [see Figures D(4) and D(4), Appendix D( that conforms with Clause 5.4 shall have a non-contactable not obeying, except, where the roof covering is a translucent of transparent instantal.
  NOTE: These is re-regardered to the the unclande of a wearda, cuport or awning not that is separated to the train to displace.

### 5.6.5 Roof penetrations

- (a) Roof penetrations, including roof lights, roof ventilators, roof-mounted evaporable cooling units, serals, vertipies and supports for solar collection or the like, shall be sealed. The material used to seel the penetration shall be non-combusticle.
- This requirement does not apply to a room scaled gas appliance. NOTE: A gas appliance designed such that air for combustion does not enter from, or combustion products other rife. The room in wition the appliance is located.
- In the case of gas applicance flues, entitler guards shall not be fitted.

  NOTE: ASMES 6601 contains requirer area for gas applicans if an systems and cowls.

  Advice can be obtained from manufacturers and State and Territory gas technical regulators.

Supersymptotic reservation of the supers

### BAL-12.5

- Frame material. For window assemblies less than 400 mm from the ground or less than 400 mm above docus, corport roofs, awrings and similar elements or fittings having an angle less than 18 degrees to the horizontal and extending more than 110 mm in with from the window frame (see Figure 03, Appendix D), window frames and window join ery shall be made from one of the
  - (A) Bushfire-resisting timber (see Appendix F), or
  - (B) A timber species as specified in Paragraph S2, Appendix E; or
- (C) Metalt or
- (D) Metal-reinforced uPVC. The reinforcing members shall be made from aluminium, stainless steel or corrosion-resistant steel.
- restrictives in their size to operation that could be necessarily or operations of necessaries or extractive of Classifery. Where placing is less than 400 mm the ground or less than 400 mm above decide, carport, note, eximings and similar elements or fittings having an angle less than 18 degrees to the horizontal and extending more than 100 mm in width from the window frame (res Figure DS, Appendix D), this placing shall be Grade A salery glass a minimum of 4 mm in thickness or glass blocks with no restriction on glassing methods.

  NOTE: Where double-glassic sessent/lice are used above, the requirements apply to the restemal part of the glassic sessential part of the glassi
- (iv) Seas and weather arrios. There are no specific requirements for seals and weather strips at this SAL.
  - (v) Screens The openable portions of windows shall be screened internally externally with screens that conform with Clause 3.6 and Clause 5.5.2.
- CS.5.3(B) For Clause 5.5 3(c), acrossing to openedia portione of all windows is required in all GALs to prevent the window of windows to the building when the window open.
- 5.5.4 Doors—Side-hung external doors (including French doors, panel fold and bi-fold doors)
- Side-hung external doors, including French oper panel feld and bi-fold doors, shall-(a) be completely protected by trushfire shutters that conform with Clause 3.7 and Clause 6.5.1;
- (b) be completely protected externally by screens that conform with Clause 3.6 and Clause 5.5.2;
- (i) Door panel material Material shall be-
  - (A) non-combustible; or

### AS 1968-2018 NO

## BAL-12.5

- (d) Glazed elements in roof lights and soft gitts may be of polymer provided a Grade A safety glaze diffuser, that conforms with AS 1/188, is installed under the glazing. Where glazing is an installing glazing and (CUI), Center A toughered safety glass of minimum 4 mm in trickness shall be used in the outer pane of the IGU.
- Flacking elements of tuburar skylights may be of a fire-retardant meterial, provided the roof stoggifty a maintained by an under-hasting of a material beving a flammability index not greater than 5.
- Evaporative cooling units shall be fitted with non-combustible butterfly closers as close as practicable to the not fixed or the unit shall be fitted with non-combustible covers with a meet or perforated shaet with a maximum sperture of 2 mm, made of completion-selstant stated, owners or aboration.
- (h) Eaves lighting shall be adequately scaled and not compromise the performance of the obraces.
- The following applies to eaver trings, factors and gables: a) Gables shall conform with Clause 5.4.
- Eaves penetrations shall be protected as for roof penetrations as spe-Clause 5,6,5.
- (c) Eaves ventilation openings shall be fitted with ember guards in accordance with Clause 3.6 and made of conosion-resistant steel, bronze or aluminium. Joints in eaves linings, faccios and gables may be estated with plastic joining strips or limber storm moulds.

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This Standard does not provide construction requirements for fascies, barg-caves liminos.

### 5.6.7 Gutters and downpipes

- This Standard does not provide material requirements for
- (a) gutters, with the exception of box gutters; and
- Box gutters shall be non-combustible and fashed at the junction with the roof with non-combustible material.

## 5.7 VERANDAS, DECKS, STEPS AND LANDINGS

### 5.7.1 General Decking may be spaced. here is no requirement to enclose the subfloor spaces of verandas, deaks, steps, ramps or

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## (b) be completely protected columnity by screens that conform with Clause 3.6 and Clause 3.5.2; or (c) conform with the following Frame material. The material for door frames, including fully framed glazed doors, shall ho— (A) bushfire-resisting Ember (see Appendix F); o (B) a timber species as specified in Paragraph E2, Appendix E; or (D) metal-reinforced uPVC and the rein forcing members shall be made from sluminium, stainless steel, or correction-resistant steel (ii) Marchoore There are no specific requirements for hardware at this BAL

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C5.7.1 Spaced decking is nominally spaced at 3 mm (in accordance with standard industry practice); however, due to the nature of timber decking with seasonal change in moisture content, that spacing may range from 0 - 5 mm during service. It should be noted that research studies have shown that ga ps at 5 mm spacing afford opportunity for embers to become lodged in between timbers, which may contribute to a fire. Larger gap spacing of 10 mm may preclude this from happening but such a spacing regime may not be practical for a timber deck.

AS 3959:2018

### 5.7.2 Enclosed subfloor spaces of verandas, decks, steps, ramps and landings

5.7.2.1 Material to enclose a subfloor space

This Standard does not provide construction requirements for the material used to enclose a subfloor space except where those material are less than 400 mm from the ground.

Where the material used to enclose a subfl oor space are less than 400 mm from the ground, they shall conform with Clause 5.4.

This Standard does not provide construction requirements for support posts, columns, stumps, stringers, piers and poles.

This Standard does not provide construction requirements for the framing of verandas, pergolas, decks, ramps or landings (i.e. bearers and joists).

### 5.7.2.4 Decking, stair treads and the trafficable surfaces of ramps and landings

This Standard does not provide construction requirements for decking, stair treads and the trafficable surfaces of ramps and landings that are more than 300 mm from a glazed

Decking, stair treads and the trafficable su rfaces of ramps and landings less than 300 mm (measured horizontally at deck level) from glazed elements that are less than 400 mm (measured vertically) from the surface of the deck (see Figure D2, Appendix D) shall be made from-

- (a) non-combustible material; or
- (b) bushfire-resisting timber (see Appendix F); or
- (c) a timber species as specified in Paragraph E1, Appendix E; or
- (d) uPVC; or
- (e) a combination of any of Items (a), (b), (c) or (d).

### 5.7.3 Unenclosed subfloor spaces of verandas, decks, steps, ramps and landings

This Standard does not provide construction requirements for support posts, columns, stumps, stringers, piers and poles.

### 5.7.3.2 Framing

This Standard does not provide construction requirements for the framing of verandas, decks, ramps or landings (i.e. bearers and joists).

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### 5.7.3.3 Decking, stair treads and the trafficable surfaces of ramps and landings

This Standard does not provide construction requirements for decking, stair treads and the trafficable surfaces of ramps and landings that are more than 300 mm from a glazed

Decking, stair treads and the trafficable su rfaces of ramps and landings less than 300 mm (measured horizontally at deck level) from glazed elements that are less than 400 mm (measured vertically) from the surface of the deck (see Figure D2, Appendix D) shall be

- (a) non-combustible material; or
- (b) bushfire-resisting timber (see Appendix F); or
- (c) a timber species as specified in Paragraph E1, Appendix E; or
- A2 (d) a combination of any of Items (a), (b) or (c).

## 5.7.4 Balustrades, handrails or other barriers

This Standard does not provide construction requirements for balustrades, handrails and other barriers.

Veranda posts-

- (a) shall be timber mounted on galvanized mounted shoes or stirrups with a clearance of not less than 75 mm above the adjacent finished ground level; or
- (b) less than 400 mm (measured vertically) from the surface of the deck or ground (see Figure D2, Appendix D) shall be made from-
  - (i) non-combustible material; or
  - (ii) bushfire-resisting timber (see Appendix F); or
  - (iii) a timber species as specified in Paragraph E1, Appendix E; or
  - (iv) a combination of any of Items (a) or (b).

### 5.8 WATER AND GAS SUPPLY PIPES

Above-ground, exposed water supply pipes shall be metal.

External gas pipes and fittings above ground shall be of steel or copper construction having a minimum wall thickness in accordance with gas regulations or 0.9 mm whichever is the greater. The metal pipe shall extend a minimum of 400 mm within the building and 100 mm below ground.

NOTE: Refer to State and Territory gas regulations, AS/NZS 5601.1 and AS/NZS 4645.1.

C5.8 Concern is raised for the protection of bottled gas installations. Location, shielding and venting of the gas bottles needs to be considered.

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