Eden Street

Riverside Tasmania 7250 Telephone: (03) 6323 9300 Facsimile: (03) 6323 9349



#### PLANNING APPLICATION FORM

Section 57 & 58

OFFICE USE ONLY

Application Number PA2025206

Assess No: A5285
PID No: 6069981

Applicant Name:	Engineering Plus		
Applicant Contact Name			
Postal Address:			
Contact Phone:	Home	Work	Mobile
Email Address:			

### **Planning Application Lodgement Checklist**

The following documents have been submitted to support the consideration of this application	<u>on:</u>
--	------------

- 1. A current copy of the property title text, folio plan and schedule of easements
  2. A completed application form including a detailed description of the proposal
  3. A complete plan set:
  a) Floor plans
  b) Elevations (from all orientations/sides and showing natural ground level and finished surface level)
  c) Site Plan showing:
  - Orientation
  - All title boundaries
  - Location of buildings and structure (both existing and proposed)
  - Setbacks from all boundaries
  - Native vegetation to be removed
  - Onsite services, connections and drainage details (including sewer, water and stormwater)
  - Cut and/or Fill
  - Car parking and access details (including construction material of all trafficable areas)
  - Fence details
  - Contours
- 4. Other:

#### **WEST TAMAR COUNCIL**



Application Number: «Application Number»

		Al	PPLICANT DETAILS				
Applicant Name:	Allira Bes	Allira Beswick obo Engineering Plus					
<b>Note:</b> Full name			making the application and	nostal add	lress for correspo	ondence.	
	., ., .,	,					
			LAND DETAILS				
Owner/Authority Name: (as per certificate of title)	A. &	C. Conn	ell				
Location / Address:	441 Grave Gravelly B						
Title Reference:	20431/8						
Zone(s):	11.0 Rural	living zo	ne				
Existing Development/Use:		Residen	ntial				
Existing Developed Area:		NA					
A £4b				.12	VEC. I	_	
Are any of the components E.g. Use and/or developmen					YES I	<b>_</b> ⊠	
(If yes please specify the rele	evant compor	nents):			140		
, , , ,	·	•					
	DE	EVELOPM	IENT APPLICATION D	ETAILS			
	Residential Description		isitor Accommodation:	1   C	Commercial: 🗆	Other: 🗆	
Proposed Use:	New dwelling						
		g					
		_	T		_		
	Building wo	rk: 🗹	Demolition: □	Subdivis	sion: 🗆	Other: 🗆	
Development Type:	Proposed dv	velling					
New or Additional Area:	1						
		352.52m	า2				
Estimated construction cost proposed development:	of the	\$780,000					
Building Materials:		Wall Ty	pe: colorbond		Colour: mo	onument	
building iviaterials.		Roof Ty	Roof Type: colorbond		Colour: mo	Colour: monument	

#### **WEST TAMAR COUNCIL**



Application Number: «Application Number»

		VISITOR ACCOM	MODATION	□N/A	
Gross Floor Are	ea to be used per		Number of Bedrooms to be used:		
Number of Car	parking Spaces:		Maximum Number of Visitors at a time:		
	1				
		SUBDIVIS	ION	□n/A	
			Subdivision creat	ing additional lots	
		Bounda	ary adjustment with no addi	=	
Number of	Lots (existing):		Number of Lots (proposed) :		
Description:					
If applying for	r a subdivision which o	creates a new road(s), pleas prefere	e supply three proposed name	es for the road(s), in order of	
1.		preiere	nce.		
2.					
3.					
	<u> </u>				
	CONTRACTOCIAL	NOUCTRIAL OR OTHER	NON DECIDENTIAL DEVE	ODBAFNIT/LICE Dayle	
	COMMERCIAL, I	NDUSTRIAL OR OTHER	NON-RESIDENTIAL DEVE	LOPMENT/USE DN/A	
		Monday / Friday:		То	
Hours of Opera	ntion:	Saturday:		То	
		Sunday:		То	
Existing Car Pa	rking:				
Proposed Car P					
•					
Number of Em	ployees:				
	(Existing) Number of Employees:				
(Proposed)					
Type of Machir	nery installed:				
Details of trade					
method of disp	osal:				

#### **WEST TAMAR COUNCIL**



Application Number: «Application\_Number»

	APPLICANT DEC	CLARATION	
Owner:	As the owner of the land, I declare that the in accurate representation of the proposal and officers to conduct inspections as required for	consent to this application being submitt	
	Name (print)	Signed	Date
Applicant: (if not the owner)	As the applicant, I declare that I have notified the information contained in this application		
	Allira Beswick obo Engineering Plus	The state of the s	13/08/25
	Name (print)	Signed	Date
Crown Consent	he application involves Crown Land you will nee Minister, or a delegated officer of the Cr	rown with a copy of the delegation.	
(if required)	Name (print)	Signed	Date
Chief Executive Officer			
(if required)	Name (print)	Signed	Date
Right of	Way Owner:  I declare that I have notified the owner of the least application that wi	and encumbered by the Right Of Way, of I	
	Name (print)	Signed	Date

## UNREGISTERED DEALINGS AND NOTATIONS

No unregistered dealings or other notations

Page 1 of 1


Department of Natural Resources and Environment Tasmania

www.thelist.tas.gov.au




Tasmanian Government

Issued Pursuant to the Land Titles Act 1980

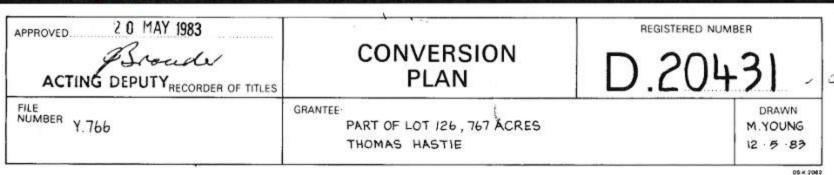

SKETCH BY WAY OF ILLUSTRATION ONLY

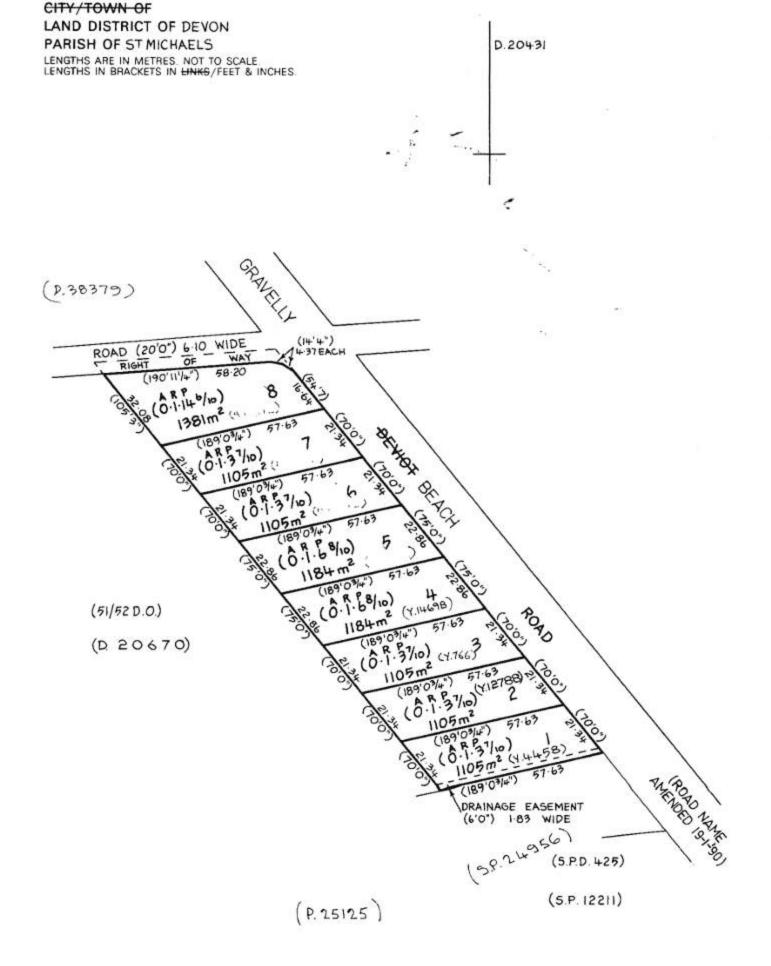



## **DRAWING SCHEDULE**

A00 COVER PAGE

A01 SITE PLAN

A02 GROUND LEVEL CONSTRUCTION FLOOR PLAN

A03 FIRST FLOOR LEVEL CONSTRUCTION PLAN

A04 FIRST FLOOR LEVEL FLOOR PLAN

A05 ELEVATIONS #1

A06 ELEVATIONS #2

A07 ROOF PLAN

A08 3D PERSPECTIVES

## **PROPOSED DWELLING**

A. & C. CONNELL 441 GRAVELLY BEACH RD, GRAVELLY BEACH TAS 7276

WEST TAMAR COUNCIL

## **PROJECT INFORMATION**

BUILDING DESIGNER: GRANT JAMES PFEIFFER

ACCREDITATION No: CC2211T

ZONE: 11.0 RURAL LIVING ZONE

BUILDING CLASS:

LAND TITLE REFERENCE NUMBER:

DESIGN WIND SPEED:

SOIL CLASSIFICATION:

CLASS 1A

20431/8

N2

'P/M'

SOIL CLASSIFICATION: 'P. CLIMATE ZONE: 7

BUSHFIRE-PRONE BAL RATING:

ALPINE AREA:

CORROSION ENVIRONMENT:

FLOODING:

LANDSLIP:

NO

LOW

LANDSLIP: LOW
DISPERSIVE SOILS: UNKNOWN
SALINE SOILS: UNKNOWN

SAND DUNES: NO MINE SUBSIDENCE: NO LANDFILL: NO


GROUND LEVELS: REFER PLAN

ORG LEVEL: 75mm ABOVE GROUND LEVEL

4
Area
24.50 m <sup>2</sup>
9.00 m²
197.30 m²
82.52 m <sup>2</sup>
39.20 m²

352.52 m<sup>2</sup>

## **ISSUED FOR APPROVAL**

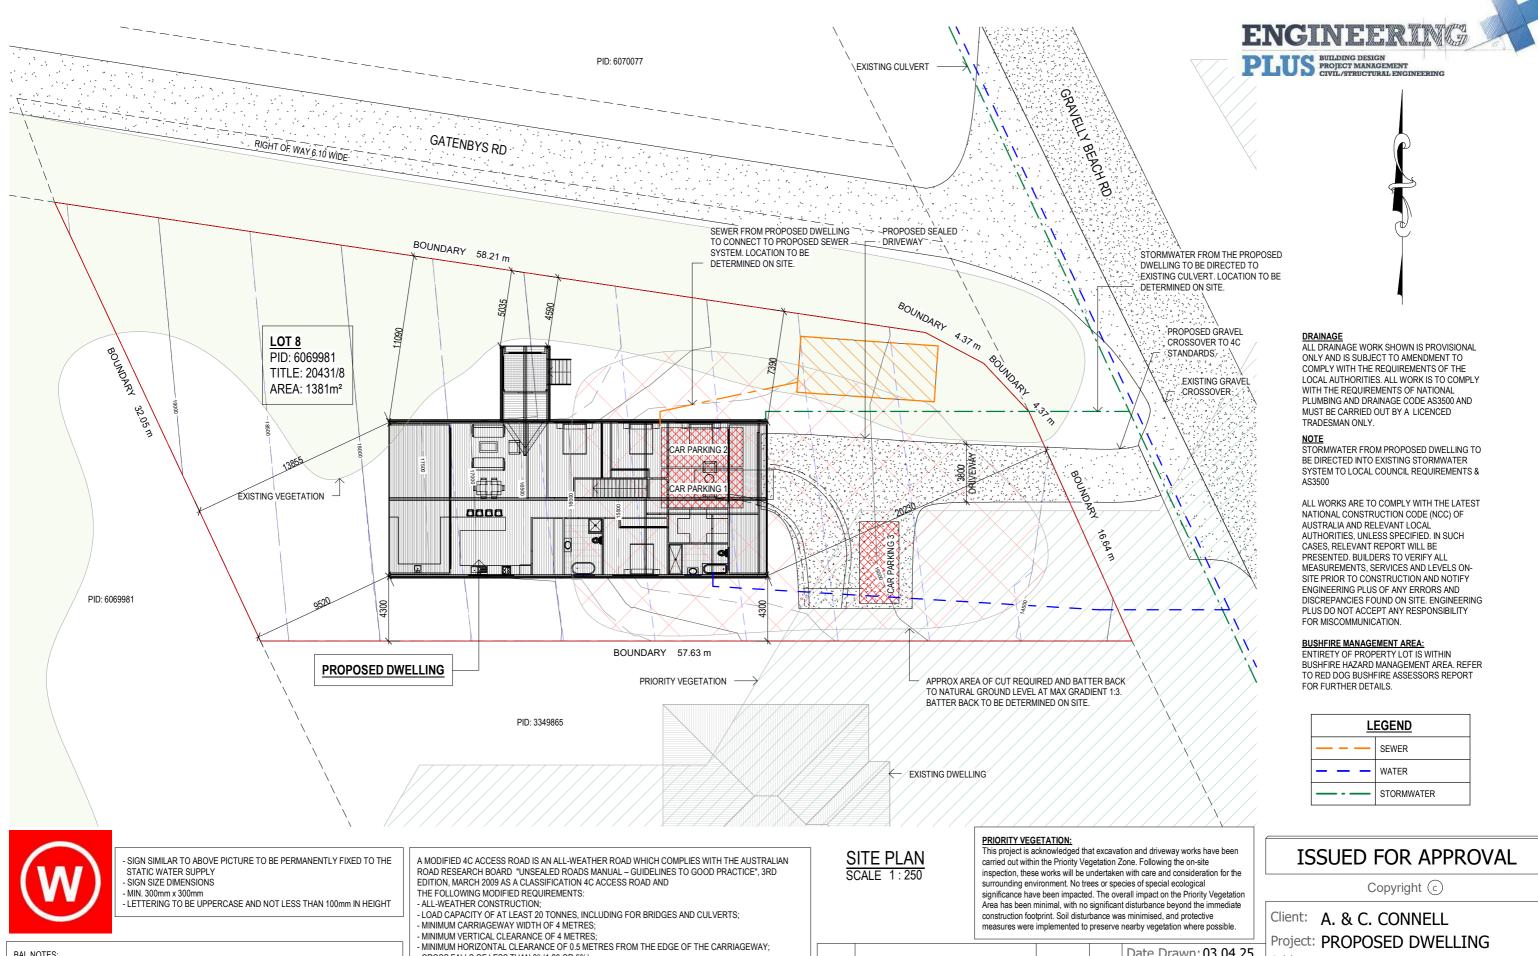

- FIREFIGHTING WATER SUPPLY TO BE A MIN. 10000L PER BUILDING TO BE PROTECTED. THIS VOLUME OF WATER MUST NOT BE USED FOR ANY OTHER PURPOSE INCLUDING FIRE FIGHTING SPRINKLER OR SPRAY SYSTEMS
- WATER TANK MUST BE METAL, CONCRETE OR LAGGED BY NON-COMBUSTABLE MATERIALS AND ALL ABOVE GROUND PIPES & FITTINGS TO BE MADE FROM NON-RUSTING, NON-COMBUSTIBLE AND NON-
- TANK TO BE LOCATED A MINIMUM 6.0m FROM DWELLING AND WITHIN 3.0m OF A HARDSTAND AREA - WATER TANK OR CONNECTION POINT TO BE FITTED WITH A MALE 64mm 5v THREAD COUPLING WITH MINIMUM DELIVERY OF 270L PER MINUTE
- CROSS FALLS OF LESS THAN 3° (1:20 OR 5%);
- DIPS LESS THAN 7° (1:8 OR 12.5%) ENTRY AND EXIT ANGLE; - CURVES WITH A MINIMUM INNER RADIUS OF 10 METRES;
- MAXIMUM GRADIENT OF 15° (1:3.5 OR 28%) FOR SEALED ROADS, AND 10° (1:5.5 OR 18%) FOR
- UNSFALED ROADS: AND - TERMINATE WITH A TURNING AREA FOR FIRE APPLIANCES PROVIDED BY ONE OF THE FOLLOWING:
- A TURNING CIRCLE WITH A MINIMUM INNER RADIUS OF 10 METRES
- A PROPERTY ACCESS ENCIRCLING THE BUILDING; OR
- A HAMMERHEAD "T" OR "Y" TURNING HEAD 4 METRES WIDE AND 8 METRES L

П							Proje
						Date Drawn: 03.04.25	Addr
						Drawn: W. Tan	Addi
						Checked: C. Lim	
	В	RFI.		13.08.25	\// T	Approved: J. Pfeiffer	Office:
l	ט	NI 1.				Scale: AS SHOWH (W AS	info@e
	Α	ISSUED FOR APPRO	VAL	09.07.25	W.T	Accredited Building Des	igner
	-	ISSUED FOR REVIE	W	19.06.25	W.T	Designer Name: J.Pfeif	fer
	Rev:	Amendment:		Date:	Int:	Accreditation No: CC221	L1T

Address:441 GRAVELLY RD,

**GRAVELLY BEACH** 


Office: 6331 7021 info@engineeringplus.com.au **ENGINEER** IN G PLUS BUILDING DESIGN
PROJECT MANAGEMENT
CIVIL/STRUCTURAL ENG

Drawing No: 2025-88 A01 / A08

Rev В





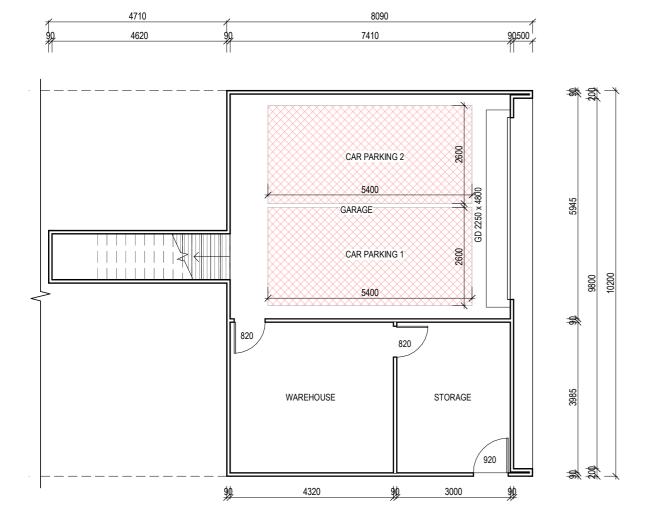



FLOOR	COVERINGS
	CARPET
-4	CONCRETE
	TIMBER DECKING
	TILE
	VINYL TIMBER FLOORING

SMOKE ALARMS
PROVIDE AND INSTALL SMOKE ALARMS & HARD WIRE
TO BUILDING POWER SUPPLY TO AS 3786.
CEILING MOUNTED WITH 9VDC ALKALINE BATTERY BACKUP TO LOCATIONS INDICATED ON PLAN AND IN ACCORDANCE WITH ABCB OF H3D6 - PART 9.5.2

(S) - DENOTES INTERCONNECTED SMOKE DETECTORS

## GROUND FLOOR LEVEL CONSTRUCTION FLOOR LEVEL SCALE 1:100

Area Schedule	(Gross Building)	
Name	Area	Area (sq)
DECK	24.50 m²	2.64
ENTRY DECK	9.00 m²	0.97
FIRST FLOOR LEVEL	197.30 m²	21.24
GROUND FLOOR LEVEL	82.52 m²	8.88
OUTDOOR LIVING DECK	39.20 m²	4.22
	352 52 m²	37 95

GROUND FLOOR LEVEL FLOOR LEVEL SCALE 1:100

RFI.

Rev: Amendment:

ISSUED FOR APPROVAL

ISSUED FOR REVIEW

## **ISSUED FOR APPROVAL**

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Client: A. & C. CONNELL

Project: PROPOSED DWELLING Date Drawn: 03.04.25

Address:441 GRAVELLY RD,

**GRAVELLY BEACH** ENGINEERING

13.08.25 W.T Approved: J. Pfeiffer Scale: As Shown @ A3 Office: 6 Info@er Accredited Building Designer

Drawn: W. Tan

Checked: C. Lim

19.06.25 W.T Designer Name: J.Pfeiffer Accreditation No: CC2211T


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PROJECT MANAGEMENT
CIVIL/STRUCTURAL ENGIS

Drawing No:

2025-88 A02 / A08

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Rev



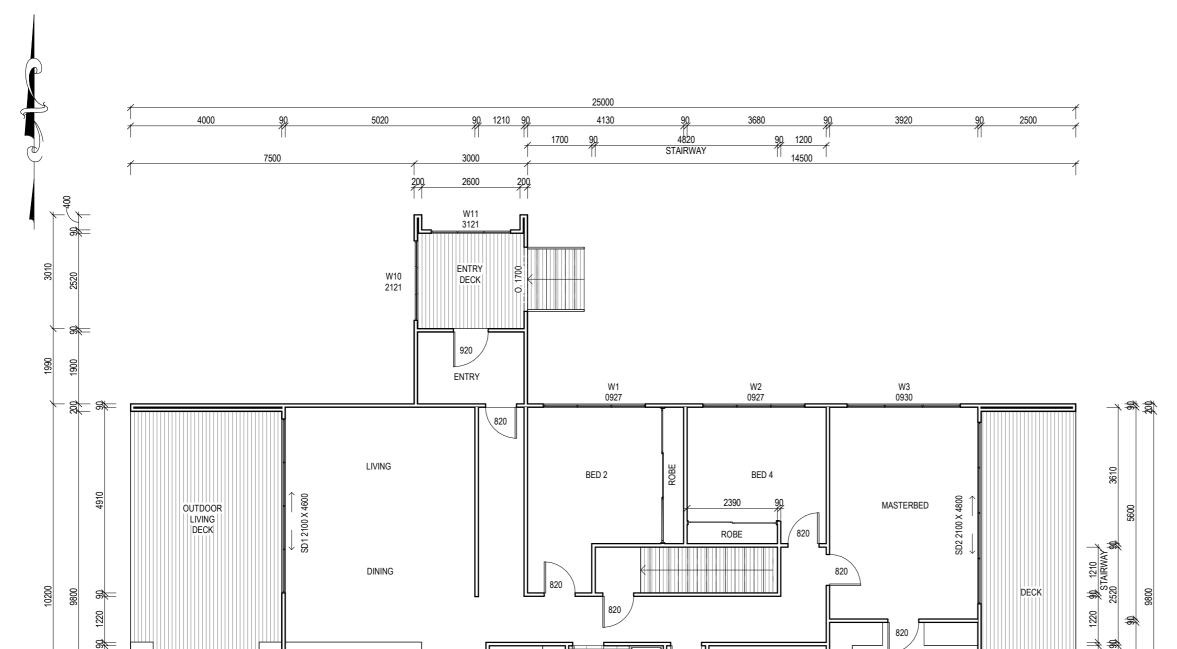

### **WINDOW SCHEDULE**

MARK HEIGHT WIDTH TYPE U-VALUE SHGC

W1 W2 W3 W4 W5 W6 W7 W8 W9 *W10 *W11 ^W12	900 900 900 900 900 900 1000 1000 2100 3130 1070 2450	2700 2700 3000 1500 1100 2400 1500 3000 2100 2100 1860 2220	DG DG DG DG DG DG DG DG DG	4.3 4.3 4.3 4.3 4.3 4.3 4.3 4.3 4.3 4.3	0.55 0.55 0.55 0.55 0.55 0.55 0.55 0.55
^W14	2450	2220	DG	4.3	0.55
^W15	1070	1860	DG	4.3	0.55
SD1 SD2	2100 2100	4600 4800	DG DG	4.0 4.0	0.61 0.61
ODZ	2100	7000	50	т.0	0.01

#### **DISCLAIMER**

SHR

\*\*

2220 WIR

2020 ENSUITE

ALL WINDOWS SHOWN ON PLAN ARE APPROX. BASED OFF STANDARD MANUFACTURING SIZES. ALL WINDOW DIMENSIONS TO BE CONFIRMED ON SITE BY BUILDER PRIOR TO ORDERING AND MANUFACTURING.

Client: A. & C. CONNELL

## FIRST FLOOR LEVEL CONSTRUCTION FLOOR PLAN

BATHROOM

0915

ROBE

3100

BED 3

W6 0924

Area Schedule (Gross Building)				
Name	Area	Area (sq)		
DECK	24.50 m <sup>2</sup>	2.64		
ENTRY DECK	9.00 m²	0.97		
FIRST FLOOR LEVEL	197.30 m²	21.24		
GROUND FLOOR LEVEL	82.52 m²	8.88		
OUTDOOR LIVING DECK	39.20 m²	4.22		
	352.52 m <sup>2</sup>	37.95		

OUTDOOR

KITCHEN

Ģ

W09

KITCHEN

W8 1030

				Date Drawn: 03.04.25
				Drawn: W. Tan
				Checked: C. Lim
				Annroyed: 1 Pfaiffar
В	RFI.	13.08.25	W.T	Scale: As Shown @ A3
Α	ISSUED FOR APPROVAL	09.07.25		Accredited Building Des
-	ISSUED FOR REVIEW	19.06.25	W.T	Designer Name: J.Pfeif
Rev:	Amendment:	Date:	Int:	Accreditation No: CC22

-820-

ENSUITE

W5 0911

### Date Drawn: 03.04.25 Orawn: W. Tan Checked: C. Lim Approved: J. Pfeiffer

Project: PROPOSED DWELLING Address:441 GRAVELLY RD, **GRAVELLY BEACH** 

ENGINEERING PLUS BUILDING DESIGN
PROJECT MANAGEMENT
CIVIL/STRUCTURAL ENGIS

**ISSUED FOR APPROVAL** 

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Drawing No:

В 2025-88 A03 / A08

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<sup>\*-</sup> IF HEIGHT TO GROUND IS GREATER THAN 2.0m WINDOW TO HAVE PERMANENTLY FIXED ROBUST SCREEN INSTALLED OR HAVE AN OPENING RESTRICTED TO 125mm

<sup>^ -</sup> REFER ELEVATIONS FOR HIGHLIGHT WINDOWS







FLOOR COVERINGS

CARPET

CONCRETE

TIMBER DECKING

TILE

VINYL TIMBER FLOORING

SMOKE ALARMS
PROVIDE AND INSTALL SMOKE ALARMS & HARD WIRE
TO BUILDING POWER SUPPLY TO AS 3786.
CEILING MOUNTED WITH 9VDC
ALKALINE BATTERY BACKUP
TO LOCATIONS INDICATED ON PLAN AND IN ACCORDANCE
WITH ABCB OF H3D6 - PART 9.5.2

(S) - DENOTES INTERCONNECTED SMOKE DETECTORS

# FIRST FLOOR LEVEL FLOOR PLAN SCALE 1:100

Area Schedule (Gross Building)		
Name	Area	Area (sq)
DECK	24.50 m²	2.64
ENTRY DECK	9.00 m²	0.97
FIRST FLOOR LEVEL	197.30 m²	21.24
GROUND FLOOR LEVEL	82.52 m²	8.88
OUTDOOR LIVING DECK	39.20 m²	4.22
	352.52 m <sup>2</sup>	37.95

						Projec
					Date Drawn: 03.04.25	Addre
					Drawn: W. Tan	Addie
					Checked: C. Lim	
-					Approved: J. Pfeiffer	000 0
	В	RFI.	13.08.25	W.T	Scale: As Shown @ A3	Office: 6 info@en
	Α	ISSUED FOR APPROVAL	09.07.25	W.T	Accredited Building Desi	gner
	-	ISSUED FOR REVIEW	19.06.25	W.T	Designer Name: J.Pfeif	fer
	Rev:	Amendment:	Date:	Int:	Accreditation No: CC221	.1T

### **ISSUED FOR APPROVAL**

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Client: A. & C. CONNELL

Project: PROPOSED DWELLING

Address:441 GRAVELLY RD, GRAVELLY BEACH

Office: 6331 7021

(a) A3 info@engineeringplus.com.au

ENGINEERIA DE PROPERTO DE PROP

Drawing No: 2025-88 A04 / A08

2025-88 A04 / A08

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SOFFIT / EAVE LINED WITH 'HARDIFLEX' CEMENT SHEETING


TRIMMERS LOCATED WITHIN 1200 MM OF EXTERNAL CORNERS TO BE SPACED @ 500 MM CENTERS, REMAINDER OF SHEET - 700 MM CENTERS



В

2025-88 A05 / A08

Date: Int: Accreditation No: CC2211T

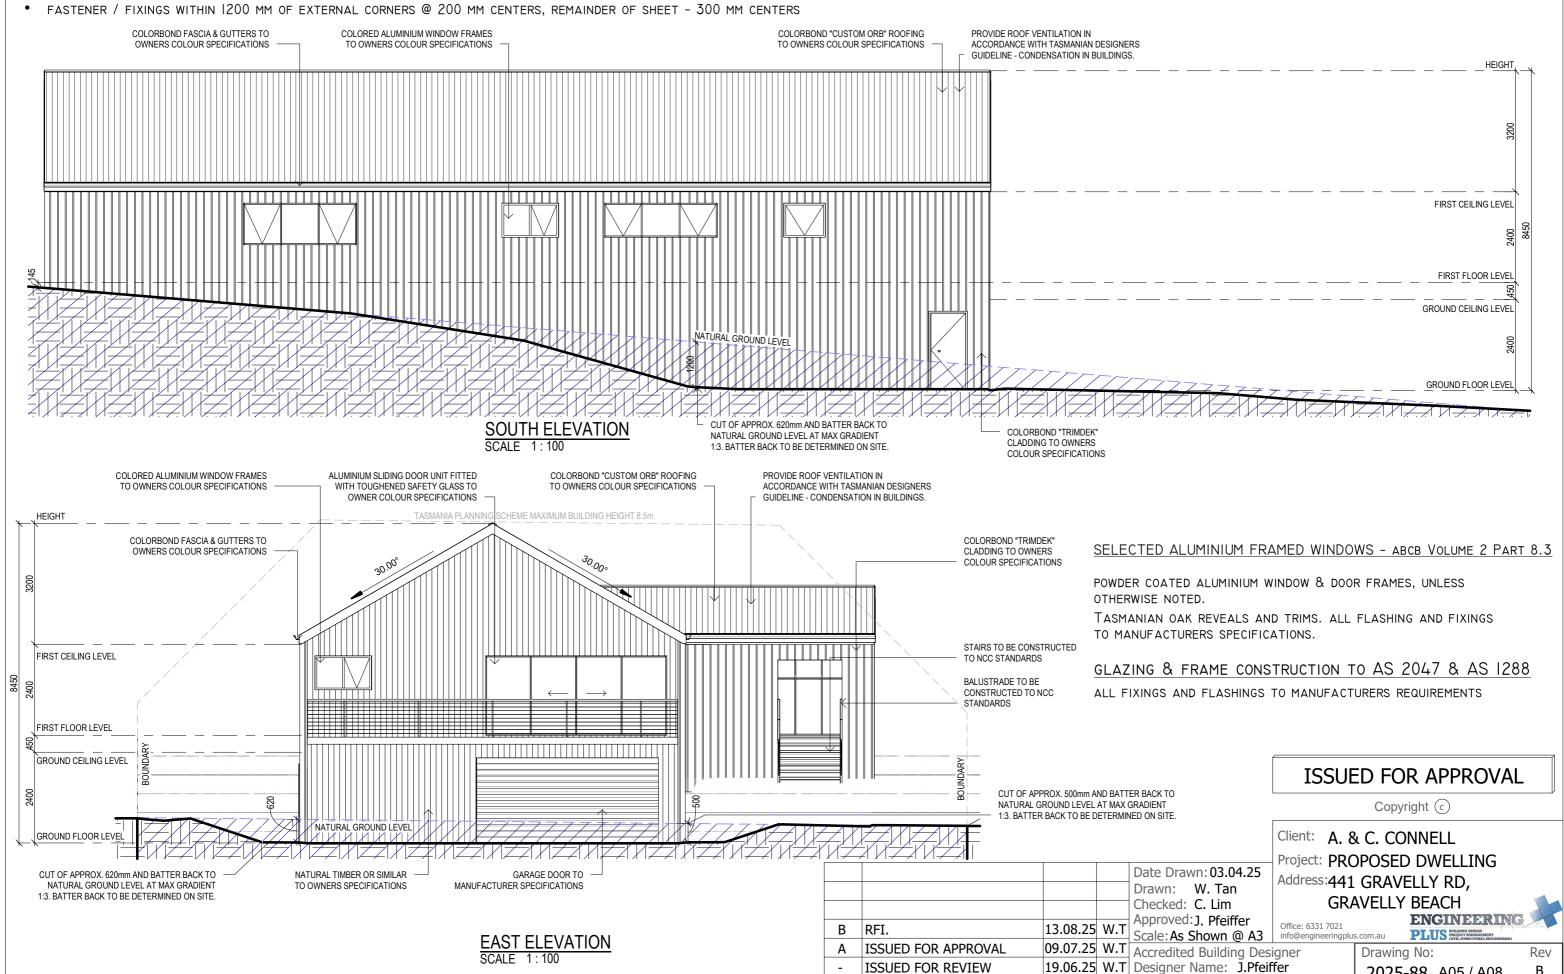

Rev: Amendment:

#### SUB FLOOR VENTILATION. NCC VOL 2 PART 6.2.1 A MINIMUM OF 150 MM OF SUB FLOOR CLEARANCE IS TO BE PROVIDED BETWEEN FINISHED SURFACE LEVEL & THE UNDERSIDE OF THE FLOOR BEAREN. A MINIMUM OF 6000 MM2 PER METRE OF SUB FLOOR VENTILATION IS TO BE UNIFORMLY DISTRIBUTED AROUND THE EXTERNAL AND INTERNAL WALLS OF THE BUILDING. VENTS TO BE LOCATED NO GREATER THAN 600 MM FROM AN INTERNAL OR EXTERNAL CORNER. PRYDA 230x75 - 52 HOLE VENT MAXIMUM SPACING 1050 MM ALONG WALL OR PRYDA 230x165 - 117 HOLE VENT MAXIMUM SPACING 2350 MM ALONG WALL PROVIDE ROOF VENTILATION IN COLORBOND FASCIA & GUTTERS TO COLORBOND "CLISTOM ORR" ROOFING ACCORDANCE WITH TASMANIAN DESIGNERS OWNERS COLOUR SPECIFICATIONS TO OWNERS COLOUR SPECIFICATIONS ADDITIONAL VENTILATION PROVISIONS TO BE INSTALLED WHERE OBSTRUCTIONS SUCH AS GUIDELINE - CONDENSATION IN BUILDINGS. CONCRETE VERANDAH'S, DECKS, PATIOS AND PAVING HEIGHT 4 ARE INSTALLED & OBSTRUCT VENTILATION. COLORED ALUMINIUM WINDOW FRAMES A06 3 TO OWNERS COLOUR SPECIFICATIONS 3 - W12 WINDOW ELEVATION A06 STAIR CONSTRUCTION. ABCB Volume 2 Part II.2 TREADS: 240 MM W14 RISERS: 180 MM TREATED PINE TIMBER STAIR MATERIAL TO ASI684 1018 FIRST CEILING LEVEL TREATMENT LEVELS H4 FOR INGROUND USE & H3 FOR ABOVE GROUND USE. ALL FIXINGS FITTING BRACKETS AND CONNECTORS TO BE GALVANISED. STRINGER: 300x50 F5 TREATED PINE FIRST FLOOR LEVEL • TREADS: 240x45 F5 TREATED PINE MAXIMUM TREAD SPAN 1000 NATURAL TIMBER OR SIMILAR COLORBOND "TRIMDEK" CLADDING TO ALUMINIUM SLIDING DOOR UNIT TO OWNERS SPECIFICATIONS OWNERS COLOUR SPECIFICATIONS FITTED WITH TOUGHENED SAFETY GLASS TO OWNER COLOUR SPECIFICATIONS 4 - W13 WINDOW ELEVATION WEST ELEVATION 5 COLORBOND FASCIA & GUTTERS TO COLORBOND "CUSTOM ORB" ROOFING PROVIDE ROOF VENTILATION IN ACCORDANCE WITH TASMANIAN DESIGNERS OWNERS COLOUR SPECIFICATIONS TO OWNERS COLOUR SPECIFICATIONS A06 **GUIDELINE - CONDENSATION IN BUILDINGS HEIGHT** FIRST CEILING LEVEL FIRST FLOOR LEVEL 5 - W11 WINDOW ELEVATION GROUND CEILING LEVEL SCALE 1:50 **ISSUED FOR APPROVAL** GROUND FLOOR LEVEL Copyright © COLORED ALUMINIUM WINDOW FRAMES COLORBOND "TRIMDEK" CLADDING TO BALUSTRADE TO BE CONSTRUCTED STAIRS TO BE CONSTRUCTED NATURAL TIMBER OR SIMILAR Client: A. & C. CONNELL OWNERS COLOUR SPECIFICATIONS Project: PROPOSED DWELLING Date Drawn: 03.04.25 NORTH ELEVATION Address:441 GRAVELLY RD, Drawn: W. Tan SCALE 1:100 **GRAVELLY BEACH** Checked: C. Lim

RFI.

Rev: Amendment:

ISSUED FOR APPROVAL

ISSUED FOR REVIEW

Drawing No: Rev 2025-88 A06 / A08 B

PLUS BUILDING DESIGN
PROJECT MANAGEMENT
CIVIL/STRUCTURAL ENG

Approved: J. Pfeiffer

09.07.25 W.T Accredited Building Designer


19.06.25 W.T Designer Name: J.Pfeiffer

Date: Int: Accreditation No: CC2211T

Scale: As Shown @ A3

**ENGINEER ING** 



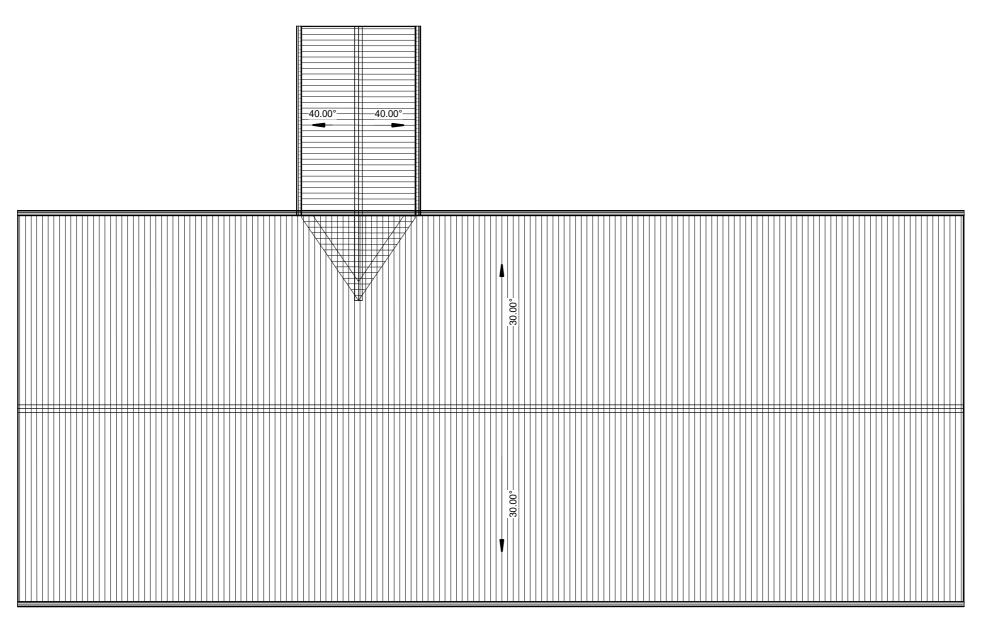

**ROOF PLAN** SCALE 1:100

#### ROOF CLADDING. NCC PART 7.2 SHEET ROOFING

COLORBOND 'CUSTOM ORB' METAL SHEETING INSTALLED IN ACCORDANCE WITH THIS PART, AS 1562.1 AND MANUFACTURERS RECOMMENDATIONS.

REFER TO LYSAGHT ROOFING & WALLING MANUAL FOR FULL DETAILS ON SHEET INSTALLATION, FIXINGS & FLASHINGS

#### COLORBOND 'CUSTOM ORB'

- MINIMUM PITCH 5 DEGREES.
- CORROSION PROTECTION IN ACCORDANCE WITH BCA TABLE 3.5.1.1.
- END LAP OF SHEETS

5-15 DEGREES - MINIMUM 200MM.

ABOVE 15 DEGREES - MINIMUM 150 MM.

- RIDGE LINE VALLEY TO BE TURNED UP (STOP ENDED).
- FASTENERS TO BE MADE OF COMPATIBLE MATERIAL WITH ROOFING MATERIAL.
- CREST FIXINGS OF END SPANS @ EVERY SECOND RIB AND INTERNAL SPANS @ EVERY THIRD RIB.
- WHERE POSSIBLE SHEETS TO BE LAID WITH SIDE LAPS FACING AWAY FROM PREVAILING WEATHER.
- REFLECTIVE FOIL INSULATION TO BE FITTED TO UNDERSIDE OF SHEETS.

R4.0 INSULATION BATTS TO ROOF SPACE ABOVE CEILING LINING.

RECOMMENDED FIXINGS FOR SEVERE EXPOSURE CONDITIONS TO AS 3566

USE CLASS 4 MATERIALS FOR SEVERE EXPOSURE & STAINLESS STEEL FOR VERY SEVERE COASTAL ENVIRONMENTS.

### **ISSUED FOR APPROVAL**

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Client: A. & C. CONNELL

Project: PROPOSED DWELLING Date Drawn: 03.04.25

Address:441 GRAVELLY RD, **GRAVELLY BEACH** 

ENGINEERING PLUS BUILDING DESIGN
PROJECT MANAGEMENT
CIVIL/STRUCTURAL ENGIS

13.08.25 W.T Scale: As Shown @ A3 | Office: 0.531 / O/L1 info@engineeringplus.com.au 09.07.25 W.T Accredited Building Designer Drawing No: 19.06.25 W.T Designer Name: J.Pfeiffer Date: Int: Accreditation No: CC2211T

Drawn: W. Tan

Checked: C. Lim Approved: J. Pfeiffer

B RFI.

Rev: Amendment:

A ISSUED FOR APPROVAL


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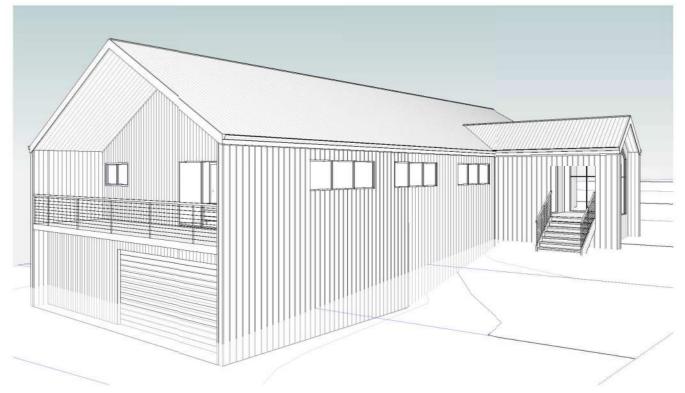
2025-88 A07 / A08


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Rev: Amendment:

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## **ISSUED FOR APPROVAL**

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Client: A. & C. CONNELL

Project: PROPOSED DWELLING Address: 441 GRAVELLY RD,

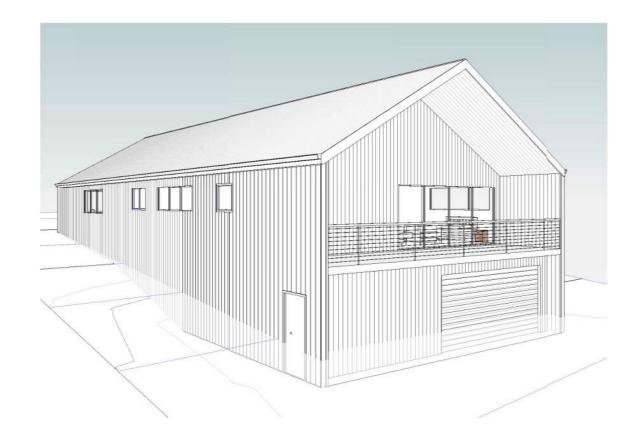GRAVELLY BEACH

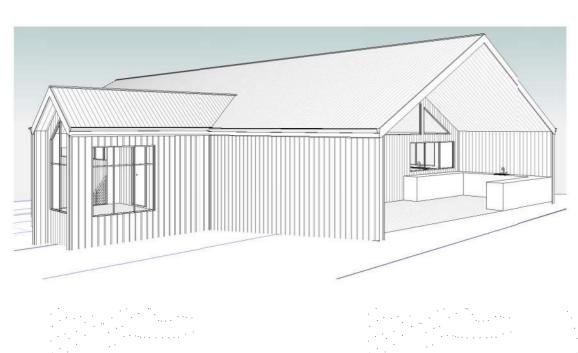17021: ENGINEERING DISION PLUS PROJECT MANAGEMENT CONFIDENCE MANAGEMENT

13.08.25 W.T

09.07.25 W.T

19.06.25 W.T

Drawn: W. Ian

Checked: C. Lim

Approved: J. Pfeiffer

Scale: As Shown @ A3

Accredited Building Designer

Designer Name: J.Pfeiffer

Accreditation No: CC2211T

Date Drawn: 03.04.25 Drawn: W. Tan

Drawing No: 2025-88 A08 / A08

Rev В









PH: 0429 199 934 www.reddogbushfire.com.au

VZ Designs Pty Ltd ABN 50 110 377 421 e: info@reddogbushfire.com.au PO Box 7647, Launceston

## **BUSHFIRE ASSESSMENT**

Client	Ashley Connell	Volume/Folio Number	140904/1
Site	441 Gravelly Beach Road, Gravelly Beach, Tas, 7276	PID	6069981
Report By	Jason Van Zetten	Accreditation	BFP113
Date	16/07/2025	Job Reference	8224



### **Proposal**

The proposal is for a new dwelling to be constructed on number 441(lot 8) Gravelly Beach Road.

Investigation reveal the title is an older title, searches on the LTO layer on the LIST and for the property report on the LIST did not show any prior records of subdivision between 2012 and now.

From the description of the proposed works it is believed that it fits into the highlighted requirements set out below in Table 4 of the Directors Determination.

Table 4 – requirements for Hazard Management Area – Directors Determination – Bushfire Hazard Areas version 1.2

	Element	Requirement
Α	New buildings on lots provided with a	A new building must:
	BAL at the time of subdivision.	(a) be provided with a HMA no smaller than the required separation distances required for BAL-
		19, except where a higher BAL was approved as part of the subdivision bushfire hazard
		management plan; and
		(b) have a HMA established in accordance with a certified bushfire hazard management plan.
В	New buildings on lots not provided	A new building must:
	with a BAL at the time of subdivision.	(a) be provided with a HMA no smaller than the required separation distances required for BAL-
		29; and
		(b) have a HMA established in accordance with a certified bushfire hazard management plan.
С	Alterations or additions to buildings.	An alteration or addition to a building must:
		(a) be located on the lot so as to be provided with a HMA which:
		(i) has the separation distances required for the BAL assessed for the construction of the existing
		building; or
		(ii) in the case of a building without an existing BAL assessment, is no smaller than the
		separation distances required for BAL-29; and
_	No buildings and additions and	(b) have a HMA established in accordance with a certified bushfire hazard management plan.
D	New buildings and additions and	A new building or an alteration or addition must:
	alterations to buildings classified as an accommodation building Class 1b,	(a) be located on the lot so as to be provided with HMAs no smaller than the separation distances required for BAL-12.5; and
	Class 2, or Class 3, other than	(b) have a HMA established in accordance with a certified bushfire hazard management plan.
	communal residence for persons with	(b) have a filling established in accordance with a certified businife hazard management plan.
	a disability, a respite centre or a	
	residential aged care facility or	
	similar.	
Е	New buildings and additions and	A new building or an addition or alteration including change of use must: (a) be located on the
	alterations to existing buildings	lot so as to be provided with HMAs no smaller than the separation distances required for BAL-
	classified as vulnerable use as defined	12.5; and
	in the relevant planning scheme.	(b) have a HMA established in accordance with a certified bushfire hazard management plan.
F	New buildings or additions and	A new building or an alteration or addition, including change of use, for a building associated
	alterations to buildings associated	with the use, handling, generation or storage of a hazardous chemical must:
	with the use, handling, generation or	(a) be located on the lot so as to be provided with a HMA no smaller than the required
	storage of a hazardous chemical or	separation distances for the BAL determined in the certified bushfire hazard management plan;
	explosive.	and
		(b) have a HMA established in accordance with a certified bushfire hazard management plan
G	Additional requirements for Certain	Refer to NCC Vol. 1 – Part G5 (incorporating TAS G5P1 and TAS G5P2) and Specification 43
	Class 9 Buildings and associated Class	
	10a Buildings and decks.	



#### **Site Description**

The site itself is an irregularly shaped 1400sqm lot which is located on the western side of Gravelly Beach Road at the intersection with Gatenbys Road, with Gatenbys Road being to the north of the lot. The site is surrounded by larger lifestyle lots in most directions with smaller residential style lots to the south/south east.

At the time of inspection the site was undergoing management and removal of large trees. Note, both the LIST and google mapping did not generally depict the nature of the site due to the canopy of large trees with have since been removed. It is assumed the dwelling will be reasonably centered on the site. However, if minimum distances of hazard management can be achieved on the site in line with what is listed in this report, the house can be moved east or west in accordance.

To the north of the site is Gatenbys Road and its predominately managed verge extending to around 16m from the works. Beyond the boundary is neighbouring grassland paddocks associated with a neighbouring property, extending along the west side of Gravelly Beach Road for around 250m with areas of grass and scrub extending to the north on the east side of Gravelly Beach Road for a similar distance. Beyond this, larger lots, mostly grassland paddocks, extend between Gravelly Beach Road and the Tamar River through to the southern end of Swan Point and the Tamar River, around 1km from the works.

To the east of the proposed dwelling is an area of grass with trees recently removed on the site itself which extends to the property boundary. Beyond the boundary is Gravelly Beach Road with its managed verges extending to around 25m from the lot. Beyond this are grassland paddocks, some areas of woodland and scrub, extending along each side of Little Swan Point Road for around 400m from the works. Beyond this, a mix of lifestyle lots with predominately managed gardens and smaller residential sites extend through to the Tamar River foreshore, around 850m from the works.

To the south of the proposed works existing grassland extends several metres to the property boundary. Beyond the boundary are similar sized neighbouring lots with mostly managed gardens extending around 200m to the south east with a larger forested lot extending to the south and south west for around 150m. Beyond this, heavier vegetation extends across larger sites which extend to about 350m where farming uses becomes the predominant feature extending across the western side of Gravelly Beach Village for around 1.8km through to Stoney Brook and Stoney Brook Road.

To the west of the proposed works is grassland and an area of the site which is a work in progress on the site itself which extends to the rear western lot property boundary, around 9.5m. Beyond the boundary is a neighbouring lot (same owner) with an area being cleared extending to around 50m from the site. Beyond this, a mix of managed and unmanaged larger lots, mostly around 1-2Ha extends up the gentle undulating hillside. Many of these lots have limited managed areas surrounding dwellings and other unmanaged areas which extend through to around 1.3km from the site to the western end of Gatenbys Road.



#### **Water Supply**

Several fire hydrants exist near the site. The nearest fire hydrant is located on Gatenbys Road, on the nature strip of the lot itself providing a full 120m hose lay over the site.

#### Access

There is no specific access to the site itself. The Building Act 2016 Directors Determination – Bushfire Hazard Areas, states that for property access length that is less than 30 metres, there are no specific design or construction requirements.

As Gatenbys Road is narrow it is recommended a hardstand area to be created on the site itself to ensure emergency vehicles do not block other road users in the case of an emergency.

#### **Opportunities & Constraints**

- 1. Management of both this lot and the owner's other lot to the west has resulted in a lesser vegetation classification for BAL
- 2. The adjacent road and its verses butting the site can be deemed low threat to AS3959/2018 2.2.3.2 (e) and (f).
- 3. At the time of inspection the site was being modified to a more manageable state.
- 4. Both the LIST and google mapping did not generally depict the nature of the site due to the canopy of large trees with have since been removed.
- 5. As the owner owns the block to the west, the opportunity exists to create a hazard management area over this lot by way of easement. Refer to conclusion.
- 6. The lot to the west (same owner) is a work in progress and the owners intend to return this to a managed state.



#### Conclusion

As the proposed works are within 100m of 1 hectare or greater of classifiable vegetation and the site is within a bushfire prone mapped area, a BAL assessment is required for the purpose of these works.

After consideration of the site and its mixed surroundings, it is deemed a BAL 12.5 classification can be adopted where a set back of 4.5m to the north boundary can be adopted where grassland extends beyond Gatenbys road as the predominant feature across 0–5-degree downslope. A hazard management area of 26m to the east either on the lot itself or measured from the eastern verge of Gravelly Beach Road can be adopted where woodland vegetation across a 0–5-degree downslope exists in the direction. A hazard management area extending to the boundary of the south where neighbouring low threat dwellings exist. With woodland classification across and upslope deemed the most appropriate to the west. As the distance form the dwelling to the rear boundary is only 9.5m, a BAL 40 classification would normally be adopted however, an opportunity arises as the owner owns the neighbouring lot to place a hazard management area extending 22m from the dwelling to the west on their site. This would need to be implemented on the schedule of easements as part of the title in line with the hazard management plan attached. This hazard management plan is therefore based on AS3959/2018 2.2.3.2 (e) and (f), table 2.3 and table 2.6.

Note, to achieve a BAL 12.5 classification, there is reliance upon implementing a hazard management area on the neighbouring lot by the same owner. This hazard management easement would replicate the hazard management plan attached. Whilst normal practice would be to do this prior to commencement of works, in this case this hazard management easement can be issued prior to issue of occupancy certificate assuming the owner does not sell the neighbouring lot.

#### BAL 12.5 to AS3959/2018

It is the responsibility of the accredited architect/designer to provide specific construction details to AS3959/2018 and fire fighting water supply and property access requirements on the plans, as per this report for approval in line with the requirements setout in CBOS schedule 1. Water supply and property access details can be copied from this report and hazard management plan without fear of copyright.



#### **Bushfire Hazard Management Plan**

The attached Bushfire Hazard Management Plan must be implemented prior to occupation of the new works.

Failure to meet the requirements of this report may invalidate your insurance policy in the event of a bushfire.


The highlighted area is required to be maintained as per the plan and in line with AS3959/2018.

#### Limitations

This report only deals with potential bushfire risk and all other statutory assessments are outside this report. All information provided was as at the time of inspection of the site, and this report is not to be used for further or future development of the site other than what has been provided by the plans attached. This report and/or management plan does not guarantee that the building will survive a bushfire.

#### **Bushfire Mapping**

This site is considered bushfire prone as per LISTmap.

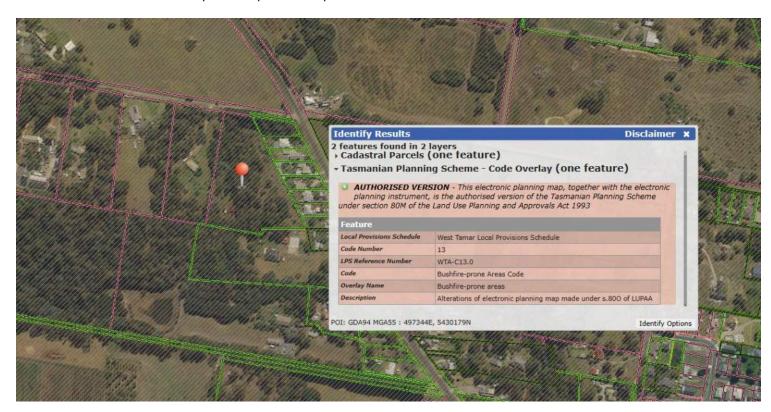



Vegetation classification AS3959	North	East	South	West
Group A	Forest	Forest	Forest	Forest
Group B	Woodland	Woodland	Woodland	Woodland
Group C	Shrub-land	Shrub-land	Shrub-land	Shrub-land
Group D	Scrub	Scrub	Scrub	Scrub
Group E	Mallee-Mulga	Mallee-Mulga	Mallee-Mulga	Mallee-Mulga
Group F	Rainforest	Rainforest	Rainforest	Rainforest
Group G	Grassland	Grassland	Grassland	Grassland
Predominant Feature	Grassland	Woodland	Woodland	Woodland
Excluded	Gatenbys Road	Gravelly Beach Road	Residential Dwellings	
Effective slope	Up/0º	Up/0°	Up/0⁰	Up/0°
(degrees)	>0-5°	>0-5 <sup>0</sup>	>0-5°	>0-5 <sup>0</sup>
	>5-10 <sup>0</sup>	>5-10°	>5-10 <sup>0</sup>	>5-10 <sup>0</sup>
	>10-15 <sup>0</sup>	>10-15 <sup>0</sup>	>10-15 <sup>0</sup>	>10-15 <sup>0</sup>
	>15-20 <sup>0</sup>	>15-20 <sup>0</sup>	>15-20 <sup>0</sup>	>15-20 <sup>0</sup>
Distance to classified vegetation	15 metres	20 + metres	20 + metres	9 metres
Distance Required for Onsite Bushfire Hazard Management	To Boundary	26 metres	To Boundary	22 metres ( see conclusion)
Likely direction of bushfire attack	North	East	South	West
Prevailing winds	North	East	South	West
BAL Value (FDI 50)	BAL – 12.5	BAL – 12.5	BAL – 12.5	BAL – 12.5

The values have been achieved from the location proposed, within the constraints of the site. If the location or nature of the proposal is to be altered for any reason this report will need to be amended to suit



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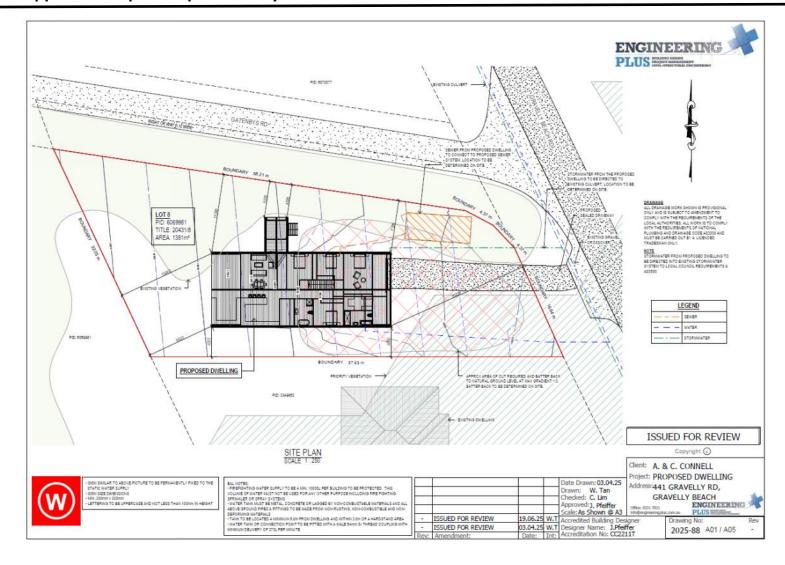
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## **Appendix 1: General Overview of Bushfire Attack Level Classifications**


BAL – LOW	The risk is considered to be VERY LOW.  There is insufficient risk to warrant any specific construction requirements but there is still some risk.
BAL – 12.5	The risk is considered to be LOW.  There is a risk of ember attack. The construction elements are expected to be exposed to a heat flux not greater than 12.5 kW/m².
BAL – 19	The risk is considered to be MODERATE.  There is a risk of ember attack and burning debris ignited by windborne embers and a likelihood of exposure to radiant heat. The construction elements are expected to be exposed to a heat flux not greater than 19 kW/m².
BAL – 29	The risk is considered to be HIGH.  There is an increased risk of ember attack and burning debris ignited by windborne embers and a likelihood of exposure to an increased level of radiant heat. The construction elements are expected to be exposed to a heat flux not greater than 29 kW/m².
BAL - 40	The risk is considered to be VERY HIGH.  There is a much increased risk of ember attack and burning debris ignited by windborne embers, a likelihood of exposure to a high level of radiant heat and some likelihood of direct exposure to flames from the fire front. The construction elements are expected to be exposed to a heat flux not greater than 40 kW/m².
BAL – FZ	The risk is considered to be EXTREME.  There is an extremely high risk of ember attack and burning debris ignited by windborne embers, and a likelihood of exposure to an extreme level of radiant heat and direct exposure to flames from the fire front. The construction elements are expected to be exposed to a heat flux greater than 40 kW/m².



### Appendix 2 - plan as provided by client





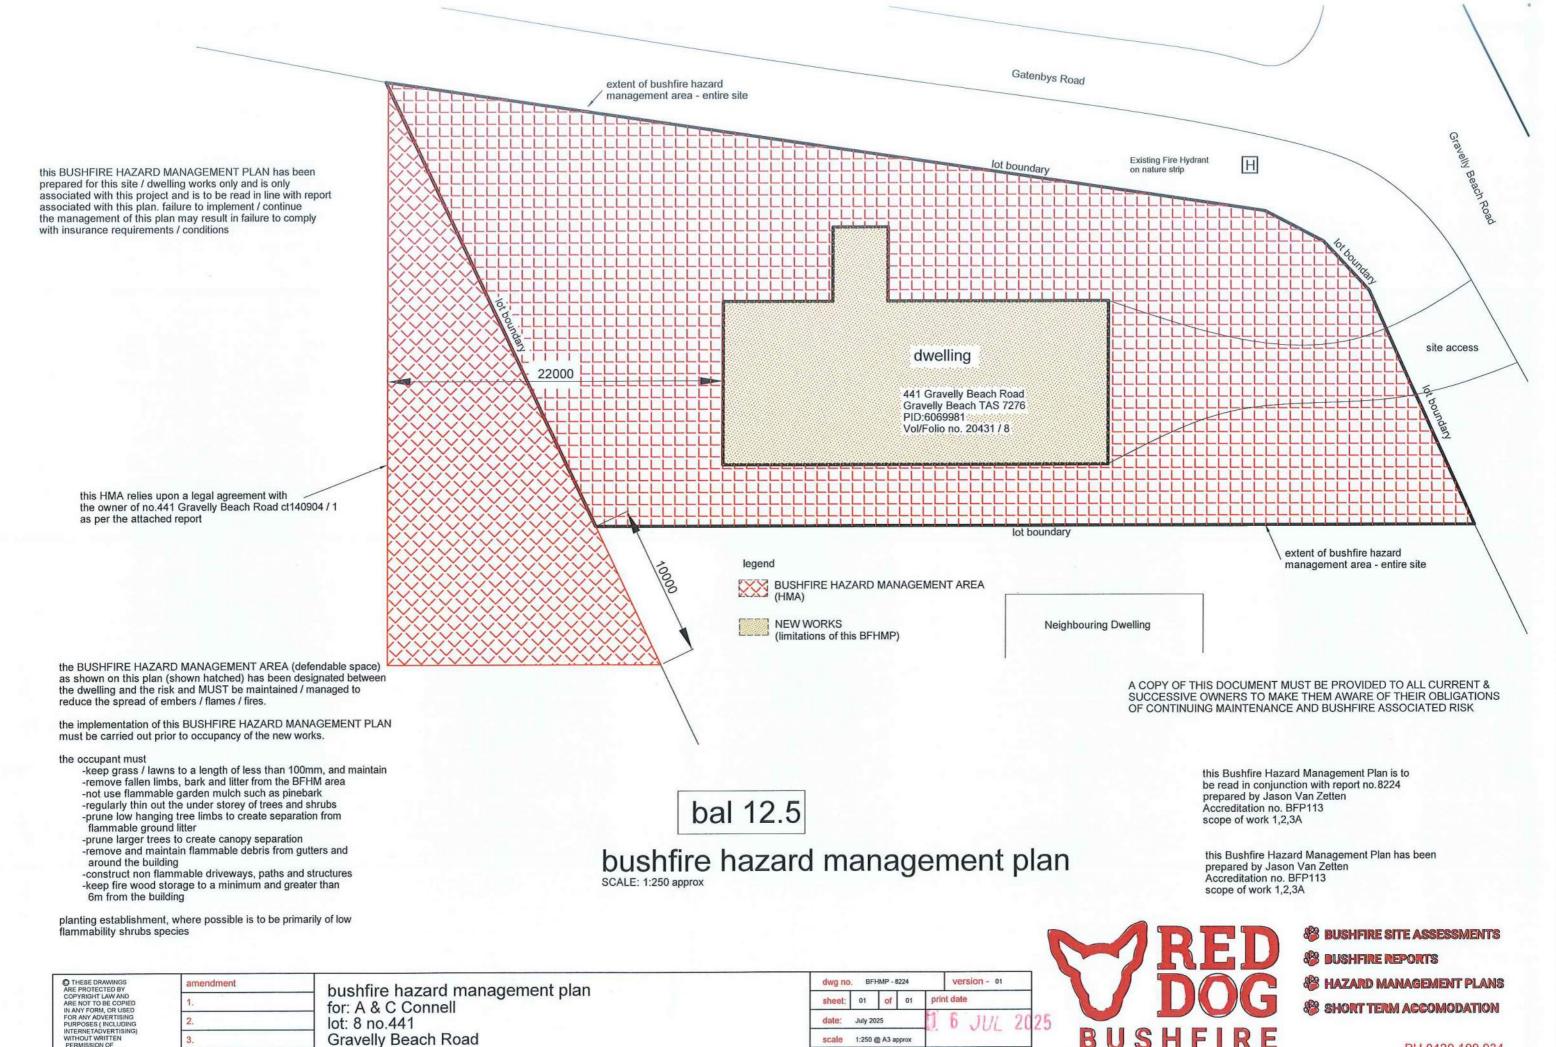

bal

12.5

drawn: JVZ

Gravelly Beach

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