Eden Street Riverside Tasmania 7250 Telephone: (03) 6323 9300 Facsimile: (03) 6323 9349

4. Other:



PLANNING APPLICATION FORM

Section 57 & 58

OFFICE USE ONLY

Application Number
Assess No:
PID No:

PA2025314 A153 6034068

Applicant Name:	BVZ Designs			
Postal Address:				
Contact Phone:	Home	Work	Mobile	
Email Address:	1			

Planning Application Lodgement Checklist

The	foll	owing documents have been submitted to support the consideration of this application:	
1.	Αcι	arrent copy of the property title text, folio plan and schedule of easements	
2.	A co	ompleted application form including a detailed description of the proposal	
3.	A co	omplete plan set:	
	a)	Floor plans	
	b)	Elevations (from all orientations/sides and showing natural ground level and finished surface level)	
	c)	Site Plan showing:	
	0	Orientation	
	ø	All title boundaries	
	0	Location of buildings and structure (both existing and proposed)	
	•	Setbacks from all boundaries	
	0	Native vegetation to be removed	
	0	Onsite services, connections and drainage details (including sewer, water and stormwater)	
	ø	Cut and/or Fill	
	e	Car parking and access details (including construction material of all trafficable areas)	
	•	Fence details	
	•	Contours	

If submitting plans in over the counter please ensure they are A3.

All plans must be to scale.

WEST TAMAR COUNCIL



Application Number: «Application Number»

	APPLICANT DETAILS			
Applicant Name:	Bradley van Zetten			
Note: Full name((s) of person(s) or company making the application and postal address for correspondence.			
3. 含. R. (A. (A. (A. (A.)))	LAND DETAILS			
Owner/Authority Name: (as per certificate of title)	BRYN NORTON 19 ANTHONY ST TREVAUYN 7250			
Location / Address:	19 ANTHONY ST TREVAUN 7250			
Title Reference:	72334/1/			
Zone(s):	GEN RES			
Existing Development/Use:	RESIDENTAL OWELLING			
Existing Developed Area:	Area 80			
	DEVELOPMENT APPLICATION DETAILS			
Proposed Use:	Residential: □ Visitor Accommodation: □ Commercial: □ Other: □ Description of Use: CESIOENTAL EXTENSION			
	Building work: ☐ Demolition: ☐ Subdivision: ☐ Other: ☐			
Development Type:	Description of development:			
New or Additional Area:	Area 77. İ			
Estimated construction cost proposed development:	STATE OF THE PARTY			
Building Materials:	Wall Type: CEMENT SHEET Colour: Neutrals/ grays Roof Type: COLORBINO Colour: Neutrals/ grays			

WEST TAMAR COUNCIL



Application Number: «Application Number»

	SUBDIVISION	■N/A		
		Subdivision creating additional lots ent with no additional lots created		
Number of Lots (existing):	Number of Lots (proposed) :			
Description:				
If applying for a subdivision which c		ee proposed names for the road(s), in order of		
1.	preference:			
2.				
3.				
COMMERCIAL, II	NDUSTRIAL OR OTHER NON-RESI	IDENTIAL DEVELOPMENT/USE IN/A		
	Monday / Friday:	То		
Hours of Operation:	Saturday:	То		
	Sunday:	То		
Existing Car Parking:				
Proposed Car Parking:				
Number of Employees: (Existing)				
Number of Employees: (Proposed)				
Type of Machinery installed:				
Details of trade waste and method of disposal:				

WEST TAMAR COUNCIL



Application Number: «Application Number»

	ers to conduct inspections as required for		
	Name (print)	Signed	Date
	ne applicant, I declare that I have notified to Information contained in this application is		
Br	adley van Zetten	BVIIIII Signed	27/9/2 Date
	Minister, or a delegated officer of the Cro	own with a copy of the delegation.	
Crown	에는 것이 많은 "나는 경이지를 모아나 아니아 아이들에 나타나를 본 그를 맞는데 아이들이 얼마나 아니는데 얼마를 했다. 그리고 사는 그림은 그를 모르는데 그 그를 했다.	own with a copy of the delegation.	
Crown Consent (if required)	에는 것이 많은 "나는 경이지를 모아나 아니아 아이들에 나타나를 본 그를 맞는데 아이들이 얼마나 아니는데 얼마를 했다. 그리고 사는 그림은 그를 모르는데 그 그를 했다.	own with a copy of the delegation. Signed	Date
Crown Consent (if required) General	Minister, or a delegated officer of the Cro		Date
Crown Consent (if required)	Minister, or a delegated officer of the Cro		Date
Crown Consent (if required) General Manager (if required)	Minister, or a delegated officer of the Cro	Signed	Date
Crown Consent (if required) General Manager (if required)	Name (print) Name (print) is accessed via a right of way, the owner of the Cro	Signed	Date



BRADLEY VAN ZETTEN

4 EDEN HILLS DRIVE

RIVERSIDE 7250

P. 0407 272 381

E. BVZDESIGNS@GMAIL.COM

LICENCE NUMBER 957699796

Reply to the planning scheme for 19 Anthony Street Trevallyn 7250 72339/11

8.4 Development Standards for Dwellings

8.4.1 Residential density for multiple dwellings

A1 - Acceptable solution compliant

8.4.2 Setbacks and building envelope for all dwellings

P1

The proposed extension is designed to ensure a setback from the frontage that is compatible with the streetscape, taking into account the site's unique topographical constraints. The extension is positioned 4 metres from the front boundary at its closest point, which is 0.5 metres within the acceptable solution of 4.5 metres. This minor deviation is necessitated by the irregularly shaped block, which features two front boundary dimensions due to its location at the end of a cul-de-sac. The unusual block configuration, with no square boundaries, presents a topographical constraint that justifies this approach.

At the kink in the boundary, the extension achieves a compliant setback of 4.5 metres, with a maximum setback of 5.7 metres elsewhere, resulting in an average setback exceeding the acceptable solution. This ensures the dwelling maintains a harmonious relationship with the streetscape, blending seamlessly with neighbouring properties. Given the cul-de-sac's curved layout, the 4-metre setback at one corner is unlikely to be visually prominent or disrupt the streetscape's aesthetic. The design respects the topographical challenges while aligning with the established character of the area, ensuring compatibility with surrounding dwellings.

- A2 Acceptable solution compliant
- A3 Acceptable solution compliant
- 8.4.3 Site coverage and private open space for all dwellings
- A1 Acceptable solution compliant
- A2 Acceptable solution compliant
- 8.4.4 Sunlight to private open space of multiple dwellings
- A1 Acceptable solution compliant
- 8.4.5 Width of openings for garages and carports for all dwellings
- A1 Acceptable solution compliant



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8.4.6 Privacy for all dwellings A1 – Acceptable solution compliant

P2

The proposed development includes one window (W6) that does not meet the acceptable solution, as it is located in a habitable room (a bedroom) with a floor level more than 1 metre above existing ground level. However, the design ensures compliance with the performance criterion by minimising direct views to neighbouring properties. A substantial hedge along the property boundary at 17 Anthony Street provides a natural screen, effectively obstructing views from W6 into any windows, glazed doors, or private open spaces of the neighbouring dwelling. This existing vegetation ensures privacy for both the proposed dwelling and the neighbouring property, mitigating any potential overlooking concerns

Additionally, W6 is located within a bedroom, a habitable room used less frequently than communal areas like living rooms, reducing the likelihood of privacy impacts. The window's placement and the hedge's screening align with the streetscape's character, maintaining neighbourly amenity. No additional screening is required, as the existing hedge adequately addresses the criterion's requirements, ensuring minimal direct views and preserving privacy for both properties.

A3 - Acceptable solution compliant

 $8.4.7\ Frontage\ fences\ for\ all\ dwellings$

A1 - Acceptable solution compliant

8.4.8 Waste storage for multiple dwellings

A1 - Acceptable solution compliant

Kind Regards

Bradley Van Zetten




FOLIO PLAN

RECORDER OF TITLES



Issued Pursuant to the Land Titles Act 1980

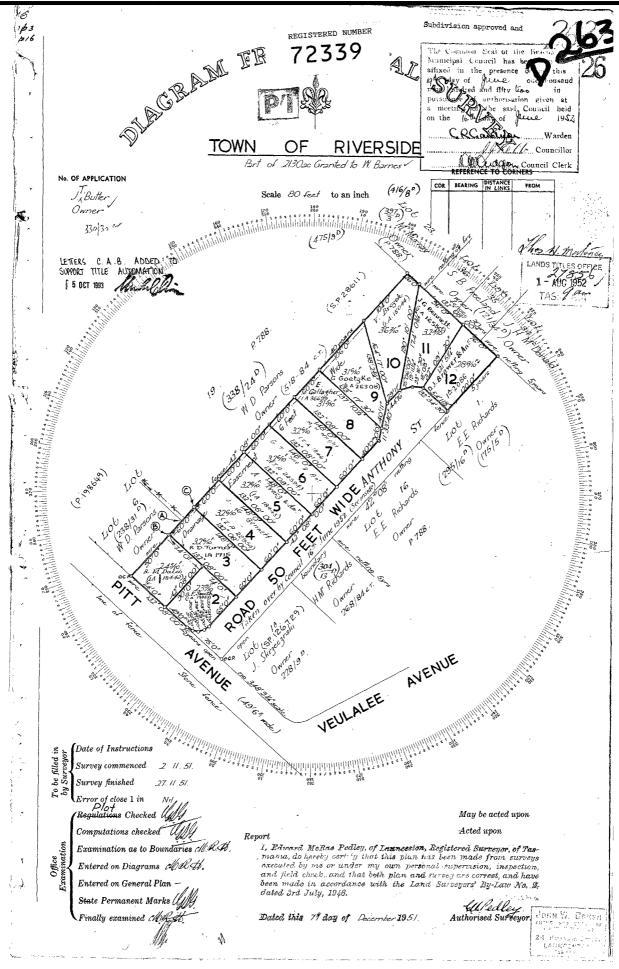

Search Date: 18 Apr 2022

Search Time: 01:08 PM

Volume Number: 72339

Revision Number: 01

PAGE 1# COVER PAGE PAGE 2# LOCALITY PLAN PAGE 3# SITE PLAN PAGE 4# EXISTING FLOOR PLAN PAGE 5# EXISTING ELEVATIONS PAGE 6# PROPOSED FLOOR PLAN PAGE 7# PROPOSED ELEVATIONS PAGE 8# ROOF PLAN PAGE 9# SECTION A---A PAGE 10# SECTION B---B PAGE 11# BRACING PLAN PAGE 12# BRACING DETAILS PAGE 13# PLUMBING PLAN PAGE 14# WET AREA ENLARGEMENT PLAN PAGE 15# SOIL AND WATER MANAGEMENT PLAN PAGE 16# PLUMBING DETAILS PAGE 17# LIVABLE HOUSING DESIGN PAGE 18# LIVABLE HOUSING DESIGN PAGE 19# WINDOWS AND DOORS PAGE 20# INSULATION PLAN PAGE 21# ENERGY EFFICIENCY DETAILS PAGE 22# CONDENSATION MANAGEMENT PAGE 23# GENERAL NOTES PAGE 24# CORROSION PROTECTION PAGE 25# SAFETY NOTES PAGE 26# STAIRS AND BALUSTRADES PAGE 27# WET AREA DETAILS PAGE 28# WET AREA DETAILS PAGE 29# WET AREA DETAILS PAGE 30# FLOOR FRAMING PLAN PAGE 31# ROOF FRAMING PLAN PAGE 32# FOOTING LAYOUT PAGE 33# ENGINEERING DETAILS

COUNCIL - WEST TAMAR COUNCIL ZONE - GENERAL RESIDENTIAL CODE - NIL LANDSLIDE BAND - NIL

TITLE REF. = 72339/11

WIND CLASSIFICATION N2 DESIGN GUST SPEED (VU) 40M/S

SITE CLASS H1 AS PER AS2870

BUSHFIRE-PRONE AREA BAL RATING N/A

CLIMATE ZONE FOR THERMAL DESIGN = 7

ALPINE AREA - N/A LESS THAN 900m AHD

CORROSION ENVIRONMENT - MODERATE

OTHER HAZARDS - N/A

PROPOSED EXTENSION FOR B NORTON AT 19 ANTHONY STREET TREVALLYN 7250

ALPINE AREA - N/A LESS THAN 900m AHD

OTHER HAZARDS - N/A

ALL DIMENSIONS SHOWN ARE TO OUTSIDE OF BRICKWORK CLADDING OR TIMBER FRAMING ON CLAD HOUSES UNLESS NOTED OTHERWISE

CONFIRM ALL DIMENSIONS AND SERVICES ON SITE
PRIOR TO COMMENCEMENT OF WORKS

IF IN ANY DOUBT ABOUT BEARING AND BOUNDARIES
THEN THESE MUST BE CONFIRMED ONSITE BY A
SURVEYOR PRIOR TO SETOUT

ENSURE DRAWINGS USED ONSITE ARE STAMPED 'APPROVED' PLANS BY BUILDING SURVEYOR AND PERMIT AUTHORITY

H4D9 CONDENSATION MANAGEMENT TO BE COMPLIANT WITH NCC PART 10.8 CONDENSATION MANAGEMENT.
NOTES

(1)REFER TO THE GUIDANCE IN THE "CONDENSATION IN BUILDINGS TASMANIAN DESIGNERS' GUIDE" — CURRENT VERSION AVAILABLE AT WWW.CBOS.TAS.GOV.AU. THIS GUIDE MUST BE READ IN CONJUNCTION WITH THE NCC.

IF ANY DISCREPANCIES, APPARENT ERROR, ANOMALY OR AMBIGUITY WITHIN THE DOCUMENTATION IS FOUND. THE DESIGNER IS TO BE CONTACTED PRIOR TO ANY MORE CONSTRUCTION CONTINUING.

ENSURE THAT DRAWINGS ARE NOT SCALED AND THAT THE NOTED DIMENSIONS ARE USED FOR ACCURACY. IF IN ANY DOUBT CONTACT DESIGNER

DESIGNS


BRADLEY VAN ZETTEN


4 EDEN HILLS DRIVE RIVERSIDE 7250 P. 0407 272 381 E. BVZDESIGNS@GMAIL.COM LICENCE NUMBER 957699796

C) BRADLEY VAN ZETTEN 2025

THE DESIGN, DETAILS AND SPECIFICATIONS ON THIS PLAN ARE PROJECT SPECIFIC AND MUST NOT BE USED ON ANY OTHER WITHOUT EXPRESS PERMISSION OF THE AUTHOR.

REVISION NUMBER	DATE
REVISION 1	01 / 05 / 2022
REVISION 2	23 / 05 / 2022
REVISION 3	05 / 06 / 2022
REVISION 4	11 / 09 / 2022
REVISION 5	18 / 04 / 2023
REVISION 6	07 / 09 / 2025
REVISION 7	15 / 09 / 2025
REVISION 8	27 / 09 / 2025

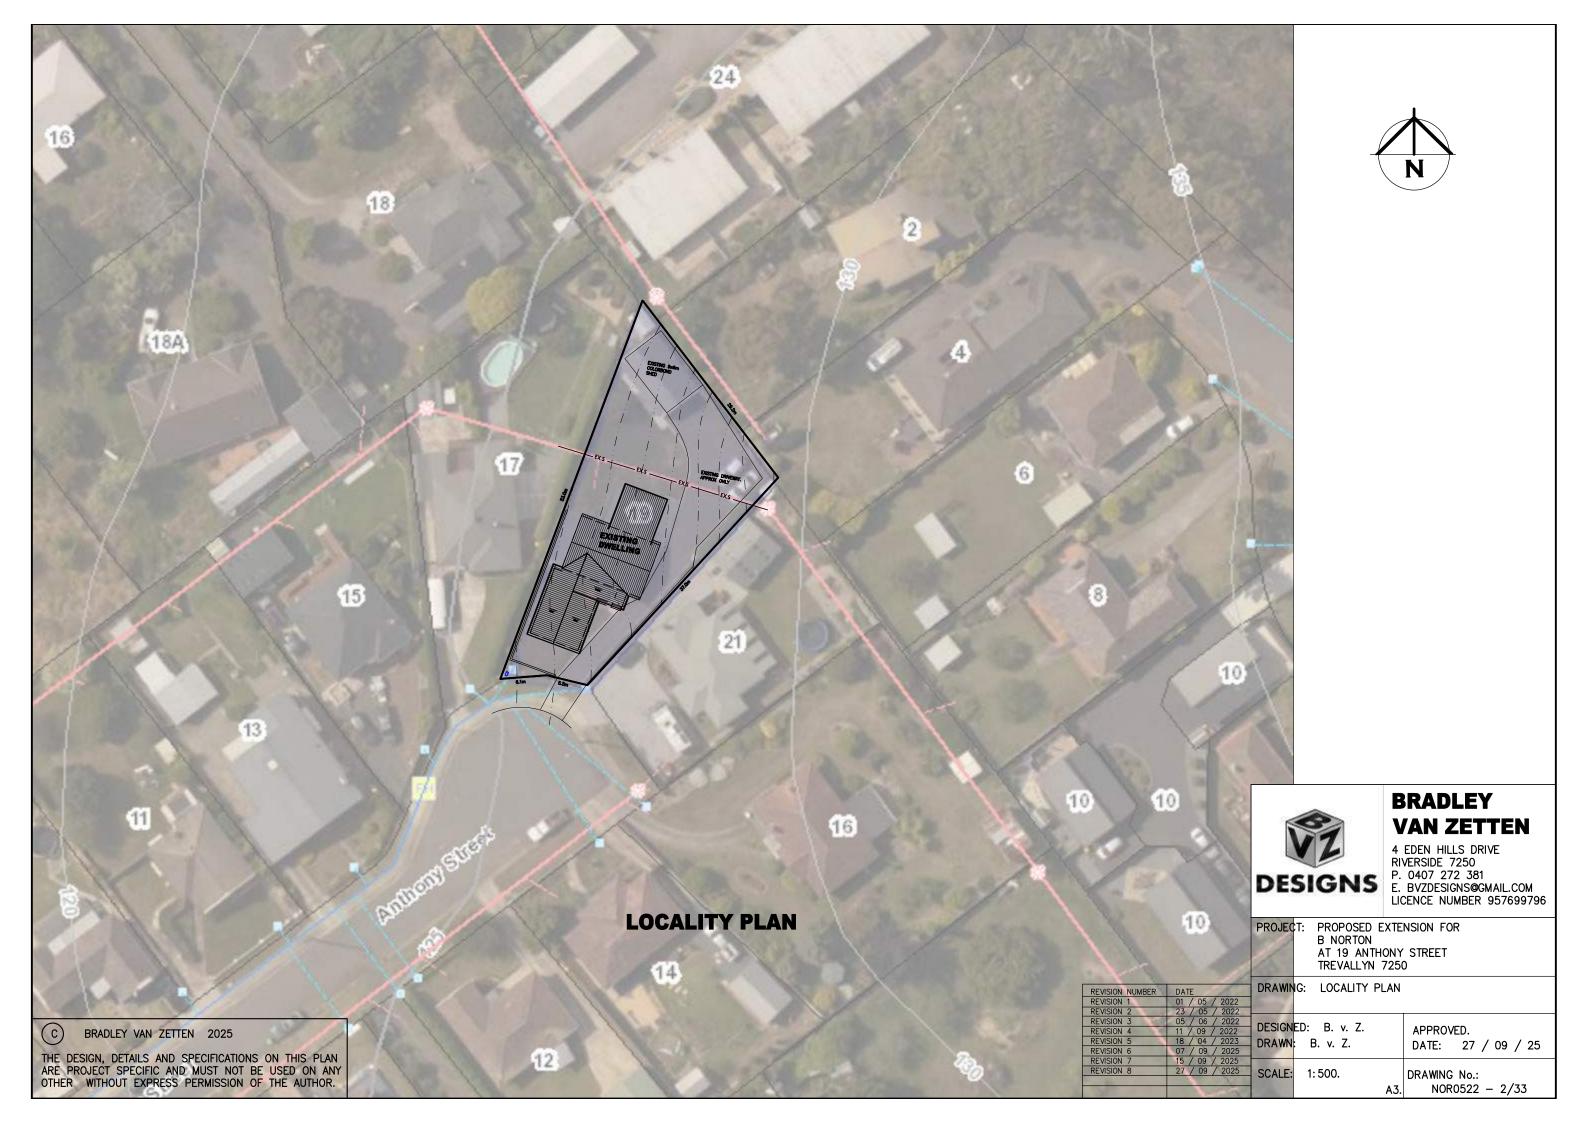

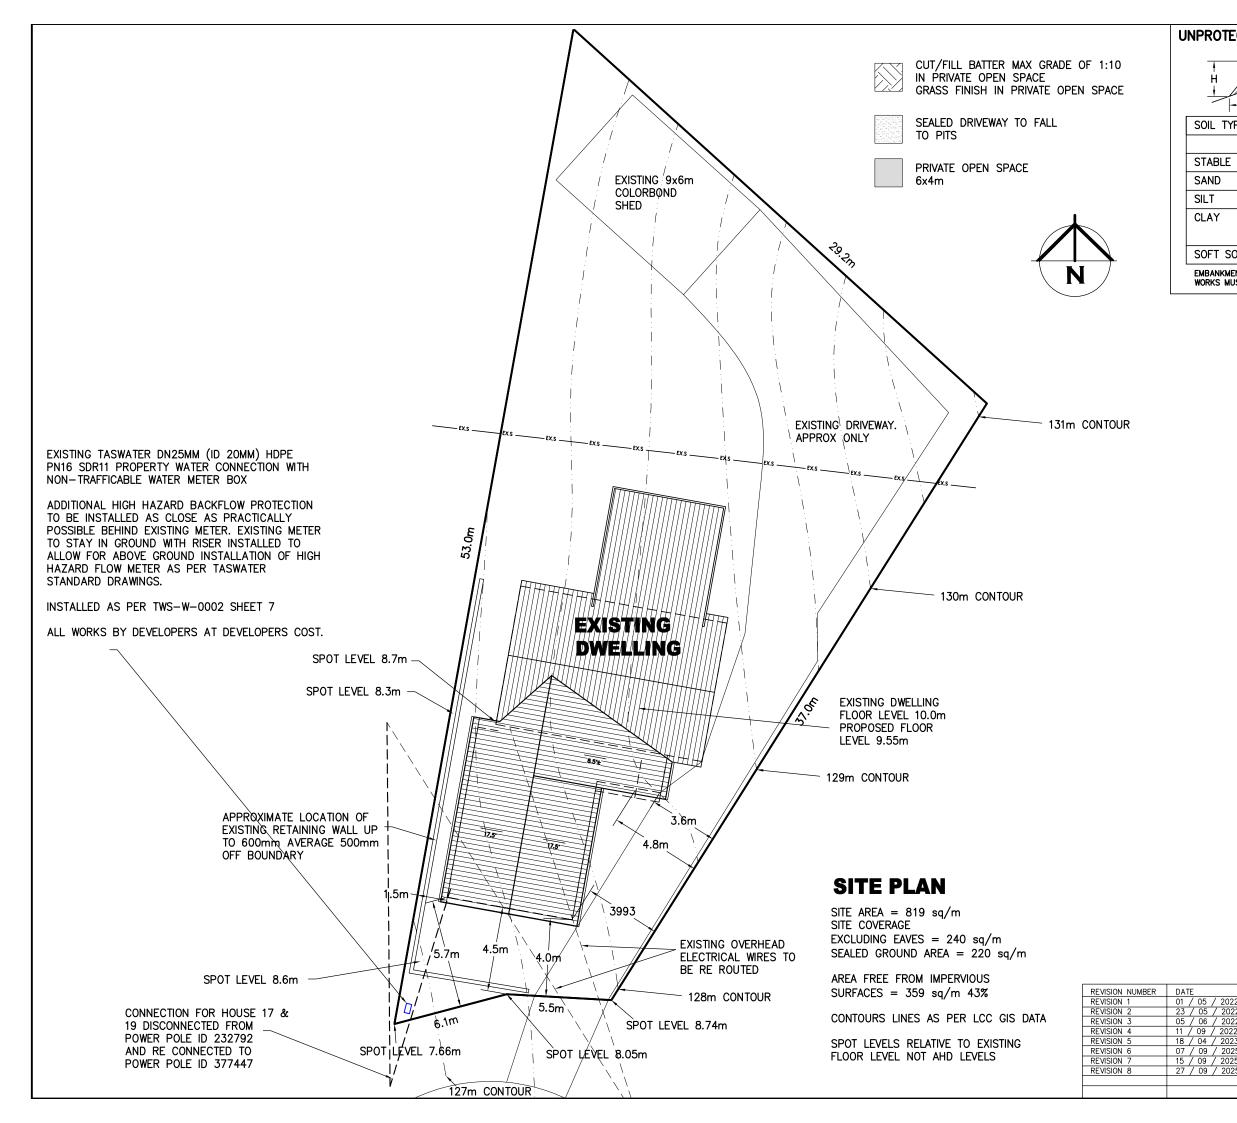

UNPROTECTED EMBANKMENTS 3.1.1.1



SOIL TYPE	SOIL TYPE EMBANKMENT SLOPES H: L		
		COMPACTED FILL	CUT
STABLE ROCK		2: 3	8:1
SAND		1: 2	1:2
SILT		1: 4	1: 4
CLAY FIRM CLAY		1: 2	1:1
SOFT CLAY		NOT SUITABLE	2: 3
SOFT SOILS		NOT SUITABLE	NOT SUITABLE

CUT

EMBANKMENTS THAT ARE TO BE LEFT EXPOSED AT THE END OF THE CONSTRUCTION WORKS MUST BE STABILISED BY VEGETATION OR SIMILAR TO PREVENT SOIL EROSION

FALL PREVENTION

WHERE A PERSON IS EXPOSED TO THE HAZARD OF FALLING FROM A STRUCTURE DURING CONSTRUCTION, CLEANING OR MAINTENANCE WORK THE BUILDER SHALL PROVIDE:

(A) A WORK SYSTEM DESIGNED TO PREVENT SUCH A

(B) WHERE SAFETY BELT ANCHORAGE POINTS ARE ÙSED THEY MUST BE POSITIONED SUCH THAT THE SAFETY LINE CAN BE ATTACHED BEFORE PROCEEDING TO THE AREA WHERE A FALL IS POSSIBLE

(C) ANCHORAGE POINTS MUST COMPLY WITH AS2626 ÀND BE ABLE TO WITHSTAND A FORCE OF 1500KG (D) INFORM THE OWNER PRIOR TO OCCUPANCY THE NATURE OF THE FALL ARREST SYSTEM AND USE



ACCORDING TO AS2626.

BRADLEY VAN ZETTEN

4 EDEN HILLS DRIVE RIVERSIDE 7250 P. 0407 272 381 DESIGNS P. 0407 272 381 E. BVZDESIGNS@GMAIL.COM LICENCE NUMBER 957699796

PROJECT: PROPOSED EXTENSION FOR **B NORTON** AT 19 ANTHONY STREET


TREVALLYN 7250

DRAWING: SITE PLAN

DESIGNED: B. v. Z. APPROVED. DRAWN: B. v. Z. DATE: 27 / 09 / 25

SCALE: 1:200. DRAWING No.:

NOR0522 - 3/33

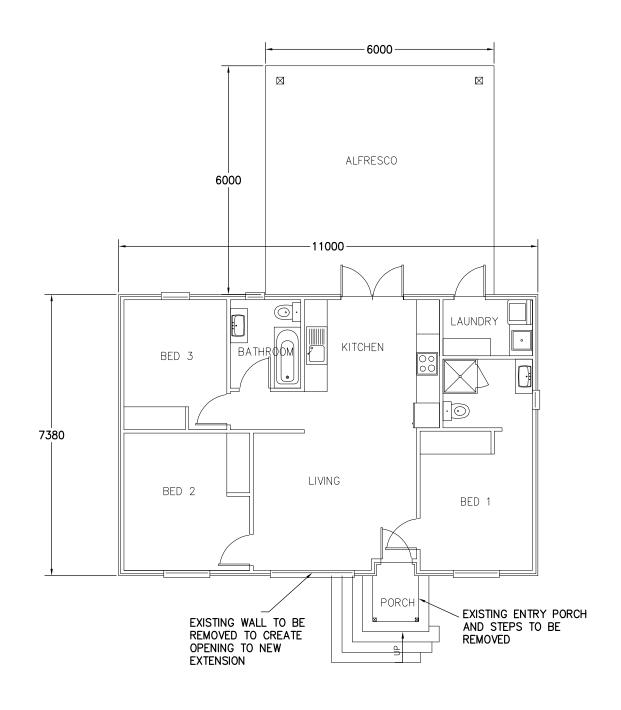

EXISTING FLOOR PLAN

EXISTING FLOOR AREA = 80.7 sq/mEXISTING ALFRESCO AREA = 36.0 sq/m EXISTING DIMENSIONS TO BE CONFIRMED ONSITE



BRADLEY VAN ZETTEN 2025

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BRADLEY VAN ZETTEN

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PROJECT: PROPOSED EXTENSION FOR B NORTON

AT 19 ANTHONY STREET TREVALLYN 7250

 REVISION NUMBER
 DATE

 REVISION 1
 01 / 05 / 2022

 REVISION 2
 23 / 05 / 2022

 REVISION 3
 05 / 06 / 2022

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 18 / 04 / 2023

 REVISION 6
 07 / 09 / 2025

 REVISION 7
 15 / 09 / 2025

 REVISION 8
 27 / 09 / 2025

DRAWING: EXISTING FLOOR PLAN


DESIGNED: B. v. Z. DRAWN: B. v. Z.


APPROVED. DATE: 27 / 09 / 25


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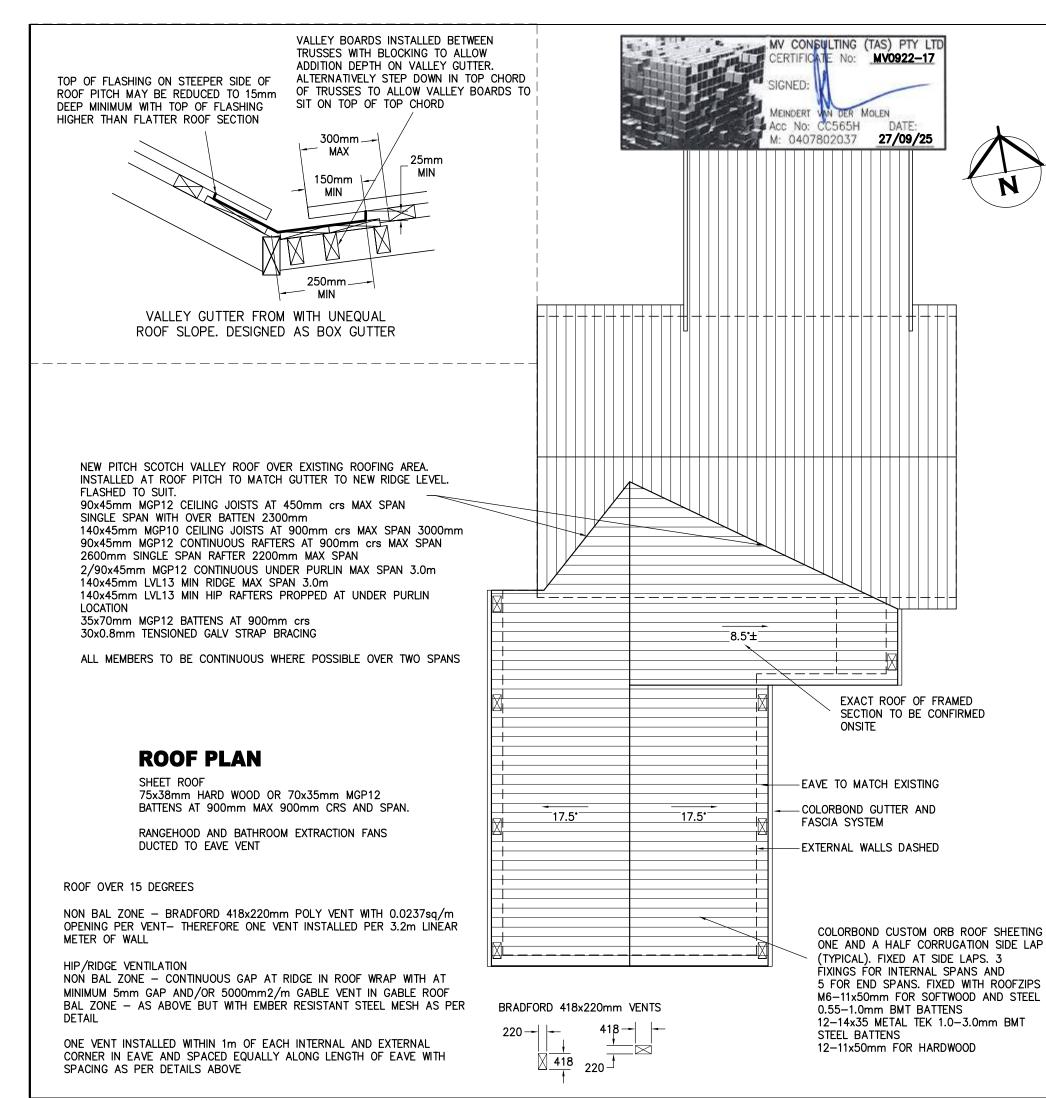
DRAWING No.:

NOR0522 - 4/33 A3.



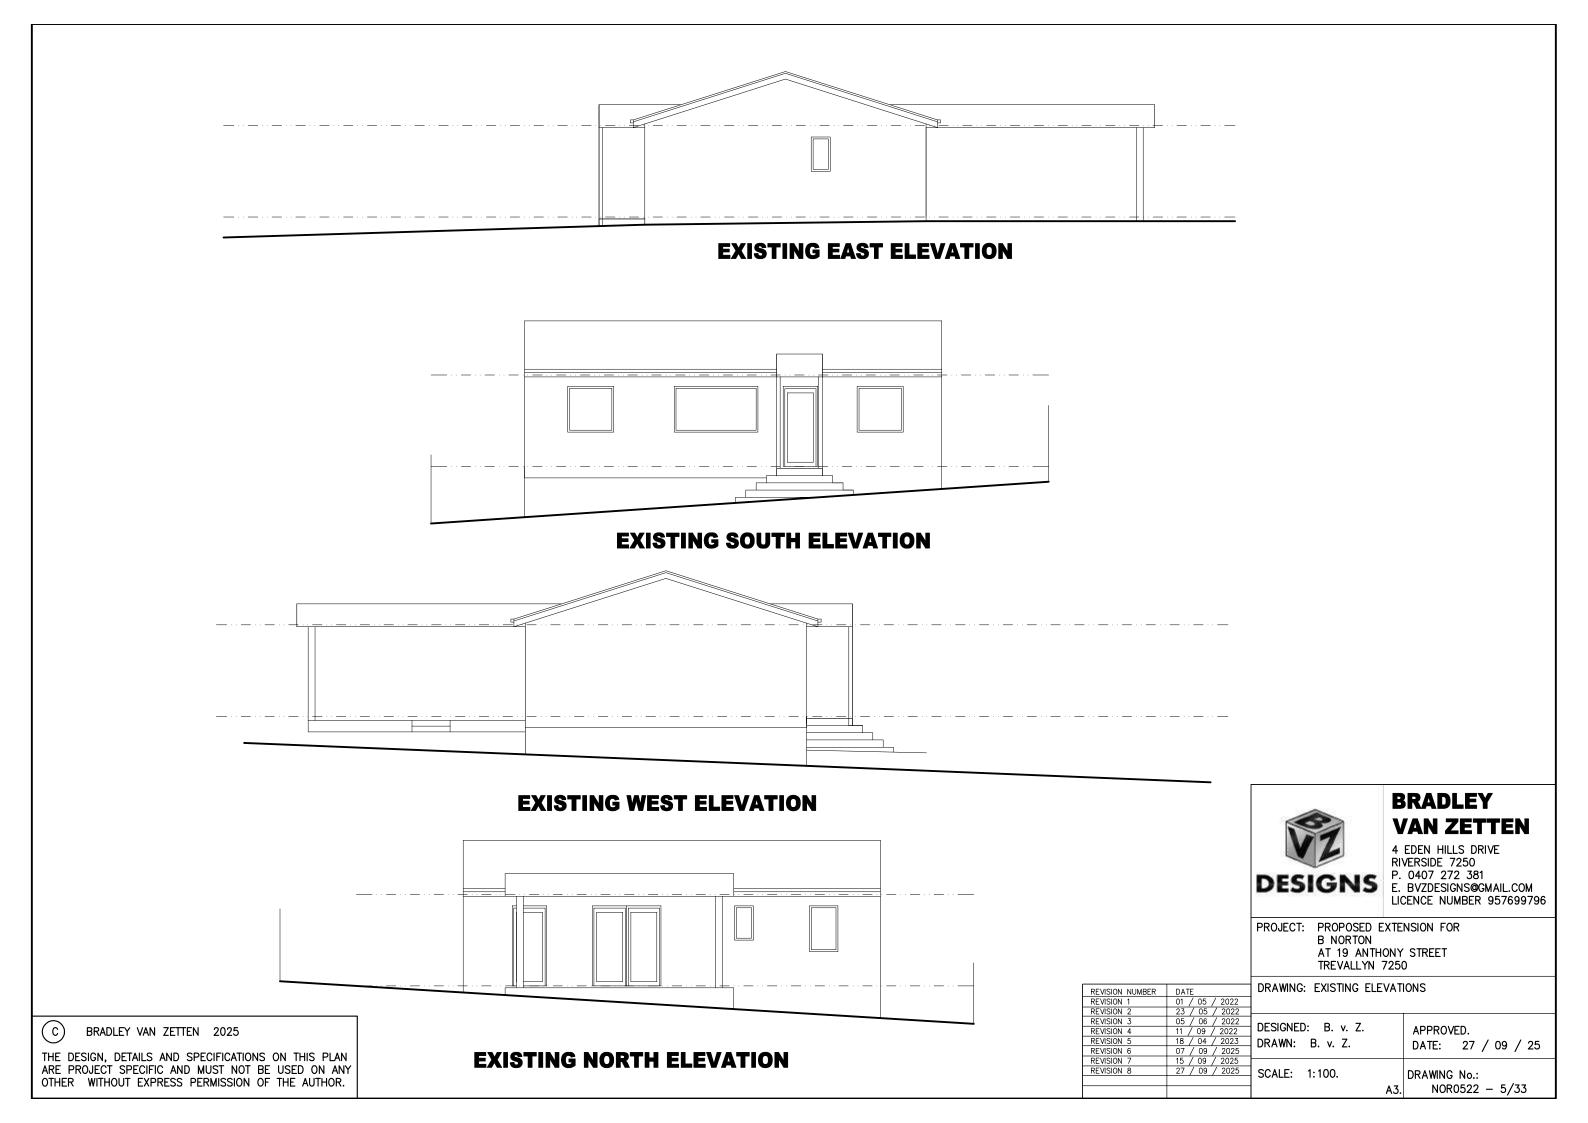

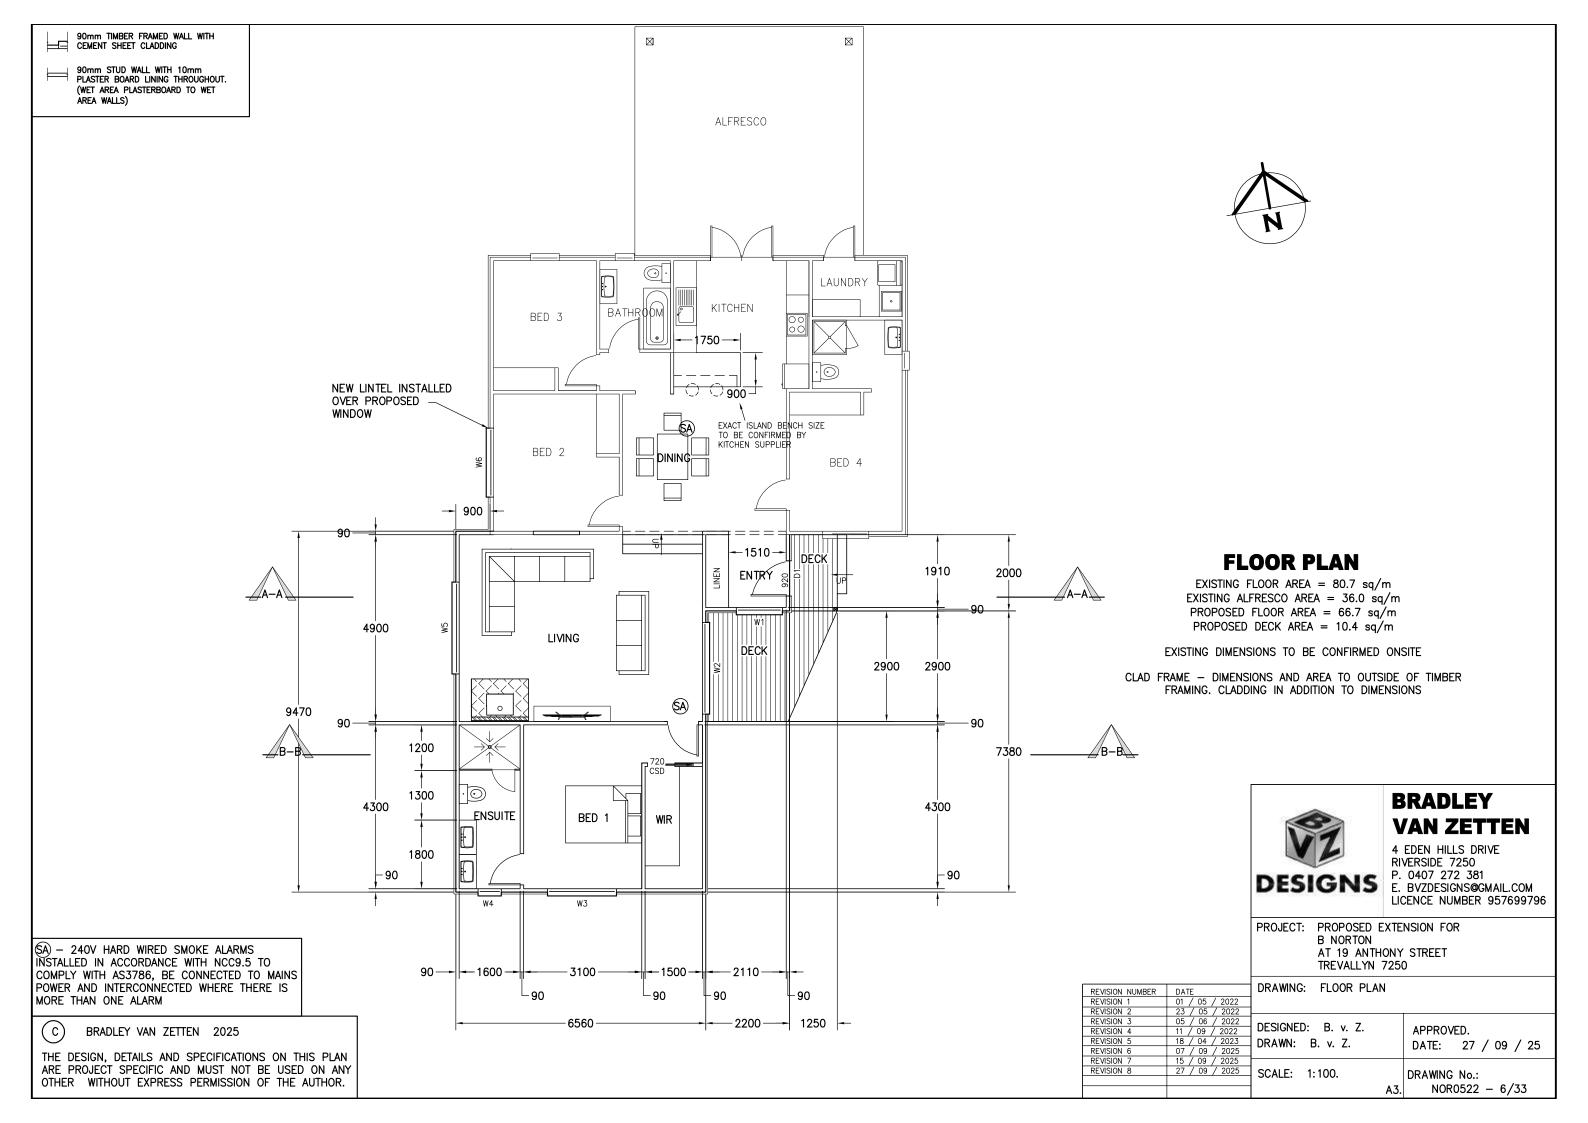

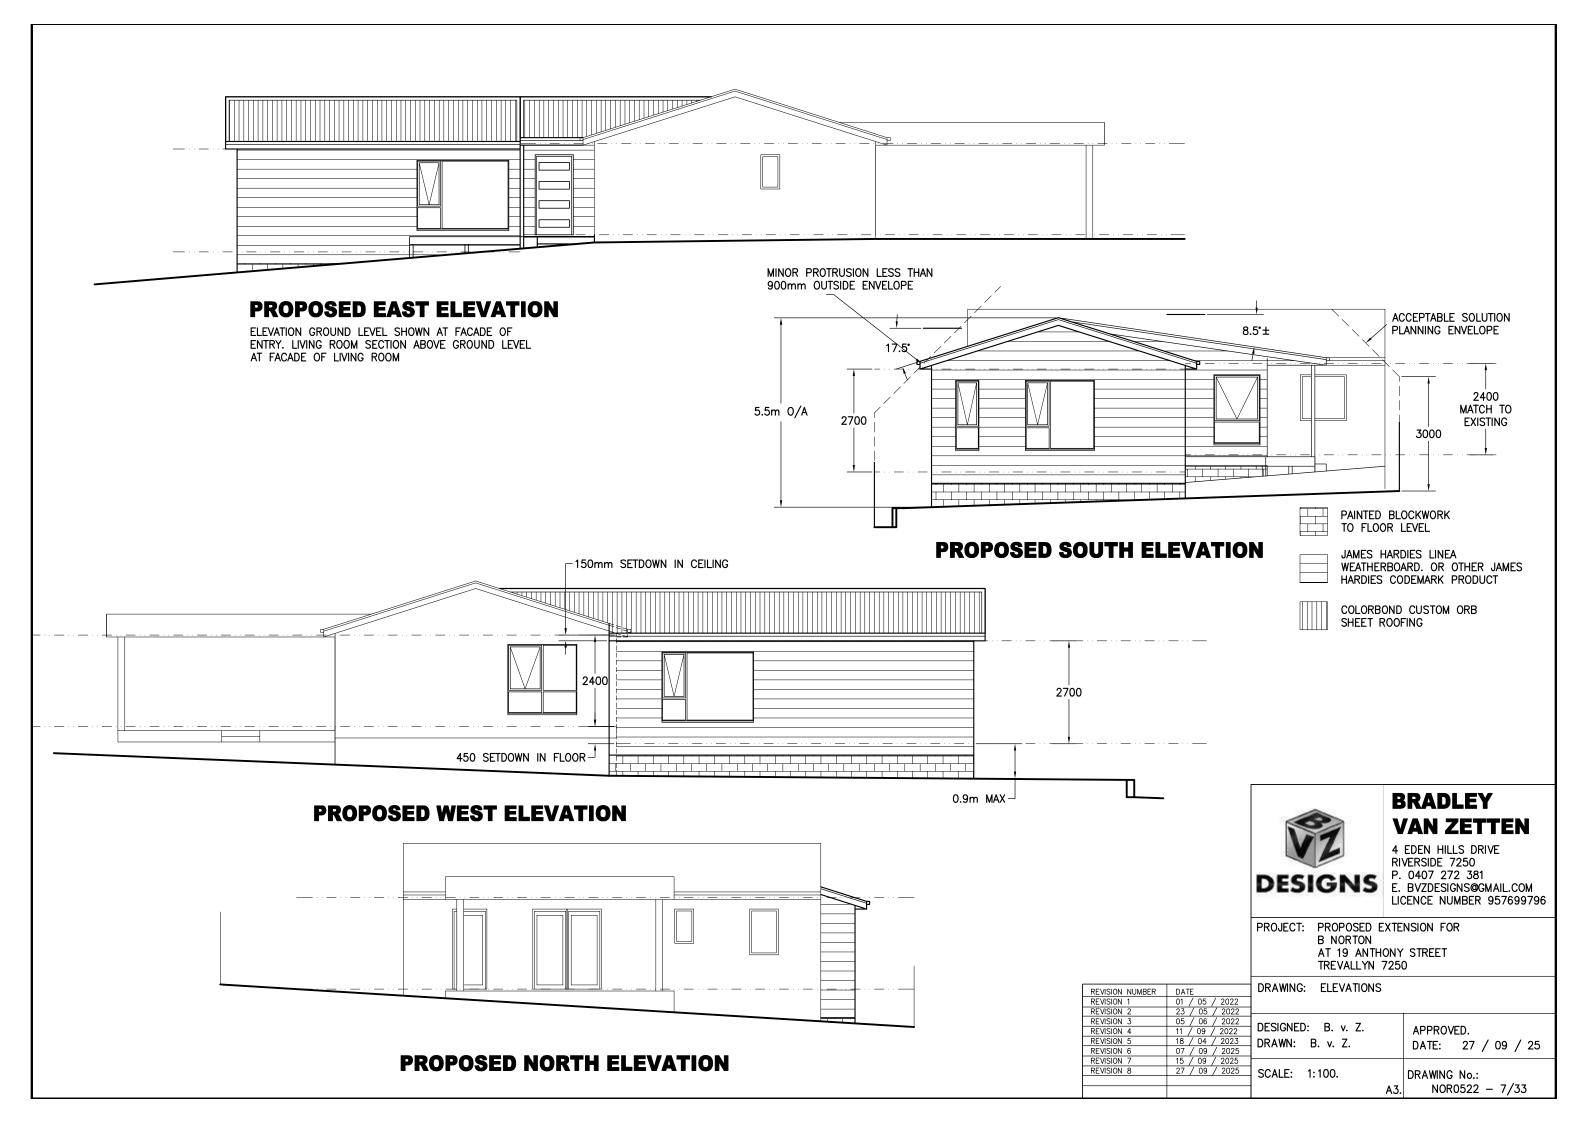

ROOF CLADDING TO COMPLY WITH NCC PART 7.1-7.5

GUTTERS AND DOWNPIPES INSTALLED AS PER NCC PART 7.4
GUTTER MUST BE INSTALLED WITH A FALL NOT LESS THAN

1.500 FOR FAVES CUTTERS LINIESS FLYED TO METAL

• 1:500 FOR EAVES GUTTERS, UNLESS FIXED TO METAL FASCIAS

WHERE HIGH FRONTED GUTTERS ARE INSTALLED, PROVISION MUST BE MADE TO AVOID ANY OVERFLOW BACK INTO THE ROOF OR BUILDING STRUCTURE BY INCORPORATING OVERFLOW MEASURERS OR THE LIKE

DOWNPIPES MUST--

(A)NOT SERVE MORE THAN 12 M OF GUTTER LENGTH FOR EACH DOWNPIPE; AND

(B)BE LOCATED AS CLOSE AS POSSIBLE TO VALLEY GUTTERS; AND

(C)BE SELECTED IN ACCORDANCE WITH THE APPROPRIATE EAVES GUTTER SECTION AS SHOWN IN TABLE 7.4.3A, TABLE 7.4.3B AND TABLE 7.4.3C.

FOR ROOF CATCHMENTS UP TO 50SQ/M PER DOWNPIPE MEDIUM RECTANGULAR GUTTERS OR 115MM 'D' GUTTERS MAY BE USED WITH 90ØMM DOWNPIPES

EAVE AND GUTTER OVERFLOW MEASURE TO BE INSTALLED FOR 1% ANNUAL EXCEEDANCE PROBABILITY

BOX GUTTERS AS PER AS3500.3

7.4.6 ACCEPTABLE CONTINUOUS OVERFLOW MEASURE

(1) FOR A FRONT FACE SLOTTED GUTTER WITH—

A MINIMUM SLOT OPENING AREA OF 1200 MM2 (A) PER METRE OF GUTTER; AND

(a) THE LOWER EDGE OF THE SLOTS INSTALLED A MINIMUM OF 25 MM BELOW THE TOP OF THE FASCIA.

THE ACCEPTABLE OVERFLOW CAPACITY MUST BE 0.5 L/S/M, CONSTRUCTED IN ACCORDANCE WITH FIGURE 7.4.6A.

(2) FOR A CONTROLLED BACK GAP WITH-

- (a) A PERMANENT MINIMUM 10 MM SPACER INSTALLED BETWEEN THE GUTTER BACK AND THE FASCIA; AND
- (b) ONE SPACER PER BRACKET, WITH THE SPACER NOT MORE THAN 50 MM WIDE; AND
- (c) THE BACK OF THE GUTTER INSTALLED A MINIMUM OF 10 MM BELOW THE TOP OF THE FASCIA, $\,$

THE ACCEPTABLE OVERFLOW CAPACITY MUST BE 1.5 L/S/M, CONSTRUCTED IN ACCORDANCE WITH FIGURE 7.4.6B.

(3) FOR THE CONTROLLED BACK GAP OPTION, THE SPACER CAN BE A PROPRIETARY CLIP OR BRACKET THAT PROVIDES THE REQUIRED OFFSET OF

THE GUTTER FROM THE FASCIA.



BRADLEY VAN ZETTEN

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PROJECT: PROPOSED EXTENSION FOR B NORTON AT 19 ANTHONY STREET

AT 19 ANTHONY STREET TREVALLYN 7250

REVISION NUMBER	DATE	DRAWING	: ROOF PLAN		
REVISION 1	01 / 05 / 2022				
REVISION 2	23 / 05 / 2022				
REVISION 3	05 / 06 / 2022	DECIONE). D 7		
REVISION 4	11 / 09 / 2022	DESIGNER): B. v. Z.		APPROVED.
REVISION 5	18 / 04 / 2023	DRAWN.	B. v. Z.		DATE: 27 / 09 / 25
REVISION 6	07 / 09 / 2025] =	D. 1. 2.		DAIL. 27 / 09 / 23
REVISION 7	15 / 09 / 2025			_	
REVISION 8	27 / 09 / 2025	SCALE:	1.100	r	DRAWING No.:
] 557,666.			
		1	<i>A</i>	43.	NOR0522 - 8/33