Eden Street

Riverside Tasmania 7250 Telephone: (03) 6323 9300 Facsimile: (03) 6323 9349



PLANNING APPLICATION FORM

Section 57 & 58

Applicant Name:	Wilsor	n Homes Tasmania P	ty Ltd		
Applicant Contact Name					
Postal Address:					
Contact Phone:	Home		Work	Mobile	
Email Address:					

Planning Application Lodgement Checklist

<u>The following documents have been submitted to support the consideration of this applicatio</u>	<u>on:</u>
--	------------

- 1. A current copy of the property title text, folio plan and schedule of easements
 2. A completed application form including a detailed description of the proposal
 3. A complete plan set:
 a) Floor plans
 b) Elevations (from all orientations/sides and showing natural ground level and finished surface level)
 c) Site Plan showing:
 - Orientation
 - All title boundaries
 - Location of buildings and structure (both existing and proposed)
 - Setbacks from all boundaries
 - Native vegetation to be removed
 - Onsite services, connections and drainage details (including sewer, water and stormwater)
 - Cut and/or Fill
 - Car parking and access details (including construction material of all trafficable areas)
 - Fence details
 - Contours
- 4. Other:

WEST TAMAR COUNCIL



Application Number: «Application_Number»

		A	PPLICANT DETAILS					
Applicant Name:	Wilson Ho	mes Ta	smania Pty Ltd					
Note: Full name	(s) of person(s)	or company	making the application and	l postal addr	ess for correspo	ondence.		
	LAND DETAILS							
Owner/Authority Name: (as per certificate of title)								
Location / Address:	C/- Wilson I	Homes Tas	mania Pty Ltd					
Title Reference:	Title Reference:							
Zone(s):								
Existing Development/Use:	Existing Development/Use: 0							
Existing Developed Area:	Existing Developed Area: 239.64 m ²							
E.g. Use and/or developmen	Are any of the components in this Application seeking retrospective approval? E.g. Use and/or development that has commenced without a Planning Permit. NO ☑							
(If yes please specify the rele	evant compor	ients):						
	DI	EVELOPN	IENT APPLICATION D	ETAILS				
Proposed Use:	Residential Description		isitor Accommodation: 🗆] C	ommercial: 🗆	Other: □		
				1				
Development Type:	Building work: ☑ Demolition: □ Subdivision: □ Other: □ Development Type: Building work: ☑ Demolition: □ Subdivision: □ Other: □							
New or Additional Area:								
Estimated construction cost proposed development:	of the	\$603,790)					
		Wall Ty	pe: Brick Veneer		Colour: TB	SC .		
Building Materials:		Roof Type: Sheet Metal			Colour: TBC			

WEST TAMAR COUNCIL



Application Number: «Application_Number»

		VISITOR ACCOIN	MODATION		UN/A
Gross Floor Are	ea to be used per		lumber of Bedrooms to be ised:		
Number of Car	parking Spaces:		Maximum Number of Visitors at a time:		
		SUBDIVISI	ON		□N/A
		300011131		ing additional late	
		Bounda	Subdivision creati ry adjustment with no addit		
Number of	Lots (existing):		Number of Lots (proposed) :		
Description:					
If applying for	r a subdivision which c	reates a new road(s), please preferen	e supply three proposed name ace:	s for the road(s), in	order of
1.		,			
2.					
3.					
	COMMERCIAL. II	NDUSTRIAL OR OTHER	NON-RESIDENTIAL DEVEL	OPMENT/USE	□N/A
			T		
		Monday / Friday:		То	
Hours of Opera	ition:	Saturday:		То	
		Sunday:		То	
Existing Car Pa	rking:				
Proposed Car P	Parking:				
Number of Em	nlovees:				
(Existing)	Number of Employees: (Existing)				
Number of Employeed)	ployees:				
(гторозеи)					
Type of Machir	nery installed:				
Details of trade method of disp					
method of disp	oosal.				

WEST TAMAR COUNCIL



Application Number: «Application_Number»

APPLICANT DECLARATION

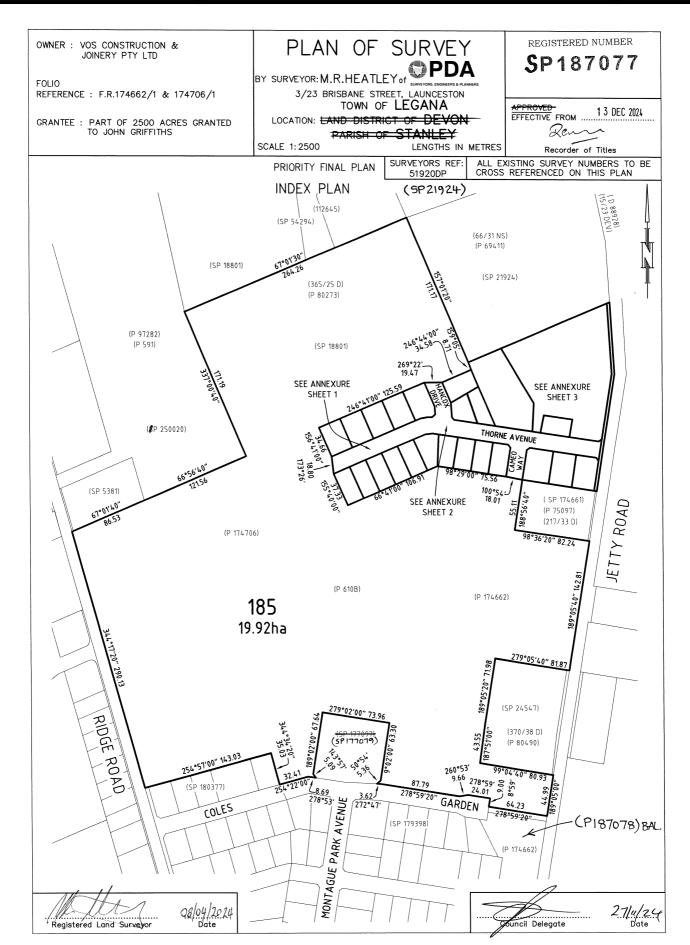
Owner:	As the owner of the land, I declare that the inf accurate representation of the proposal and I Officers to conduct inspections as required for	consent to this application being submitt	
	Owner_Name		
	Name (print)	Signed	Date
Applicant: (if not the owner)	As the applicant, I declare that I have notified the information contained in this application is		
	Lutzia Brown Applicant_Name	Litzia Brown	20/11/25
	Name (print)	Signed	Date
Please Note: If the Crown Consent	he application involves Crown Land you will need Minister, or a delegated officer of the Cro		orm signed by the
(if required)	Name (print)	Signed	Date
Chief			
Executive			
Officer			
(if required)	Name (print)	Signed	Date
If the subje	ect site is accessed via a right of way, the owner	of the ROW must also be notified of the a	application.
Right of \	Way Owner: Lutzia Brown	n	
	\mathcal{O}		
As the applicant,	I declare that I have notified the owner of the la this application that wil		ny intent to lodge
	Lutzia Brown	Lutzia Brown	20/11/25
	Name (print)	Lutzia Brown Signed	Date



RECORDER OF TITLES



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Search Date: 27 Jul 2025

Search Time: 01:44 PM

Volume Number: 187077

Revision Number: 01

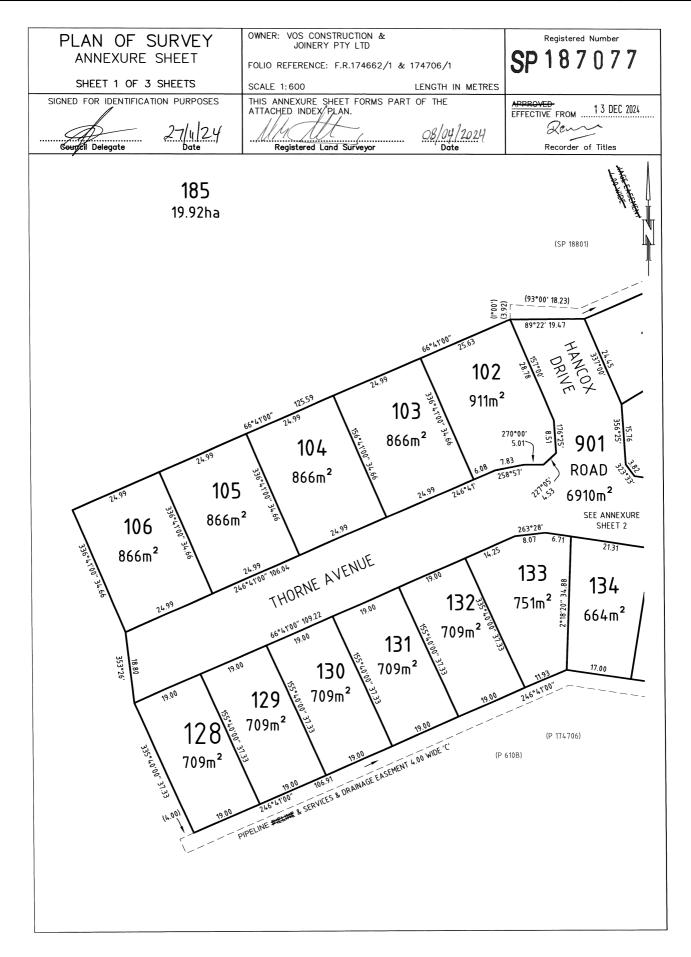
Page 1 of 4



RECORDER OF TITLES



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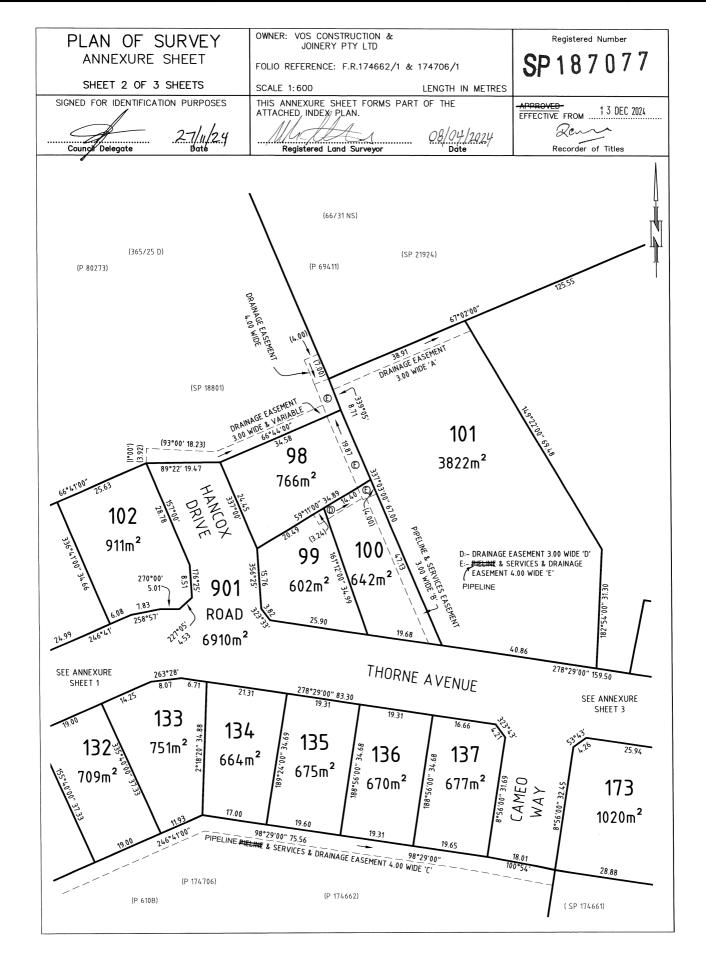




RECORDER OF TITLES



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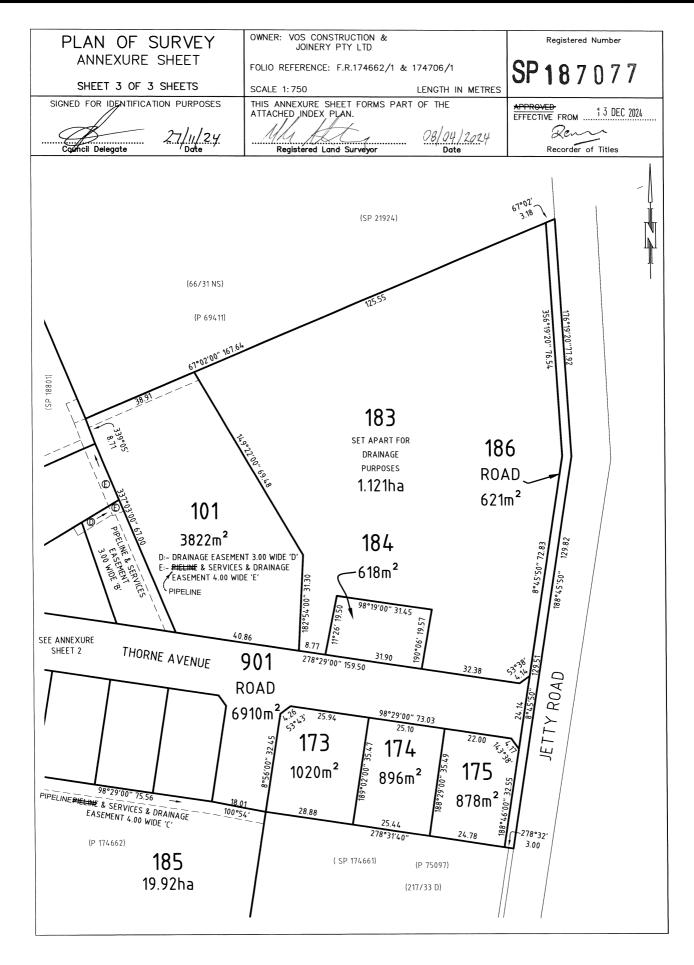
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RECORDER OF TITLES



Issued Pursuant to the Land Titles Act 1980





SCHEDULE OF EASEMENTS

RECORDER OF TITLES

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SCHEDULE OF EASEMENTS

NOTE:

THE SCHEDULE MUST BE SIGNED BY THE OWNERS & MORTGAGEES OF THE LAND AFFECTED.
SIGNATURES MUST BE ATTESTED.

Registered Number

SP 187077

PAGE 1 OF 3 PAGE/S

EASEMENTS AND PROFITS

Each lot on the plan is together with:-

- (1) such rights of drainage over the drainage easements shown on the plan (if any) as may be necessary to drain the stormwater and other surplus water from such lot; and
- (2) any easements or profits a prendre described hereunder.

Each lot on the plan is subject to:-

- (1) such rights of drainage over the drainage easements shown on the plan (if any) as passing through such lot as may be necessary to drain the stormwater and other surplus water from any other lot on the plan; and
- (2) any easements or profits a prendre described hereunder.

The direction of the flow of water through the drainage easements shown on the plan is indicated by arrows.

Lots 98, 100 and 185 on the Plan are subject to a Right of Drainage of the in favour of the West Tamar Council over the land marked "PIPELINE & SERVICES & DRAINAGE EASEMENT 4.00 WIDE 'E'" shown passing through those lots on the Plan.

Lots 98, 100 and 185 on the Plan ("the Lot") are subject to a Pipeline and Services Easement (as defined herein) in gross in favour of TasWater over the land marked "PIPELINE & SERVICES & DRAINAGE EASEMENT 4.00 WIDE 'E'" shown on the Plan ("the Easement Land").

Lots 99 and 100 on the Plan are subject to a Right of Drainage in favour of the West Tamar Council over the land marked "DRAINAGE EASEMENT 3.00 WIDE 'D' " shown passing through those lots on the Plan.

Lot 100 ("the Lot") on the Plan is subject to a Pipeline and Services Easement (as defined herein) in gross in favour of TasWater over the land marked "PIPELINE & SERVICES EASEMENT 3.00 WIDE 'B' " shown on the Plan ("the Easement Land").

Lot 101 on the Plan is subject to a Right of Drainage of the in favour of the West Tamar Council over the land marked "DRAINAGE EASEMENT 3.00 WIDE 'A' " shown passing through Lot 101 on the Plan.

Lot 185 on the Plan is subject to a Right of Drainage of the in favour of the West Tamar Council over the land marked "DRAINAGE EASEMENT 3.00 WIDE & VARIABLE" shown passing through Lot 185 on the Plan.

Lot 185 on the Plan is subject to a Right of Drainage of the in favour of the West Tamar Council over the land marked "PIPELINE & SERVICES & DRAINAGE EASEMENT 4.00 WIDE 'C'" shown passing through Lot 185 on the Plan.

Lot 185 on the Plan ("the Lot") is subject to a Pipeline and Services Easement (as defined herein) in gross in favour of TasWater over the land marked "PIPELINE & SERVICES & DRAINAGE EASEMENT 4.00 WIDE 'C' " shown on the Plan ("the Easement Land").

Lot 185 on the Plan is subject to a Right of Drainage ef the in favour of the West Tamar Council over the land marked "DRAINAGE EASEMENT 4.00 WIDE" shown passing through Lot 185 on the Plan.

(USE ANNEXURE PAGES FOR CONTINUATION)

SUBDIVIDER: Vos Construction & Joinery Pty Ltd

FOLIO REF: Volume 174662 Folio 1 and Volume 174706

Folio 1

SOLICITOR & REFERENCE: Penny Sproal - 246482

PLAN SEALED BY: West Tamar Council

PA 2021064

REF NO.

Council Delegate

NOTE: The Council Delegate must sign the Certificate for the purposes of infentification.

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SCHEDULE OF EASEMENTS

RECORDER OF TITLES

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ANNEXURE TO SCHEDULE OF EASEMENTS

PAGE 2 OF 3 PAGES

Registered Number

SP 187077

SUBDIVIDER: Vos Construction & Joinery Pty Ltd

FOLIO REFERENCE: Volume 174662 Folio 1 and Volume 174706 Folio 1

That part of each lot on the plan formerly comprised in Lot 1 on Plan 174662 is together with a right of carriage way over all the Roadways shown on Plan No. 610 other that the Roadway marked thereon as "Track from West Tamar Road to Homestead".

INTERPRETATION

In this Schedule of Easements:

"Pipeline Easement" means:

The full and free right and liberty to draw water through pipes now or to be installed as hereinafter appears within that portion of each Lot subject thereto marked pipeline easement on the plan and for that purpose to enter thereon and to lay in, under and upon the pipeline easement such pipe or pipes as shall from time to time be necessary for the purposes aforesaid and to draw water through such pipes and at all times to enter into and upon the pipeline easement for the purpose of maintaining any pumping system and inspecting, cleaning, maintaining, removing and renewing such pipes and to carry out all necessary work thereon causing as little damage as possible and making reasonable compensation for all damage done or caused thereby.

"Pipeline & Services Easement" means:

FIRSTLY, THE FULL AND FREE RIGHT AND LIBERTY for TasWater and its employees, contractors, agents and all other persons duly authorized by it, at all times to:

- (1) enter and remain upon the Easement Land with or without machinery, vehicles, plant and equipment
- investigate, take soil, rock and other samples, survey, open and break up and excavate the Easement Land for any purpose or activity that TasWater is authorized to do or undertake
- (3) install, retain, operate, modify, relocate, maintain, inspect, cleanse, repair, remove and replace the Infrastructure
- (4) run and pass sewerage, water and electricity through and along the Infrastructure
- (5) do all works reasonably required in connection with such activities or as may be authorized or required by any law:
 - (a) without doing unnecessary damage to the Easement Land, and
- (b) leaving the Easement Land in a clean and tidy condition.
- (6) if the Easement Land is not directly accessible from a highway, then for the purpose of undertaking any of the preceding activities TasWater may with or without employees, contractors, agents and any other persons authorized by it, and with or without machinery, vehicles, plant and equipment enter the Lot from the highway at any vehicle entry and cross the Lot to the Easement Land, and
- (7) use the Easement Land as a right of carriageway for the purpose of undertaking any of the preceding purposes on other land, TasWater reinstating any damage that it causes in doing so to any boundary fence of the Lot.

SECONDLY, the benefit of a covenant in gross for TasWater with the registered proprietor/s of the Easement Land and their successors and assigns not to erect any building, or place any structures, objects, vegetation, or remove any thing that supports, protects or covers any Infrastructure on or in the Easement Land, without the prior written consent of TasWater to the intent that the burden of the covenant may run with and bind the servient land and every part thereof and that the benefit thereof may be annexed to the easement herein described.

NOTE: Every annexed page must be signed by the parties to the dealing or where the party is a corporate body be signed by the persons who have attested the affixing of the seal of that body to the dealing.

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SCHEDULE OF EASEMENTS

RECORDER OF TITLES

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ANNEXURE TO SCHEDULE OF EASEMENTS

PAGE 3 OF 3 PAGES

Registered Number

SP 187077

SUBDIVIDER: Vos Construction & Joinery Pty Ltd

FOLIO REFERENCE: Volume 174662 Folio 1 and Volume 174706 Folio 1

Interpretation:

"Infrastructure" means infrastructure owned on for which TasWater is responsible and includes but is not limited to:

- (a) Sewer pipes and water pipes and associated valves,
- (b) Telemetry and monitoring devices,
- (c) Inspection and access pits,
- (d) Electricity assets and other conducting media (excluding telemetry and monitoring devices),
- (e) Markers or signs indicating the location of the Easement Land or any other Infrastructure or any warnings or restrictions with respect to the Easement Land or any other Infrastructure,
- (f) Anything reasonably require to support, protect or cover any other Infrastructure,
- (g) Any other infrastructure whether of a similar nature or not to the preceding which is reasonably required for the piping of sewerage or water, or the running of electricity, through the Easement Land or monitoring or managing that activity, and
- (h) Where the context permits, any part of the Infrastructure.

FENCING COVENANT

The Owner of each lot on the Plan covenants with the Vendor (Vos Construction & Joinery Pty Ltd) that the Vendor shall not be required to fence.

EXECUTED by VOS CONSTRUCTION & JOINERY PTY LTD (ACN 009 558 258) being the registered proprietor of the lands comprised in Folio of the Register Volume 174706 Folio 1 and Folio of the Register Volume 174662 Folio 1 in accordance with Section 127 of the Corporations Act 2001:

Darren Roelf Vos - Director

Adrian Donald Bott - Secretary

<u>LEGANA ORCHARDS PTY LTD</u> (ACN 009 520 852) as mortgagee under Mortgage No. E308992 hereby consents to this Schedule of Easements:

Raymond Howard Montague - Director

Darren Paul Gardner Barber - Director

NOTE: Every annexed page must be signed by the parties to the dealing or where the party is a corporate body be signed by the persons who have attested the affixing of the seal of that body to the dealing.

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[&]quot;TasWater" means Tasmanian Water & Sewerage Corporation Pty Ltd (ACN 162 220 653), its successors and assigns.

SHEET INDEX 1 COVER SHEET 2 SITE PLAN 3 SOIL & WATER MANAGEMENT PLAN 4 GROUND FLOOR PLAN 5 | ELEVATIONS / SECTION 6 ELEVATIONS 7 WINDOW & DOOR SCHEDULES 8 CALCULATIONS 9 DETAILS (FACE BRICKWORK) 10 ROOF DRAINAGE PLAN 11 FLOOR COVERINGS 12 KITCHEN DETAILS 13 BUTLER'S PANTRY DETAILS 14 BATHROOM DETAILS 15 ENSUITE DETAILS 16 POWDER ROOM DETAILS 17 LAUNDRY DETAILS 18 3D VIEWS 19 GENERAL NOTES 20 WET AREA & ENERGY EFFICIENCY NOTES 21 BUILDING ACT BUSHFIRE HAZARD AREAS

TOTAL FLOOR AREAS

23 BAL 12.5 - BAL 40 ROOF DETAILS

22 BAL 12.5 NOTES

M	AIN DWELLING, GROUND FLOOR	
	ALFRESCO	10.50
	COURTYARD	6.90
	GARAGE	39.43
	LIVING	179.58
	PORCH	3.23
		239.64 m ²

HIGHLY REACTIVE / PROBLEMATIC SOIL TYPE. **REFER TO HYDRAULICS PLANS** AND DETAILS PREPARED BY **GANDY AND ROBERTS**

AS & NCC COMPLIANCE

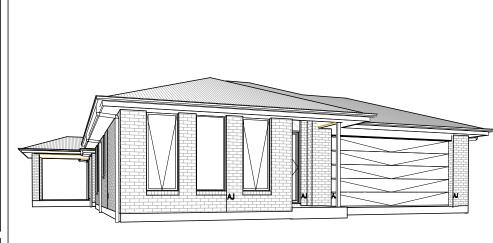
ALL CONSTRUCTION TO BE IN ACCORDANCE WITH NCC 2022 AND APPLICABLE AUSTRALIAN STANDARDS AT TIME OF APPROVAL

- SLAB IN ACCORDANCE WITH AS 2870. REFER TO ENGINEERS DETAILS FOR ALL SLAB DETAILS.
- BRICK CONTROL JOINTS PROVIDED IN ACCORDANCE WITH NCC 2022. ALL STEEL FRAMING TO BE DESIGNED TO AS 4100-2020 OR AS/NZS
- INSULATION TO BE INSTALLED IN ACCORDANCE WITH NCC 2022 AND ALL APPLICABLE AUSTRALIAN STANDARDS.
- TERMITE PROTECTION IN ACCORDANCE WITH AS 3660 AND NCC 2022. GLAZING IN ACCORDANCE WITH AS 1288 AND NCC 2022.
- SMOKE ALARMS IN ACCORDANCE WITH AS 3786 AND NCC 2022. INTERNAL WATERPROOFING IN ACCORDANCE WITH NCC 2022 HOUSING PROVISIONS PART 10.2.
- EXTERNAL WATERPROOFING IN ACCORDANCE WITH AS 3740 AND AS
- WET AREA FLOORS TO FALL TO FLOOR WASTES AT MIN. 1:80 AND MAX. 1:50 GRADE (IF APPLICABLE). CONDENSATION MANAGEMENT IN ACCORDANCE WITH NCC 2019
- BUILDING SEALING IN ACCORDANCE WITH NCC 2022. SERVICES IN ACCORDANCE WITH NCC 2022.
- EARTHWORKS IN ACCORDANCE WITH AS 3798-2007. EXTERNAL WALL WRAP (SARKING) IN ACCORDANCE WITH NCC 2022 (IF
- EXHAUST FANS DUCTED TO OUTSIDE AIR (IF APPLICABLE).

SITE SPECIFIC CONT	ROLS
CONTROL	DETAILS
ACID SULPHATE SOIL	NO
BIODIVERSITY	NO
BUILDING ENVELOPE	NO
BUSHFIRE	BAL-12.5
CLIMATE ZONE (NCC)	ZONE 7 - COOL TEMPERATE
DESIGN WIND CLASSIFICATION	N3 (NOT EXPOSED)
ESTATE/DEVELOPER GUIDELINES	NO
FLOOD OVERLAY	NO
HERITAGE	NO
LANDSLIP HAZARD	NO
MINIMUM FLOOR LEVEL	NO
NATURAL ASSET CODE	NO
NOISE ATTENUATION	NO
SALINE SOIL	YES
SHIELDING FACTOR	PS - PARTIAL SHIELDING
SITE CLASSIFICATION	P
SPECIFIC AREA PLAN OVERLAY	NO
TERRAIN CATEGORY	TC2
TOPOGRAPHIC CLASSIFICATION	T3
WATERWAY & COASTAL OVERLAY	NO
WIND REGION	A - NORMAL
WITHIN 1km CALM SALT WATER	NO
WITHIN 50km BREAKING SURF	NO
ZONING	GENERAL RESIDENTIAL

BUILDING CONTROLS & COMPLIANCE							
CONTROL	REQUIRED	PROPOSED					
SETBACKS							
FRONT	MIN. 4,500mm	2,605mm					
GARAGE TO BOUNDARY	MIN. 5,500mm	9,759mm					
SIDE A	MIN. 1,500mm	1,500mm					
SIDE B	MIN. 3,000mm	3,081mm					
REAR	MIN. 1,500mm	1,500mm					
BULK & SCALE							
SITE AREA	602m²						
SITE COVERAGE	MAX. 50%	38.66%					
BUILDING HEIGHT	MAX. 8,500mm	5,000mm					
LANDSCAPE							
NO APPLICABLE CONTROLS							
EARTHWORKS							
CUT DEPTH	MAX. 2,000mm	826mm					
FILL DEPTH	MAX. 1,000mm	666mm					
ACCESS & AMENITY							
PARKING SPACES	MIN. 2 SPACES	2 SPACES					
PRIVATE OPEN SPACE	MIN. 24m²	24m²					

3D PERSPECTIVE



NOTE TO OWNER

THESE PLANS MAY FEATURE WORKS THAT ARE EXCLUDED FROM THE SCOPE OF WORKS WITH THE BUILDER. BUT THEY HAVE BEEN INCLUDED IN THESE DRAWINGS TO ASSIST IN THE OVERALL PLANNING AND ASSESSMENT OF THE BUILDING PROJECT. EXAMPLES OF SOME REGULARLY EXCLUDED WORKS INCLUDE DRIVEWAYS, RETAINING WALLS, SOLAR PANEL SPACING AND SITE DRAINAGE, PLEASE REFER TO YOUR SCOPE OF WORKS AND COLOUR SELECTIONS DOCUMENTATION FOR DETAILS OF INCLUDED WORKS. SOME DETAILS ARE INDICATIVE ONLY FOR EXAMPLE FLOORING, TILING, BRICKWORK AND CLADDING (EXPANSION JOINTS, ORIENTATION AND LAYOUT) AND ARE SUBJECT TO CHANGE.

LOCATION MAP



COUNCIL

WEST TAMAR

BUILDING INFORMATION

GROUND FLOOR TOP OF WALL HEIGHT(S)	2745mm
NOTE: CEILING HEIGHT 45mm LOWER THA	N TOP OF WALL
ROOF PITCH (U.N.O.)	23.0°
ELECTRICITY SUPPLY	SINGLE PHASE
GAS SUPPLY	NONE
ROOF MATERIAL	SHEET METAL
ROOF COLOUR	N/A
WALL MATERIAL	BRICK VENEER
SLAB CLASSIFICATION	TBC

INSULATION

ROOF	MIN. 60mm FOIL FACED BLANKET UNDER ROOFING
CEILING	R4.1 BATTS (EXCL. GARAGE, ALFRESCO & PATIO)
EXT. WALLS	R2.0 BATTS (EXCL. GARAGE)
	WALL WRAP TO ENTIRE HOUSE
INT. WALLS	R2.0 BATTS ADJACENT TO GARAGE AND AS PER PLANN)
FLOOR	BIAX SLAB R0.60

NCC 2022 LIVABLE HOUSING COMPLIANCE

ACCESSIBLE SANITARY COMPARTMENT: PWD ACCESSIBLE SHOWER LOCATION: BATH

GENERAL NOTES:

THRESHOLD OF ACCESSIBLE SHOWER ENTRY TO BE MAX 5MM

1 EXTERIOR DOOR NOMINATED AS 870 OR GREATER TO ACHIEVE MIN 820MM CLEAR OPENING REFER TO APPLICABLE WET AREA PLANS AND INTERIOR ELEVATIONS OR LOCATIONS OF REQUIRED WALL REINFORCEMENT FOR FUTURE GRAB RAIL INSTALLATION.

BUSHFIRE REQUIREMENTS - BAL-12.5

THE BUILDER USES MATERIALS THAT COMPLY WITH AS 3959-2018 OR HAVE BEEN TESTED TO AS 1530.8.1 IN ACCORDANCE WITH AS 3959-2018

- PROVIDE FOIL FACED BLANKET INSULATION TO ALL COLORBOND SHEET ROOFING.
 - PROVIDE SARKING TO ALL TILED ROOFING INCLUDING PRESSTITE TO
 - VALLEYS PROVIDE BAL-12.5 RATED DEKTITE TO ALL AIR VENTS ON ROOF. PROVIDE BAL-12.5 RATED ALUMINIUM MESH TO ALL SOFFIT AND EAVE
 - PROVIDE BAL-12.5 RATED ALUMINIUM MESH TO ALL EXHAUST VENTS.

WALLS, POSTS AND BEAMS:

PROVIDE SPARK ARRESTORS TO ALL EXTERNAL BRICKWORK. EXTERNAL TIMBER POSTS WITHIN 400mm OF ADJACENT FINISHED FLOOR LEVEL TO BE BUSHFIRE-RESISTING TIMBER UNLESS MOUNTED ON STIRRUPS TO PROVIDE MIN. 75mm CLEARANCE ABOVE ADJACENT FINISHED FLOOR LEVEL

- VINDOWS AND DOORS: PROVIDE FLYSCREENS WITH CORROSION RESISTANT MESH TO ALL OPERABLE WINDOW SASHES (NO REQUIREMENT TO SCREEN BI-FOLD FRENCH / SLIDING / STACKER DOORS).
- PROVIDE BAL-12.5 RATED ALUMINIUM WINDOWS AND EXTERNAL GLASS SLIDING / STACKER DOORS.
- SPECIFIED ALUMINIUM FRENCH DOORS HAVE BEEN TESTED TO AS 1530.8.1 WITHOUT SCREENS.
- SPECIFIED ALUMINIUM WINDOWS HAVE BEEN TESTED TO AS 1530.8.1 WITHOUT SCREENS TO FIXED PANELS.
- PROVIDE ALUMINIUM DOOR JAMBS TO ALL EXTERNAL TIMBER DOORS.
 PROVIDE SAFETY SCREENS WITH CORROSION RESISTANT MESH TO
- EXTERNAL TIMBER HUNG DOORS (IF REQUIRED) PROVIDE SEAL TO ALL GARAGE PANELIFT / ROLLER DOORS.

PROVIDE COPPER WATER PIPES FROM WATER TANK TO HOUSE.

THE OWNERS ACKNOWLEDGE THAT THESE CONTRACT PLANS MAY NOT REFLECT ALL THE SELECTIONS THAT HAVE BEEN MADE OR CHANGES REQUESTED. THE OWNERS AGREE THAT FOLLOWING THE COLOUR SELECTIONS VARIATION OR UPDATING OF PLANS. THEY WILL BE PROVIDED WITH CONSTRUCTION PLANS FOR SIGNATURE PRIOR TO COMMENCEMENT OF CONSTRUCTION.

SIGNATURE:

SUBJECT TO NCC 2022 (1 MAY 2023)

DATE:

WATERPROOFING & PLUMBING

PLAN ACCEPTANCE BY OWNER SIGNATURE: DATE: SIGNATURE: DATE:

PLEASE NOTE THAT VARIATIONS WILL NOT BE ACCEPTED

AFTER THIS PLAN ACCEPTANCE HAS BEEN SIGNED.



PRELIMINARY PLAN SET

PRELIMINARY PLAN SET - INITIAL ISSUE

AMENDMENT

No.

		IN ANY WAY REPRODUCE, COPY, MODIFY, USE OR TAKE A	ADVAN	TAGE OF THE	DRAWING TO BUILD A HOUSE BASED ON THIS PLAN (WHETHER IN W
ECIFICATION:		REVISION	Г	DRAWN	CLIENT:
EXTGEN	1	DRAFT SALES PLAN - CP	KPH	23/10/2025	HYEONJIN PAK & HYUNMIN JANG
PYRIGHT:	2	PLANS UPDATE	MLG	24/10/2025	ADDRESS:
2025	3	PRELIM PLANS - INITIAL ISSUE	KPH	06/11/2025	16 THORNE AVENUE, LEGANA TAS 7277

KPH

DRAWN CHECK

LOT / SECTION / CT:

99 / - / 187077

2025.11.06

DATE

ALL

SHEET

© 2025 WILSON HOMES PTY LTD (ABN 96 126 636 897). THIS DRAWING IS AN ORIGINAL ARTISTIC WORK WITHIN THE MEANING OF THE COPYRIGHT ACT 1968 (CTH). WILSON HOMES PTY LTD IS THE OWNER OF COPYRIGHT IN THIS DRAWING. YOU HEREBY AGREE AND UNDERTAKE THAT YOU WILL NOT IN WHOLE OR IN PART) WITHOUT THE PRIOR WRITTEN CONSENT OF WILSON HOMES PTY LTD.

HOUSE CODE DO NOT SCALE DRAWINGS, USE FIGURED DIMENSIONS ONLY, CHEC **RIVERTON 23** H-WATRVT20SA AND VERIFY DIMENSIONS AND I EVELS PRIOR TO THE FACADE DESIGN: FACADE CODE: **CLASSIC** F-WATRVT20CLASA TO THE DRAFTING OFFICE. SHEET TITLE: SHEET No.: SCALES: 714497 COVER SHEET 1 / 23 1:100

REFER TO SHEET 1 (COVER SHEET) FOR ALL BUILDING INFORMATION REGARDING SUSTAINABILITY REQUIREMENTS SITE CLASSIFICATION GENERAL BUILDING INFORMATION APPROX. CUT/FILL 53.48m³ 120.33t 54 65m³ 122 96t 1.17m³ DIFFERENCE 2.63t **EVEN CUT & FILL** LOT SIZE: 801m² HOUSE (COVERED AREA 249.79m² SITE COVERAGE: 31.18% DRY STACK WALLS <1m HIGH: ISLAND BLOCK & PAVING FREESTONE ECO RETAINING WALL INSTALLATION TO MANUFACTURER'S SPECIFICATION AND

BAL-12.5 BUSHFIRE REQUIREMENTS SEE SHEET 1 (COVER SHEET) FOR DETAILS -100 UPVC PIPE CONNECTED TO COUNCIL STORMWATE NGL 10.314 MAX. 800mm DRY-STACK RETAINING WALL FILL 0.666 SEEDED FRONT LAWN (MIN. 300 OFFSET FROM BOUNDARY) (BY BUILDER) TRAFFICABLE 150mm GRATED DRAIN (BY OWNER) AND 450mm GRATED PIT (BY BUILDER) **BAL - 12.5 HAZARD MANAGEMENT** CONNECTED TO COUNCIL STORMWATER 341°12'00" NGL 10.400 **AREA (ENTIRE LOT)** SW INVERT **EASEMENT** FILL 0.580 34.990m SEWER INVERT APPROX. CONC. DRIVEWAY 510 20.07 m² SEEDED LAWN 1.5m SETBACK LINE 8.11 BY BUILDER DRAIN PIT COMBINED P.O.S AREA
DASHED IN RED: 257.35m² 51m² TOTAL FFL 10.700 (51m² TO BDY) 3,933 9,759 /(TO-8.4.3 REQUIREMENTS). METER/ WATER METER BOX AND SURROUNDS TO BE GARAGE HOUSED IN A PROPRIETARY OR IN-SITU BOX WITH NGL 10.420 TRAFFICABLE LID TO AS/NZS3996 BY BUILDER CUT 0.040 DEB 0.600 FFL 11.295 OT 99 70.00 -SEEDED FRONT LAWN (BY BUILDER) 602m² 239°11'06" 38,300 -85,900 -45,900 GROUND FLOOR FFL 11.365 302 PAD RL 10.980 1,500 3m FRONTTAGE SETBACK 12,605 205.60 m² SEEDED LAWN MAX. 1000mm CORE-FILLED BLOCK RETAINING WALL (MIN. 300 OFFSET FROM BOUNDARY) NBN & ELEC CONNECTION NGL 11.806 CUT 0.826 MAX. 800mm DRY-STACK RETAINING WALL (MIN. 300 OFFSET FROM BOUNDARY) 15.759_m CUT 0.739 1:2 CUT BATTER (1600mm MIN. OFFSET FROM DWELLING) 3.824m LANDSCAPING TO SCREEN SETBACK BREACH (BY OWNER) HANCOX DRIVE GARAGE FFL 11.295 **SUBJECT TO NCC 2022** NVFRT RI 10 550 (1 MAY 2023) WATERPROOFING & PLUMBING 9.100 2.703 1.526 6.3% 1.1% 2.0% PLAN ACCEPTANCE BY OWNER 5.4% SIGNATURE: DATE: AUSTRALIAN STANDARD DRIVEWAY PROFILE SIGNATURE: DATE:



	SPECIFICATION:	REVISION	DRAWN CLIENT:	NT: HOU	JSE DESIGN:	HOUSE CODE:	DO NOT SCALE DRAWINGS, USE
00	NEXTGEN	1 DRAFT SALES PLAN - CP KPH	23/10/2025 HYE	YEONJIN PAK & HYUNMIN JANG RIV	VERTON 23	H-WATRVT20SA	FIGURED DIMENSIONS ONLY. CHECK AND VERIFY DIMENSIONS AND
							LEVELS PRIOR TO THE
JII	COPYRIGHT:	2 PLANS UPDATE MLG	24/10/2025 ADDRESS	RESS: FAC.	CADE DESIGN:		COMMENCEMENT OF ANY WORK. ALL
\tilde{C}	© 2025	3 PRELIM PLANS - INITIAL ISSUE KPH	06/11/2025 16 TH	THORNE AVENUE, LEGANA TAS 7277 CL	ASSIC	F-WATRVT20CLASA	DISCREPANCIES TO BE REPORTED TO THE DRAFTING OFFICE.
9			LOT / SEC	/ SECTION / CT: COUNCIL: SHE	EET TITLE: SHEET No.:	SCALES:	711107
			99 / - /	/ - / 187077 WEST TAMAR SIT	TE PLAN 2 / 23	1:200	714497 stellar

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PLEASE NOTE THAT VARIATIONS WILL NOT BE ACCEPTED

AFTER THIS PLAN ACCEPTANCE HAS BEEN SIGNED

OWNER TO STABILISE THE SITE ON COMPLETION OF THE BUILD WITH TURF LAWNS, GRASS SEEDS, NATIVE GROUND COVERS AND/ OR MULCH SPREAD TO A DEPTH OF 75-100mm

THE FOLLOWING IS A STANDARD
APPROACH. SEDIMENT AND EROSION
CONTROL MEASURES WILL BE REVIEWED
PRIOR TO COMMENCING WORK AND
INSTALLED BASED ON THE OUTCOME OF
THAT REVIEW.

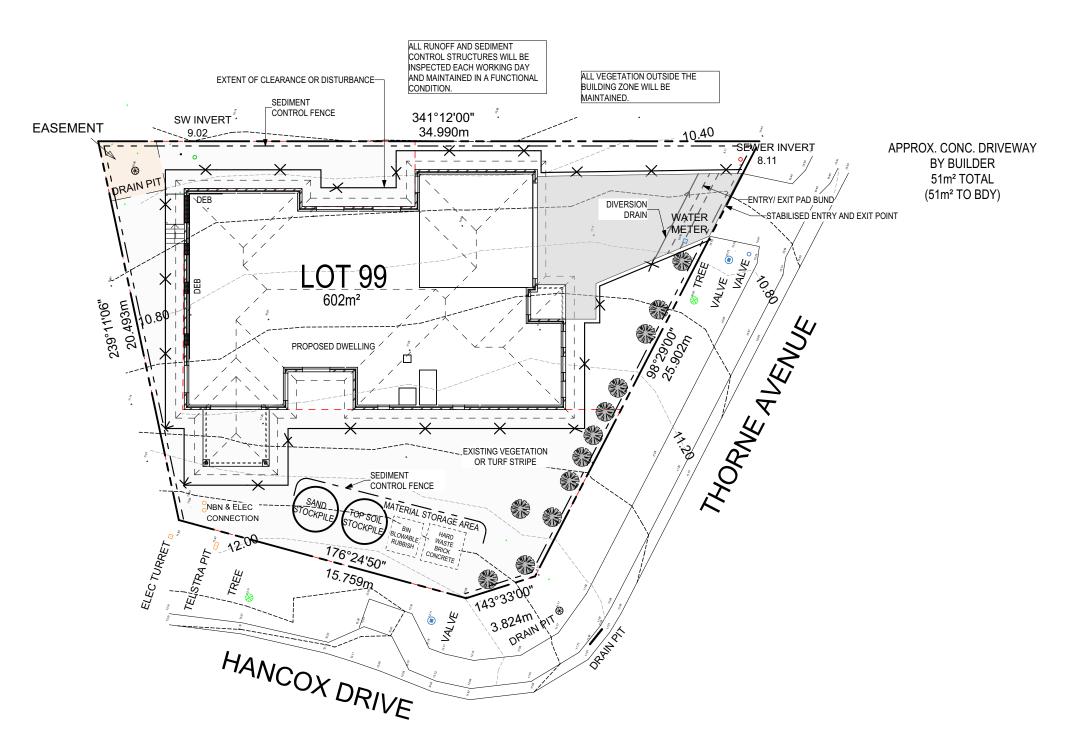
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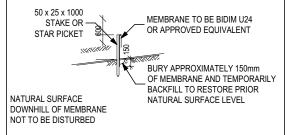
1. ALL EROSION AND SEDIMENT CONTROL STRUCTURES TO BE INSPECTED EACH WORKING DAY AND MAINTAINED IN GOOD WORKING ORDER.

- 2. ALL GROUND COVER VEGETATION
 OUTSIDE THE IMMEDIATE BUILDING AREA
 TO BE PRESERVED DURING THE BUILDING
- 3. ALL EROSION AND SEDIMENT CONROL MEASURES TO BE INSTALLED PRIOR TO COMMENCEMENT OF MAJOR EARTHWORKS.
- 4. STOCKPILES OF CLAYEY MATERIAL TO BE COVERED WITH AN IMPERVIOUS SHEET. 5. ROOF WATER DOWNPIPES TO BE CONNECTED TO THE PERMAMENT UNDERGROUND STORMWATER DRAINAGE SYSTEM AS SOON AS PRACTICAL AFTER

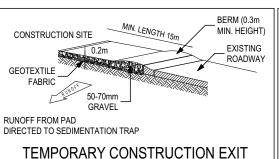
THE ROOF IS LAID.

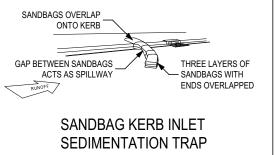
6. DIVERSION DRAINS ARE TO BE CONNECTED TO A LEAGAL DISCHARGE POINT (COUNCIL STORMWATER SYSTEM, WATERCOURSE OR ROAD DRAIN).
7. SEDIMENT RETENTION TRAPS INSTALLED AROUND THE INLETS TO THE STORMWATER SYSTEM TO PREVENT SEDIMENT & OTHER DEBRIS BLOCKING THE DRAINS.





SILT FENCING DETAIL





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SUBJECT TO NCC 2022 (1 MAY 2023)

WATERPROOFING & PLUMBING

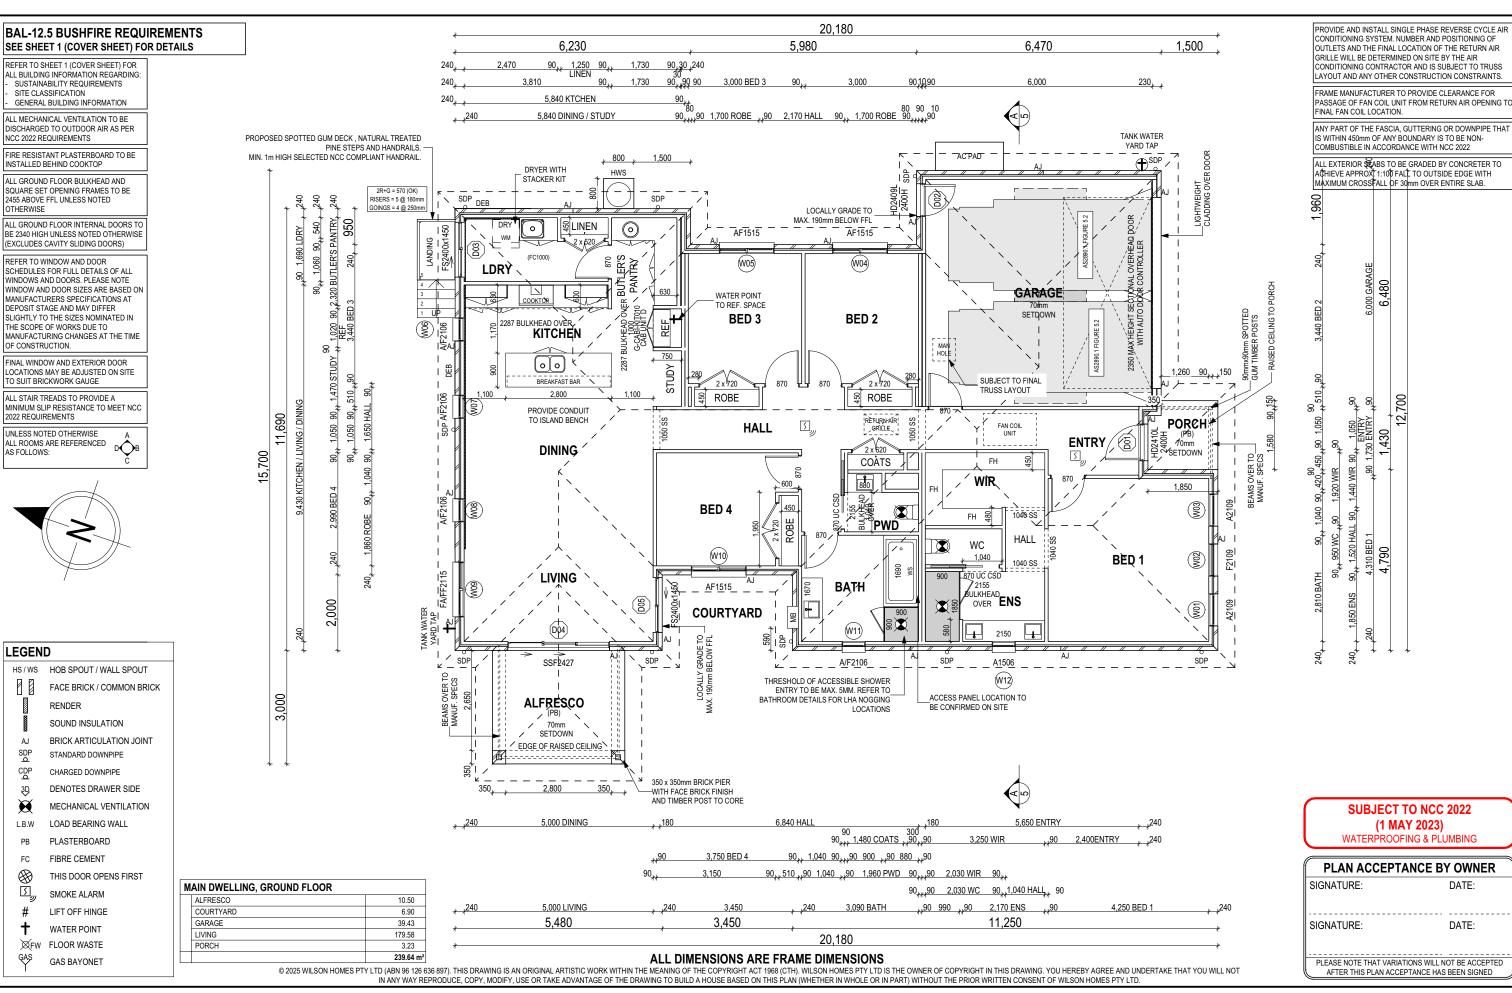
PLAN ACCEPTA	ANCE BY OWNER
SIGNATURE:	DATE:
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	FIONS WILL NOT BE ACCEPTED

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HOMES

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	SPECIFICATION:		REVISION		DRAWN	CLIENT:		HOUSE DESIGN:		HOUSE CODE:	DO NOT SCALE DRAWINGS, USE	
\cap	NEXTGEN	1	DRAFT SALES PLAN - CP	KPH	23/10/2025	HYEONJIN PAK & HYUI	NMIN JANG	RIVERTON 23		H-WATRVT20SA	FIGURED DIMENSIONS ONLY. CHECK AND VERIFY DIMENSIONS AND LEVELS PRIOR TO THE	.041
ш	COPYRIGHT:	2	PLANS UPDATE	MLG	24/10/2025	ADDRESS:		FACADE DESIGN:		FACADE CODE:	COMMENCEMENT OF ANY WORK. ALL	n: 24
	© 2025	3	PRELIM PLANS - INITIAL ISSUE	KPH	06/11/2025	16 THORNE AVENUE, LE	EGANA TAS 7277	CLASSIC		F-WATRVT20CLASA	DISCREPANCIES TO BE REPORTED TO THE DRAFTING OFFICE.	/ersio
						LOT / SECTION / CT:	COUNCIL:	SHEET TITLE:	SHEET No.:	SCALES:	744407	late \
						99 / - / 187077	WEST TAMAR	SOIL & WATER MANAGEMENT PLAN	3 / 23	1:200	714497	emp

Last Published: Thursday,

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PECIFICATION:	REVISION	DRAWN CLIENT:	HOUSE DESIGN:	HOUSE CODE:					
NEXTGEN	1 DRAFT SALES PLAN - CP	KPH 23/10/2025 HYEONJIN PAK & HYUNMIN JANG	RIVERTON 23	H-WATRVT20SA					
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2025	3 PRELIM PLANS - INITIAL ISSUE	KPH 06/11/2025 16 THORNE AVENUE, LEGANA TAS 7277	CLASSIC	F-WATRVT20CLASA					

WEST TAMAR

COUNCIL .

SHEET TITLE:

GROUND FLOOR PLAN

LOT / SECTION / CT:

99 / - / 187077

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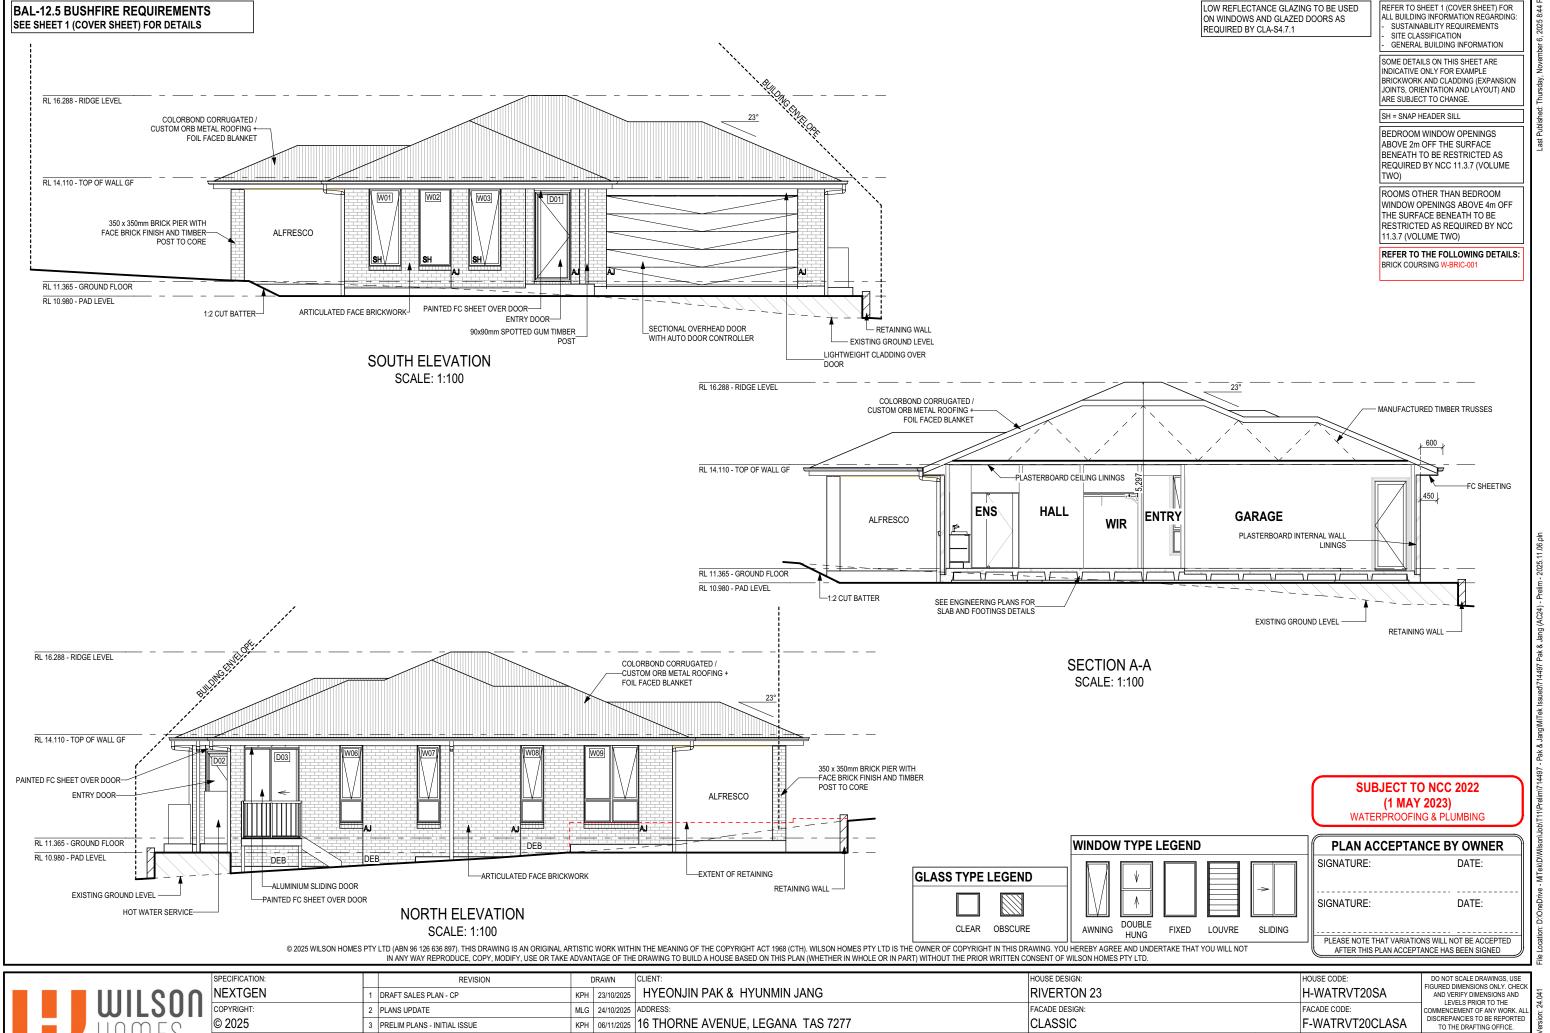
DISCREPANCIES TO BE REPORTED TO THE DRAFTING OFFICE.

714497

SHEET No.: SCALES

1:100

4 / 23



COUNCIL:

WEST TAMAR

SHEET TITLE:

ELEVATIONS / SECTION

SHEET No.: SCALES

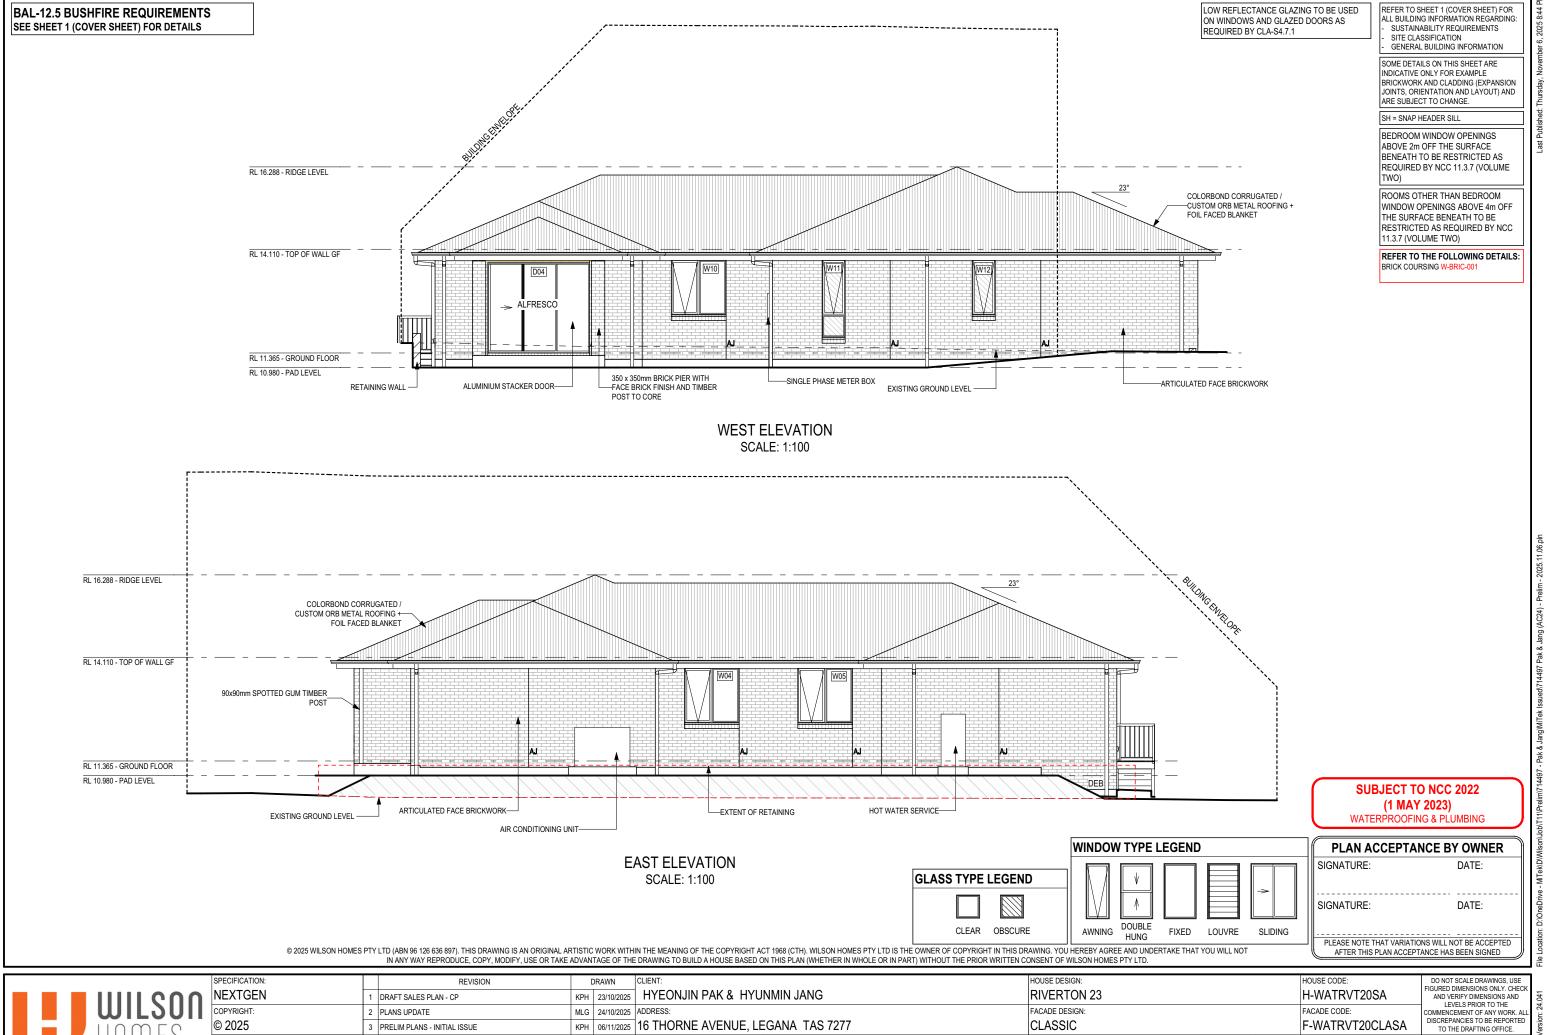
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5 / 23

LOT / SECTION / CT:

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714497



MLG 24/10/2025 ADDRESS: FACADE DESIGN: FACADE CODE: 2 PLANS UPDATE CLASSIC F-WATRVT20CLASA KPH 06/11/2025 16 THORNE AVENUE, LEGANA TAS 7277 3 PRELIM PLANS - INITIAL ISSUE LOT / SECTION / CT: SHEET TITLE: COUNCIL: SHEET No.: SCALES: WEST TAMAR **ELEVATIONS** 6 / 23 1:100 99 / - / 187077

714497

AREA FRAME

(m²) TYPE

BAL

1.75 ALUMINIUM BAL-12.5 SNAP HEADER

1.75 ALUMINIUM BAL-12.5 SNAP HEADER

1.75 ALUMINIUM BAL-12.5 SNAP HEADER

2.11 ALUMINIUM BAL-12.5 ANGLED

2.11 ALUMINIUM BAL-12.5 ANGLED

1.25 ALUMINIUM BAL-12.5 ANGLED

0.89 ALUMINIUM BAL-12.5 ANGLED

2.33 ALUMINIUM BAL-12.5 SNAP HEADER

2.09 ALUMINIUM BAL-12.5 SNAP HEADER

3.48 ALUMINIUM BAL-12.5 SNAP HEADER

6.45 ALUMINIUM BAL-12.5 SNAP HEADER

3.48 ALUMINIUM BAL-12.5 SNAP HEADER

1.25 ALUMINIUM BAL-12.5

1.25 ALUMINIUM BAL-12.5

2.98 ALUMINIUM BAL-12.5

2.11 ALUMINIUM BAL-12.5

1.25 ALUMINIUM BAL-12.5

RATING

SILL TYPE

ANGLED

ANGLED

ANGLED

ANGLED

ANGLED

rovide BAL- 12.5 rated aluminium windows and external glass sliding doors in lieu

Provide flyscreens with corrosion resistant mesh to all opening window sashes only.

GLAZING

16.18

14.71

30.89

1.63 CLEAR

1.41 CLEAR

GLAZING TYPE (SINGLE GLAZING U.N.O.)

1.40 CLEAR, DOUBLE GLAZED

1.54 CLEAR, DOUBLE GLAZED

1.40 CLEAR, DOUBLE GLAZED

1.70 CLEAR, DOUBLE GLAZED

1.70 CLEAR, DOUBLE GLAZED

0.93 CLEAR, DOUBLE GLAZED

0.93 CLEAR, DOUBLE GLAZED

0.93 CLEAR, DOUBLE GLAZED

2.39 CLEAR, DOUBLE GLAZED

1.70 CLEAR, DOUBLE GLAZED

0.93 OBSCURE, DOUBLE GLAZED, TOUGHENED

0.64 OBSCURE, DOUBLE GLAZED, TOUGHENED

2.98 CLEAR, DOUBLE GLAZED, TOUGHENED

5.70 CLEAR, DOUBLE GLAZED, TOUGHENED

2.98 CLEAR, DOUBLE GLAZED, TOUGHENED

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No BAL / BAL 12.5 Window Type **WERS Code** U Value SHGC Sliding Window DOW-022-003 2.9 0.64 DOW-005-001 Awning Window 3.9 0.58 DOW-038-001 3.03 Fixed External Window 0.71 Slidina Door DAR-034-001 3.97 0.63 DAR-034-001 3.97 Stacking Door 0.63 Hinged Door DOW-017-001 4.1 0.55 Bi-Fold Door DOW-020-001 4.1 0.54 BAL 19 WERS Code SHGC Window Type **U Value** TND-034-001 Sliding Window 3.1 0.61 Awning Window STG-001-066 3.91 0.54 Fixed External Window DOW-038-005 3.02 0.66 4.03 Sliding Door AUW-009-009 0.58 Stacking Door AUW-009-009 4.03 0.58 4.25 0.53 Hinged Door GRN-009-001 Bi-Fold Door DOW-020-001 4.1 0.54 **BAL 29** SHGC Window Type **WERS Code U Value** Sliding Window TND-034-001 3.1 0.61 Awning Window 3.91 0.54 STG-001-066 Fixed External Window DOW-038-005 3.02 0.66 Sliding Door AMJ-007-005 4.03 0.59 4.03 0.59 Stacking Door AMJ-007-005 4.29 0.53 Hinged Door GRN-009-001

ADDITIONAL INFORMATION²

MP 725

MP 725

BP 600

BP 600

BP 600

MP 725

BP 600

Window Manufacturer: Dowell Windows

BP 600, MP 725/725

Windows supplied MUST HAVE Uw better and or equal to stated figures and SHGC within +/- 5% of stated figures. Restricted windows to have their openability restricted as per N.C.C 11.3.6.

WINDOW & DOOR SCHEDULES

PICTURE, TV RECESS AND SS WINDOW OPENINGS QTY TYPE HEIGHT WIDTH AREA (m²)

FACADE DESIGN:

CLASSIC

SHEET TITLE:

870	N/A	20mm UNDERCUT
NC	TE: INTERNAL DO	ORS TO WET AREAS WITH MECHANICAL VENTILATION TO BE UNDERCUT 20mm

MLG 24/10/2025 ADDRESS:

BAL-12.5 BUSHFIRE REQUIREMENTS

ALL BUILDING INFORMATION REGARDING: SEE SHEET 1 (COVER SHEET) FOR DETAILS SUSTAINABILITY REQUIREMENTS GENERAL BUILDING INFORMATION

TYPE

SWINGING

SWINGING

SWINGING

SWINGING

CAVITY SLIDING

SQUARE SET OPENING

SQUARE SET OPENING

EXTERIOR WINDOW & DOOR SCHEDULE 1.2 ASSUME LOOKING FROM OUTSIDE

TYPE

AWNING

SWINGING

SWINGING

SLIDING

STACKER

SLIDING

FIXED

ROOM

BED 1

BFD 1

BED 1

BED 2

BED 3

KITCHEN

DINING

LIVING

LIVING

BED 4

BATH

ENS

ENTRY

LDRY

LIVING

LIVING

GARAGE

HEIGHT

2,057

2 057

2,057

1.457

1,457

2,057

2,057

2.057

2,057

1,457

2,057

1,457

2.400

2 400

2,400

2.400

2.400

WIDTH PERIMETER

5.814

5,814

5,814

5.814

5,814

5,334

5,334

5.334

7.014

5,814

5,334

4,134

6.740

6,540

7,700

10.176

7,700

38,856 mm

106,224 mm

20.47

17.83

38.30

67,368 mm

850

850

850

1.450

1,450

610

1.450

1,450

610

610

970

870

1 450

2.688

1.450

HEIGHT WIDTH GLAZING TYPE ADDITIONAL INFORMATION

1,040 N/A

1,050 N/A

1.040 N/A

1,240 N/A

1.440 N/A

870 N/A

2.455

2,455

2,340

2,340

2,340

2.340

2.040

2 PLANS UPDATE

3 PRELIM PLANS - INITIAL ISSUE

ID CODE1

W04 AF1515

W05 AF1515

W06 A/F2106

W07 A/F2106

W08 A/F2106

W10 AF1515

W11 A/F2106

W12 A1506

D01 HD2410L

D02 | HD2409L

D04 SSF2427

D03 FS2400x1450

D05 | FS2400x1450

W09 FA/FF2115

GROUND FLOOR W01 A2109

GROUND FLOOR W02 F2109

GROUND FLOOR | W03 | A2109

STOREY

GROUND FLOOR

DOOR

WINDOW

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	SPECIFICATION
IIIII COO	NEXTGE
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IIUWLC	© 2025
ПППЕ?	

INTERIOR WINDOW & DOOR SCHEDULE

QTY CODE

1040 SS

1050 SS

2 x 520

2 x 620

2 x 720

870 UC CSD

870

STOREY

GROUND FLOOR 3

GROUND FLOOR 2

GROUND FLOOR

GROUND FLOOR

GROUND FLOOR

GROUND FLOOR 7

GROUND FLOOR 2

REFER TO SHEET 1 (COVER SHEET) FOR

DOOR

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NEXTGEN	1 DRAFT SALES PLAN - CP	KPH 23/10/2025	HYEONJIN PAK & HYUNMIN JANG	RIVERTON 23				

KPH 06/11/2025 16 THORNE AVENUE, LEGANA TAS 7277

LOT / SECTION / CT:

99 / - / 187077

SCALES:	714497
F-WATRVT20CLASA	DISCREPANCIES TO BE REPORTED TO THE DRAFTING OFFICE.
FACADE CODE:	COMMENCEMENT OF ANY WORK. ALL
H-WATRVT20SA	FIGURED DIMENSIONS ONLY. CHECK AND VERIFY DIMENSIONS AND LEVELS PRIOR TO THE
HOUSE CODE:	DO NOT SCALE DRAWINGS, USE

SUBJECT TO NCC 2022

(1 MAY 2023)

WATERPROOFING & PLUMBING

PLAN ACCEPTANCE BY OWNER

PLEASE NOTE THAT VARIATIONS WILL NOT BE ACCEPTED

AFTER THIS PLAN ACCEPTANCE HAS BEEN SIGNED

DATE:

DATE:

SIGNATURE:

SIGNATURE:

SHEET No.:

7 / 23

TOTAL EIGHT AND VERTIENTION						
ROOM	AREA (m2)	WINDOW ID	LIGHT REQUIRED (m2)	LIGHT ACHIEVED (m2)	VENTILATION REQ`D (m2)	VENTILATION ACH`D (m2)
OPEN KITCHEN/ LIVING/ DINING/ STUDY	48.36 m²	D04, D05, W06, W07, W08, W09	4.84 m²	13.86 m²	2.42 m²	9.05 m²
BED 1	18.32 m²	W01, W02, W03	1.83 m²	4.34 m²	0.92 m²	3.26 m²
BED 2	11.22 m²	W04	1.12 m²	1.70 m²	0.56 m²	0.97 m²
BED 3	11.19 m²	W05	1.12 m²	1.70 m²	0.56 m²	0.97 m²
BED 4	10.99 m²	W10	1.10 m²	1.70 m²	0.55 m²	0.97 m²

PART 10.5.1 LIGHT: Minimum 10% of the floor area of a habitable room required (natural light)

PART 10.6 VENTILATION: Minimum 5% of the floor area of a habitable room required. (An exhaust fan may be used for sanitary compartment, laundry or bathroom provided contaminated air discharges directly to the outside of the building by way of ducts).

> **SUBJECT TO NCC 2022** (1 MAY 2023)

PLAN ACCEPTAN	CE BY OWNER
SIGNATURE:	DATE:
SIGNATURE:	DATF:
SIGNATURE.	DATE.
PLEASE NOTE THAT VARIATION	S WILL NOT BE ACCEPTED
AFTER THIS PLAN ACCEPTAL	NCE HAS BEEN SIGNED

SUSTAINABILITY REQUIREMENTS SITE CLASSIFICATION GENERAL BUILDING INFORMATION

REFER TO SHEET 1 (COVER SHEET) FOR ALL BUILDING INFORMATION REGARDING: SEE SHEET 1 (COVER SHEET) FOR DETAILS

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	SPECIFICATION:	REVISION	DRAWN	CLIENT:		HOUSE DESIGN:		HOUSE CODE:	DO NOT SCALE DRAWINGS, USE	1
1	NEXTGEN	1 DRAFT SALES PLAN - CP	KPH 23/10/2025	HYEONJIN PAK & HYU	JNMIN JANG	RIVERTON 23		H-WATRVT20SA	FIGURED DIMENSIONS ONLY. CHECK AND VERIFY DIMENSIONS AND LEVELS PRIOR TO THE	1.04
ı	COPYRIGHT:	2 PLANS UPDATE	MLG 24/10/2025	ADDRESS:		FACADE DESIGN:		FACADE CODE:	COMMENCEMENT OF ANY WORK. ALL	n: 24
	© 2025	3 PRELIM PLANS - INITIAL ISSUE	KPH 06/11/2025	16 THORNE AVENUE, L	EGANA TAS 7277	CLASSIC		F-WATRVT20CLASA	DISCREPANCIES TO BE REPORTED TO THE DRAFTING OFFICE.	/ersio
				LOT / SECTION / CT:	COUNCIL:	SHEET TITLE:	SHEET No.:	SCALES:	714497	ate
				99 / - / 187077	WEST TAMAR	CALCULATIONS	8 / 23		/ 1449/	Ē.

3343

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3514

3600

3686

3772

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3943

4029

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4200

4286

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STANDARD BRICK

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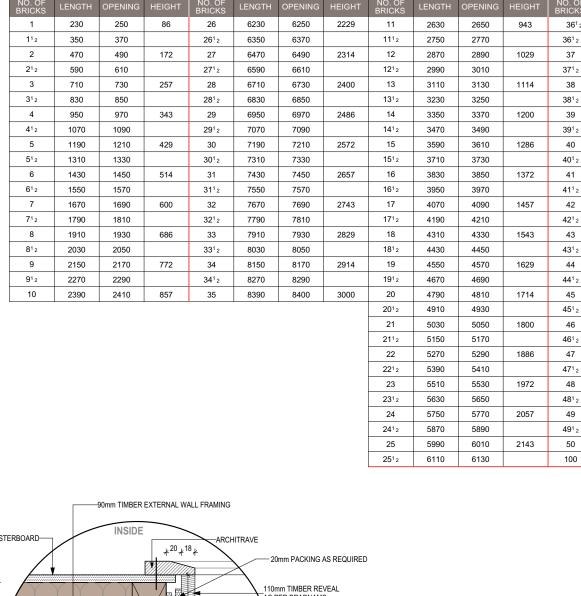
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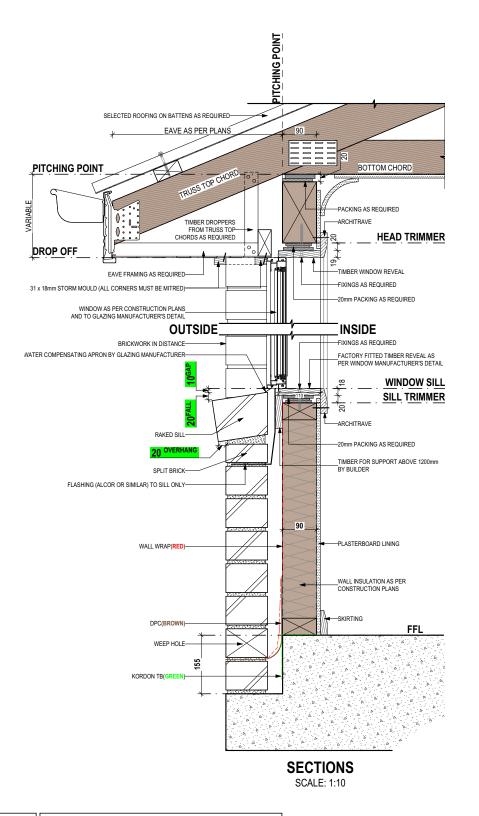
MANUFACTURING SIZE: 230x110x76mm

all dimensions in mm BRICKWORK DIMENSIONS Bricks per m² in wall = 48.5 approx.

FORMAT SIZE: 240x120x86mm



VERTICAL GAUGE: 7 Courses to 600mm



2 PLANS UPDATE

3 PRELIM PLANS - INITIAL ISSUE

PLASTERBOARD-AS PER BRADNAMS SCREW FIX REVEAL BY CARPENTER AT 600mm CENTRES SELECTED ALUMINIUM WINDOW FRAME FINE BEAD OF SEALANT BRICKWORK AS SELECTED **DETAILS** SCALE: 1:5

STANDARD BRICK

MANUFACTURING SIZE: 230x110x76mm

BRICKWORK DIMENSIONS Bricks per m² in wall = 48.5 approx.

FORMAT SIZE 240x120x86mm

SUBJECT TO NCC 2022 (1 MAY 2023)

WATERPROOFING & PLUMBING

PLAN ACCEPT	ANCE BY OWNER
SIGNATURE:	DATE:
SIGNATURE:	DATE:
PLEASE NOTE THAT VARIA	TIONS WILL NOT BE ACCEPTED

DO NOT SCALE DRAWINGS, USE

REFER TO SHEET 1 (COVER SHEET) FOR **BAL-12.5 BUSHFIRE REQUIREMENTS** ALL BUILDING INFORMATION REGARDING: SEE SHEET 1 (COVER SHEET) FOR DETAILS SUSTAINABILITY REQUIREMENTS

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GENERAL BUILDING INFORMATION

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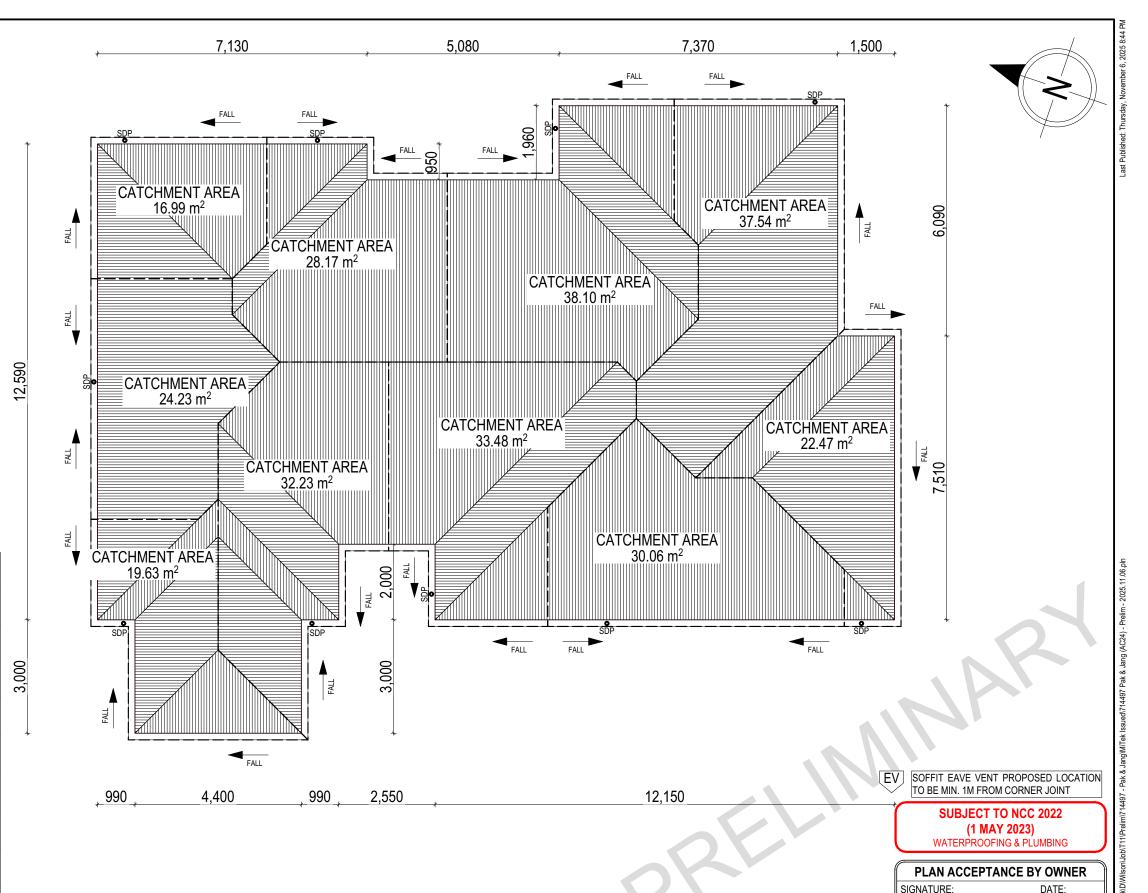
KPH 06/11/2025 16 THORNE AVENUE, LEGANA TAS 7277

LOT / SECTION / CT:

99 / - / 187077

MLG 24/10/2025 ADDRESS:

RIVERTON 23		H-WATRVT20SA	FIGURED DIMENSIONS ONLY. CHECK AND VERIFY DIMENSIONS AND LEVELS PRIOR TO THE	1.041
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SHEET TITLE:	SHEET No.:	SCALES:	744407	ate
DETAILS (FACE BRICKWORK)	9 / 23		714497	emplate



SIGNATURE:

DATE:

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AFTER THIS PLAN ACCEPTANCE HAS BEEN SIGNED

282.90 Area of roof catchment (including 115mm Slotted Quad Gutter) (m2) Ah x Catchment Area Multiplier for slope Ac 342.31 (Table 3.4.3.2 from AS/NZS 3500.3:2021) (1.21 for 23° pitch) (m²) 6300 Cross sectional area of 57 x 115 Slotted Quad Gutter (mm²) Design Rainfall Intensity (determined from Table E1 from DRI 91 AS/NZS 3500.3:2021) Catchment area per Downpipe (determined from Figure 3.5(A) 64 Acdp from AS/NZS 3500.3:2021) (m²) Required Ac / Acdp Downpipes

Downpipe roof calculations (as per AS/NZA3500.3:2021)

Flat Roof Area (excluding gutter and slope factor) (m²)

Roof Surface Area (includes slope factor, excludes gutter) (m²)

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HOMES	WILSON	COP

Downpipes Provided

WHERE DOWNPIPES ARE FURTHER THAN 1.2m AWAY FROM VALLEY REFER TO

POSITION AND QUALITY OF DOWNPIPES ARE NOT TO BE ALTERED WITHOUT CONSULTATION WITH DESIGNER.

AREA'S SHOWN ARE SURFACE AREAS/ CATCHMENT AREAS, NOT PLAN AREAS

291.68

Roofing Data

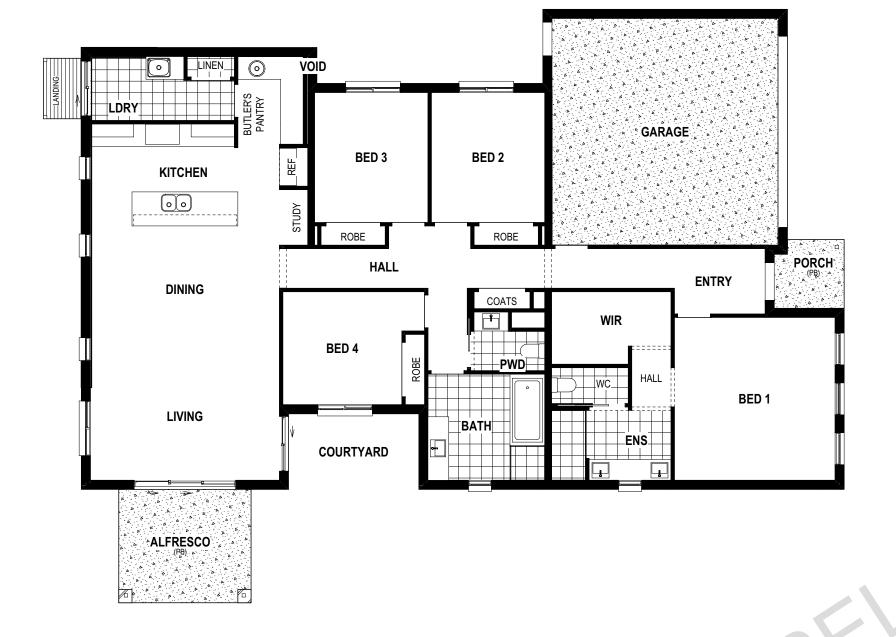
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LAMINATE

TILE (STANDARD WET AREAS)

TILE (UPGRADED AREAS)

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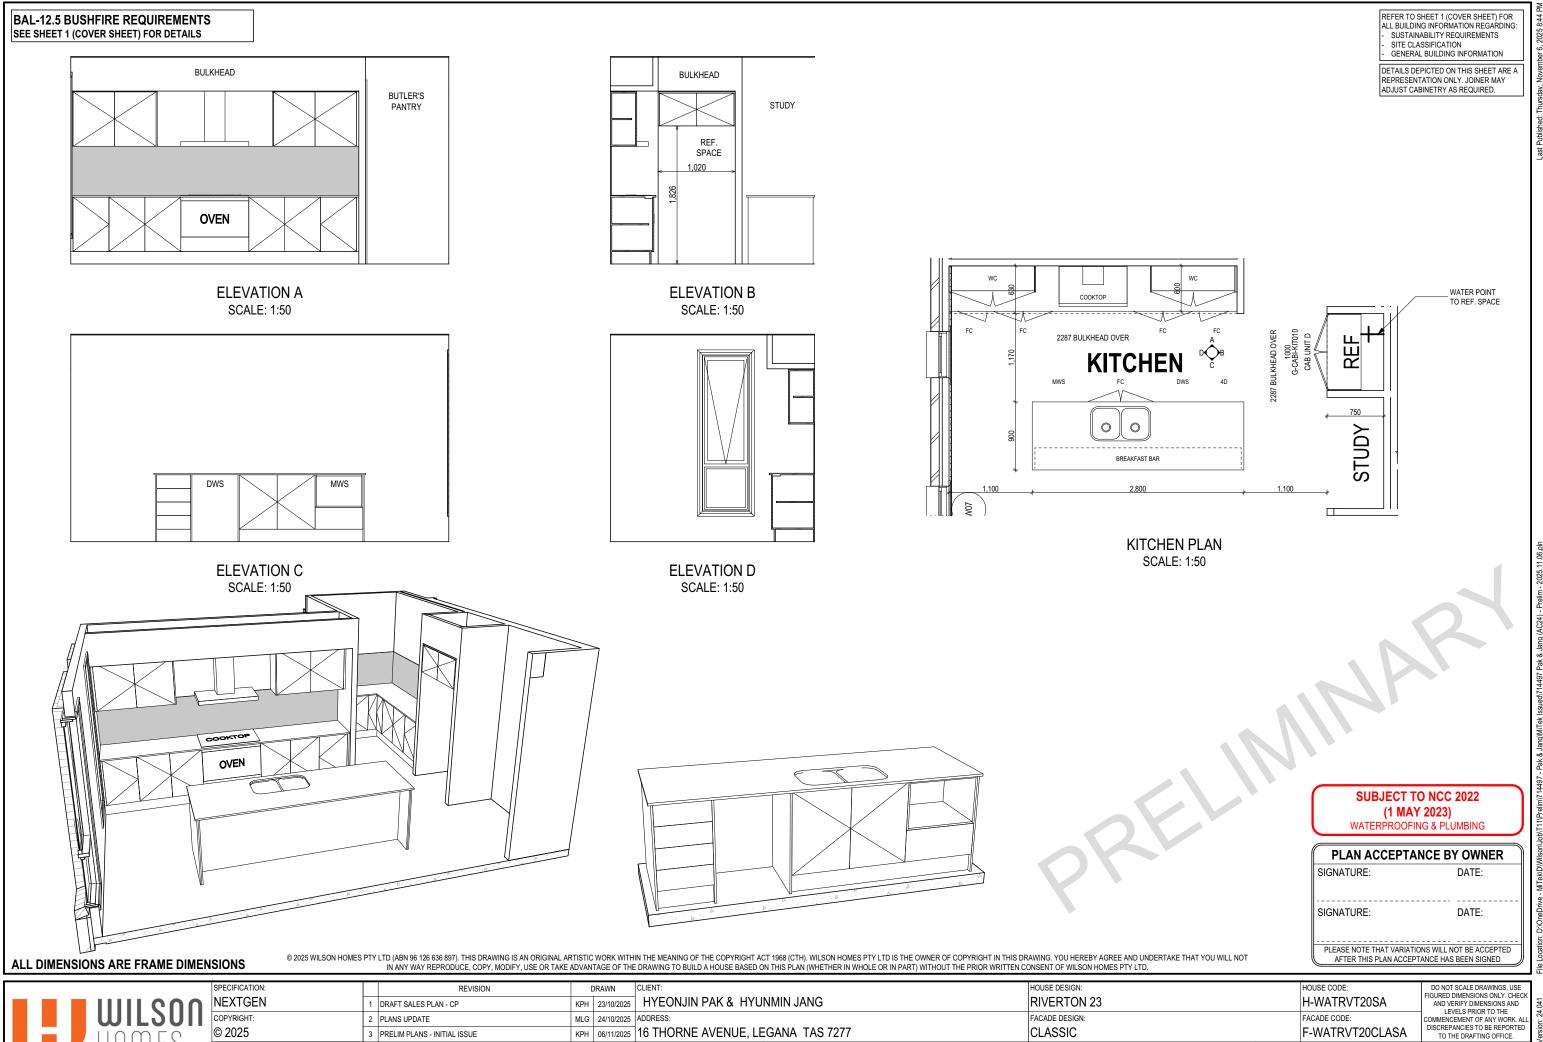
BAL-12.5 BUSHFIRE REQUIREMENTS
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			99 / - / 187077 WEST TAMAR	FLOOR COVERINGS	11 / 23	1:100	714497	Fempl

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KPH 06/11/2025 16 THORNE AVENUE, LEGANA TAS 7277

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3 PRELIM PLANS - INITIAL ISSUE

CLASSIC

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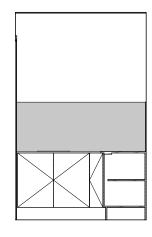
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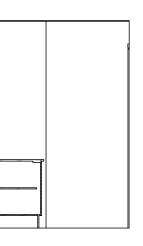
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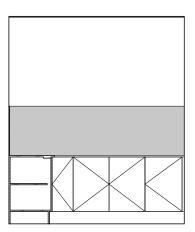
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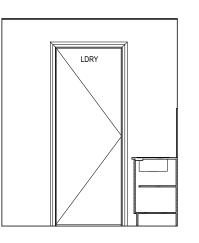
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ELEVATION C SCALE: 1:50

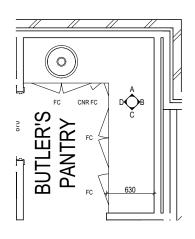


ELEVATION B SCALE: 1:50



ELEVATION D SCALE: 1:50

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JTLER'S PANTRY PLAN SCALE: 1:50

BUTLER'S PANTRY DETAILS

SUBJECT TO NCC 2022 (1 MAY 2023)

WATERPROOFING & PLUMBING

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NEXTGEN	1 DRAFT SALES PLAN - CP	KPH 2	23/10/2025	HYEONJIN PAK & HYUNMIN JANG	RIVERTON 23		H-WATRVT20SA
COPYRIGHT:	2 PLANS UPDATE	MLG 2	24/10/2025	ADDRESS:	FACADE DESIGN:		FACADE CODE:
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				LOT / SECTION / CT: COUNCIL:	SHEET TITLE:	SHEET No.:	SCALES:

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COMMENCEMENT OF ANY WORK. AL
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TO THE DRAFTING OFFICE.

714497

REFER TO SHEET 1 (COVER SHEET) FOR ALL BUILDING INFORMATION REGARDING: SUSTAINABILITY REQUIREMENTS SITE CLASSIFICATION GENERAL BUILDING INFORMATION



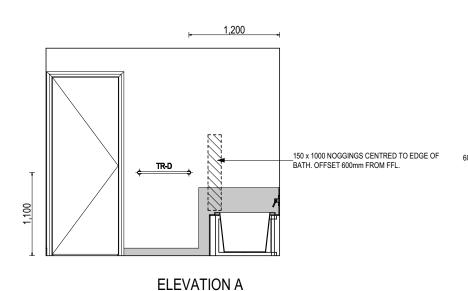


SHLF SHELF

SHAMPOO RECESS SOAP SOAP HOLDER

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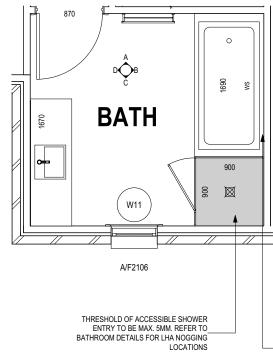
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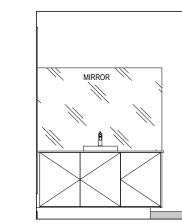
SCALE: 1:50

600 x 150 NOGGINGS CENTRED TO BATH. OFFSET 175mm FROM TOP OF BATH WE WE XX/19973

> **ELEVATION B** SCALE: 1:50



ACCESS PANEL LOCATION TO BE CONFIRMED ON SITE



ELEVATION D SCALE: 1:50

BATHROOM PLAN SCALE: 1:50

600 x 150 NOGGINGS . 800-810 HEIGHT (CTR

SUBJECT TO NCC 2022 (1 MAY 2023)

WATERPROOFING & PLUMBING

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600 x 150 NOGGINGS . 800-810 HEIGHT (CTR

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ELEVATION C

SCALE: 1:50

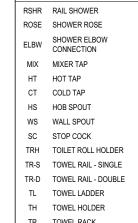
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				LOT / SECTION / CT: COUNCIL:	SHEET TITLE: SHEET No.:	SCALES:	744407
		1		99 / - / 187077 WEST TAMAR	BATHROOM DETAILS 14 / 23	1:50	714497

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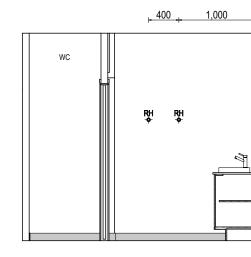
LEGEND



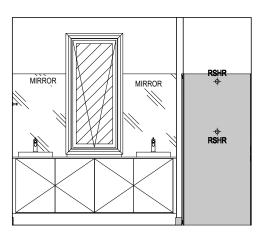
TR TOWEL RACK TMB TUMBLER HOLDER RNG TOWEL RING RH ROBE HOOK SHLF SHELF SR SHAMPOO RECESS

SOAP SOAP HOLDER

870 UC CSD 900 2155 BULKHEAD \boxtimes



ELEVATION B SCALE: 1:50



BULKHEAD

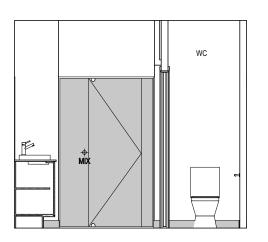
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ELEVATION A

SCALE: 1:50

OPENING

ELEVATION C SCALE: 1:50



ELEVATION D SCALE: 1:50

PLAN ACCEPTANCE BY OWNER SIGNATURE: DATE: SIGNATURE: DATE: PLEASE NOTE THAT VARIATIONS WILL NOT BE ACCEPTED AFTER THIS PLAN ACCEPTANCE HAS BEEN SIGNED

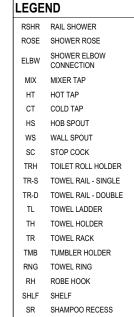
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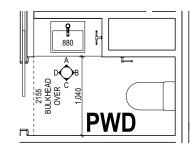
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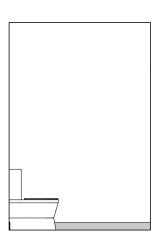


SOAP SOAP HOLDER

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ELEVATION B SCALE: 1:50





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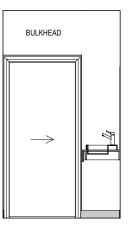
ELEVATION A

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ELEVATION C SCALE: 1:50



ELEVATION D SCALE: 1:50

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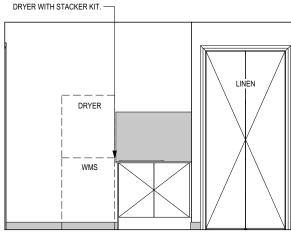
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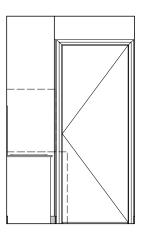
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			1	LOT / SECTION / CT: COUNCIL:	SHEET TITLE:	SHEET No.: SCALES:	744407
				99 / - / 187077 WEST TAMAR	POWDER ROOM DETAILS	16 / 23 1:50	714497

SITE CLASSIFICATION
 GENERAL BUILDING INFORMATION

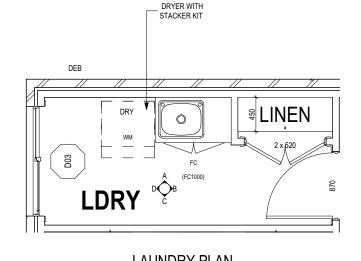
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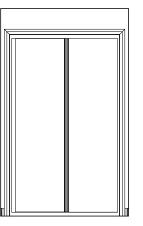


ELEVATION B SCALE: 1:50



LAUNDRY DETAILS

ELEVATION C SCALE: 1:50



SCALE: 1:50

SUBJECT TO NCC 2022 (1 MAY 2023)

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					LOT / SECTION / CT:	COUNCIL:	SHEET TITLE:

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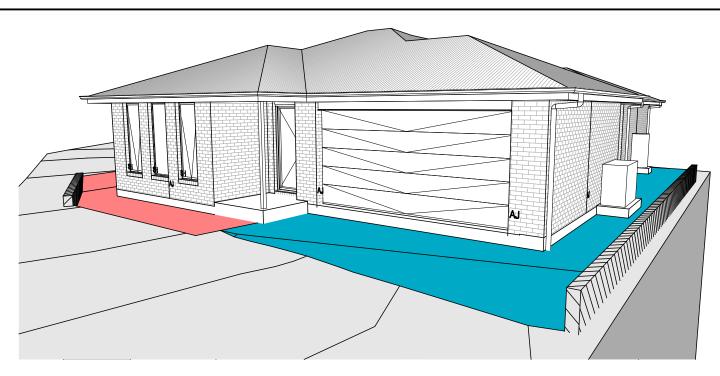
SHEET No.:
SCALES:
17 / 23

HOUSE CODE:
DO NOT SCALE DRAWINGS, USE FIGURED DIMENSIONS ONLY. CHECK AND VERIFY DIMENSIONS AND LEVELS PRIOR TO THE COMMENCEMENT OF ANY WORK. ALL DISCREPANCIES TO BE REPORTED TO THE DRAFTING OFFICE.

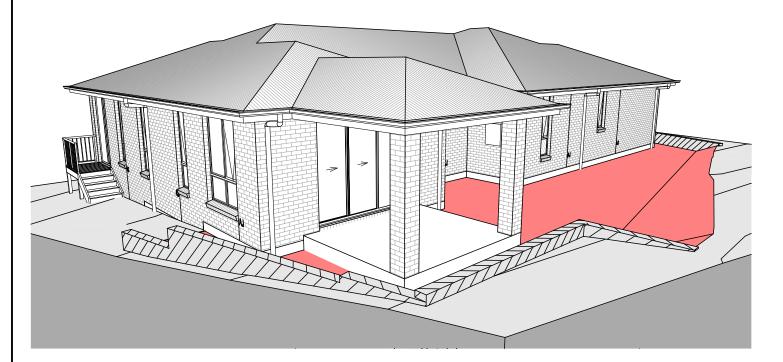
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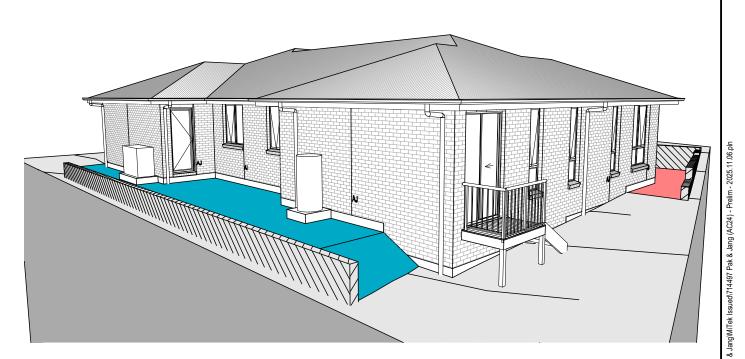




FRONT RIGHT



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SUBJECT TO NCC 2022 (1 MAY 2023)

WATERPROOFING & PLUMBING

PLAN ACCEPTANCE BY OWNER SIGNATURE: DATE:

DATE:

PLEASE NOTE THAT VARIATIONS WILL NOT BE ACCEPTED AFTER THIS PLAN ACCEPTANCE HAS BEEN SIGNED

SIGNATURE:

BAL-12.5 BUSHFIRE REQUIREMENTS SEE SHEET 1 (COVER SHEET) FOR DETAILS

NOTE: SITE LEVELS AND SETBACKS SHOWN ARE INDICATIVE ONLY AND SUBJECT TO A FINAL CONTOUR SURVEY AND REGISTERED REPORTS BEING COMPLETED. 3D IMAGES ARE FOR ILLUSTRATIVE PURPOSES ONLY AND ARE SUBJECT TO CHANGE.

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	SPECIFICATION:	REVISION	DRAWN	CLIENT:		HOUSE DESIGN:	HOUSE CODE:	DO NOT SCALE DRAWINGS, USE	1
n	NEXTGEN	1 DRAFT SALES PLAN - CP	KPH 23/10/2025	HYEONJIN PAK & HYU	JNMIN JANG	RIVERTON 23	H-WATRVT20SA	FIGURED DIMENSIONS ONLY. CHECK AND VERIFY DIMENSIONS AND LEVELS PRIOR TO THE	.041
Ш	COPYRIGHT:	2 PLANS UPDATE	MLG 24/10/2025	ADDRESS:		FACADE DESIGN:	FACADE CODE:	COMMENCEMENT OF ANY WORK. ALL	
_	© 2025	3 PRELIM PLANS - INITIAL ISSUE	KPH 06/11/2025	16 THORNE AVENUE, LE	EGANA TAS 7277	CLASSIC	F-WATRVT20CLASA	DISCREPANCIES TO BE REPORTED TO THE DRAFTING OFFICE.	/ersio
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				99 / - / 187077	WEST TAMAR	3D VIEWS 18 / 23		714497	E C

- BUILDER TO VERIFY ALL DIMENSIONS AND LEVELS ON SITE PRIOR TO COMMENCEMENT OF WORK
- ALL WORK TO BE CARRIED OUT IN ACCORDANCE WITH THE NATIONAL CONSTRUCTION CODE (NCC)
- INTERNAL DIMENSIONS ARE TO WALL FRAMING ONLY AND DO NOT INCLUDE WALL LININGS

SITE WORKS

GENERAL

- CUT AND FILL BATTERS ARE INDICATIVE ONLY. BATTER TO COMPLY WITH THE NCC TABLE 3.2.1
- ALL CUTS AND FFL'S SHOWN (DA DRAWINGS) ARE SUBJECT TO ENGINEERING ADVICE ONCE À SATISFACTORY SOIL TEST HAS BEEN RECEIVED AND REVIEWED
- ALL EMBANKMENTS THAT ARE LEFT EXPOSED MUST BE STABILISED WITH VEGETATION OR SIMILAR TO PREVENT
- EMBANKMENTS CANNOT EXCEED 2.0m IN HEIGHT WITHOUT THE AID OF RETAINING WALLS OR OTHER APPROVED TYPES OF SOIL RETAINING METHODS
- ALL UNPROTECTED EMBANKMENTS MUST COMPLY WITH THE SLOPE RATIOS FOR SOIL TYPE IN TABLE 3.2.1 OF THE NCC

SOIL TYPE /	EMBANKMENT OF SLOPE				
CLASSIFICATION	COMPACTED FILL	CUT			
STABLE ROCK (A)	3:3	8:1			
SAND (A)	1:2	1:2			
SILT (P)	1:4	1:4			
FIRM CLAY	1:2	1:1			
SOFT CLAY	NOT SUITABLE	2:3			
SOFT SOILS (P)	NOT SUITABLE	NOT SUITABLE			

MASONRY

- ALL MASONRY TO BE CONSTRUCTED IN ACCORDANCE WITH AS3700
- EXTERNAL WALLS TO BE 110mm BRICKWORK UNLESS NOTED OTHERWISE
- MORTAR MIXED @ 1:1:6 CEMENT:LIME:SAND UNLESS STATED OTHERWISE BY ENGINEER
- DAMP-PROOF COURSE IN ALL PERIMETER WALLS CUT INTO EXTERNAL WALLS BELOW FLOOR LEVEL WITH WEEP HOLES @ 1200 CTRS IN ACCORDANCE WITH AS2904
- VERTICAL ARTICULATION JOINTS TO BE PROVIDED @ 6m MAX. CTRS FOR UNREINFORCED MASONARY WALLS EXCEPT WHERE BUILT ON CLASS A OR S SOIL AND SPACED AS PER AS3700 SECTION 12.6.4. WILSON HOMES REQUEST THAT @ 5M
- WHERE NECESSARY, STEEL LINTELS ARE TO BE PROVIDED IN ACCORDANCE WITH AS4100 AND AS3700a

TIMBER FRAMING

- ALL WORK TO BE CARRIED OUT IN ACCORDANCE WITH THE CURRENT NCC
- ALL TIMBER FRAMING TO BE CARRIED OUT IN ACCORDANCE **WITH AS1684**
- MGP10 PINE FRAMING OR F17 SOLID AND FINGER JOINED FRAMING TO ALL STRUCTURAL COMPONENTS. 90 x 35mm FRAMING TO INTERNAL AND EXTERNAL WALLS. TIMBER COMPOSITE ENGINEERED ROOF TRUSSES WITH HARDWOOD AND MGP COMPONENTS
- GALVANISED WALL TIES TO MASONRY @ 450 CTRS HORIZONTALLY AND 600 CTRS VERTICALLY, WITH SPACING REDUCED BY 50% AROUND OPENINGS

BRACING / LINTELS

- WALL BRACING AS PER AS1684-2 2021 AND AS1170 WIND
- WALL BRACING AS SHOWN ON PLAN IS A MINIMUM ONLY. BUILDER TO PROVIDE ADDITIONAL BRACING TO SUIT THE CONSTRUCTION OF WALL FRAMES IN ACCORDANCE WITH GOOD BUILDING PRACTICE.
- PLYWOOD BRACING IN ACCORDANCE WITH AS1684 TABLE 8.18 (H) METHOD B. 900 WIDE SHEET PLY BRACING PANELS (6mm THICK F11 OR 4mm THICK F14) TO BE FIXED TO STUD FRAME WITH 2.8mm DIA x 30mm LONG MIN. FLAT HEAD NAILS.
- 65 x 19mm HW DIAGONAL TIMBER BRACING CHECKED INTO STUDS AND FIXED IN ACCORDANCE WITH AS1684

TIMBER LINTELS FOR SINGLE (OR UPPER STORY) TO BE F17 HARDWOOD AS FOLLOWS:

0 - 1500 120 x 35 1500 - 2400 140 x 35 2400 - 2700 190 x 35

TIEDOWN AND FIXING CONNECTIONS TO COMPLY WITH AS1684

STEEL LINTELS FOR SINGLE (OR UPPER STOREY) TO BE AS FOLLOWS:

0 - 2700 90 x 90 x 6 EA 2700 - 3200 100 x 100 x 8 EA 3200 - 4000 150 x 90 x 8 EA

*LINTELS REQUIRE 150mm BEARING EITHER SIDE OF OPENING

ALL LINTEL SIZES SHOWN ARE SUBJECT TO ENGINEERS DETAILS

CONCRETE

- CONCRETE FOOTING AND SLABS TO BE IN ACCORDANCE WITH AS2870
- CONCRETE TO BE MANUFACTURED TO COMPLY WITH AS3600 AND:
- HAVE A STRENGTH @ 28 DAYS OF NOT LESS THAN 25MpA (N25 GRADE)
- HAVE A 20mm NOMINAL AGGREGATE SIZE
- HAVE A NOMINAL 80mm SLUMP
- CONCRETE SLAB TO BE LAID OVER 0.2mm POLYTHENE MEMBRANE, 50mm WELL BEDDED SAND AND MINIMUM COMPACTED FCR (20mm)
- SLAB THICKNESS AND REINFORCEMENT TO BE AS PER ENGINEERS DESIGN

WINDOWS

- WINDOWS TO BE ALUMINIUM FRAMED SLIDING UNLESS NOTED OTHERWISE
- ALL WINDOWS TO BE FABRICATED AND INSTALLED IN ACCORDANCE WITH AS1288 AND AS2047 TO SPECIFIC WIND SPEED AS PER ENGINEERS REPORT
- ALL OPENING WINDOWS TO COMPLY WITH NCC 8 **REQUIREMENTS**
- AS PER NCC 11.3.6 ALL BEDROOM WINDOWS WHERE THE LOWEST OPENABLE PORTION OF THE WINDOW IS WITHIN 1.7m OF FFL AND THE FFL IS 2m OR MORE ABOVE NGL. REQUIRE A PERMANANTLY FIXED DEVICE RESTRICTING ANY OPENINGS OF THE WINDOW OR SCREEN SO THAT A 125mm SPHERE CANNOT PASS THROUGH: AND RESISTING OUTWARDS HORIZONTAL ACTION OF 250N AGAINST THE WINDOW. WHERE THE DEVICE OR SCREEN CAN BE REMOVED, UNLOCKED OR OVER-RIDDEN, THE DEVICE OR SCREEN MUST HAVE A CHILD RESISTANT RELEASE MECHANISM INSTALLED AND BARRIER BELOW THE WINDOW THAT IS 865mm HIGH ABOVE FFL AND RESTRICTS ANY OPENING WITHIN THE BARRIER SO THAT A 125mm SPHERE CANNOT PASS THROUGH, AND HAS NO HORIZONTAL OR NEAR HORIZONTAL ELEMENTS BETWEEN 150mm AND 760mm FROM FFL.
- GLAZING INSTALLED IN AREAS WITH HIGH POTENTIAL FOR HUMAN IMPACT TO COMPLY WITH NCC PART 8.4

DRAINAGE / WATER

- DRAINAGE TO BE DESIGNED AND CONSTRUCTED IN ACCORDANCE WITH AS3500 AND LOCAL AUTHORITY
- STORMWATER PIPES TO BE UPVC CLASS HD
- SEWER PIPES TO BE UPVC CLASS SH
- PROVIDE Ø20mm K2 POLYETHYLENE WATER RETICULATION
- TYPE B STOP VALVE TO BE LOCATED ADJACENT TO ENTRY
- BACKFILL ALL TRENCHES BENEATH VEHICLE PAVEMENT AND SLABS ON GRADE TO FULL DEPTH WITH 20 FCR
- PROVIDE OVERFLOW RELIEF GULLY WITH TAP OVER. INVERT LEVEL TO BE 150 MIN. BELOW LOWEST SANITARY DRAINAGE POINT
- CUT AND BATTER ARE INDICATIVE. BATTER TO COMPLY WITH **CURRENT NCC TABLE 3.1.1.1**
- AG DRAIN REQUIRED AROUND PERIMETER OF DWELLING FOR ALL CLASS M, H, E SITES. LOCATE AG DRAIN NOT CLOSER THAN 1.5m FROM FOOTINGS IN ACCORDANCE WITH AS2870 SECTION 5.6
- PROVIDE SURFACE DRAINAGE IN ACCORDANCE WITH AS2870 SECTION 5.6.3
- PROVIDE FLEXIBLE JOINTS IN ALL DRAINAGE EMERGING FROM UNDERNEATH OR ATTACHED TO BUILDING IN ACCORDANCE WITH AS2870 SECTION 5.6.4 FOR ALL CLASS H AND E SITES. REFER TO GEOTECH FOR FURTHER INFORMATION
- DOWNPIPES AND GUTTERS DESIGNED IN ACCORDANCE WITH AS/NZS 3500 3

STAIRCASES / BALUSTRADES / HANDRAILS

STAIR TREADS 240mm MIN. - 355mm MAX. STAIR RISERS 115mm MIN. - 190mm MAX.

- HANDRAIL REQUIRED WHERE CHANGE OF LEVEL BETWEEN FLOOR / LANDINGS > 1m AS PER CURRENT NCC 11.3.5
- NO GAPS IN STAIRCASES OR BALUSTRADE TO BE GREATER THAN 125mm
- BALUSTRADE REQUIRED WHERE LEVEL OF LANDING OR DECK IS GREATER THAN 1000mm ABOVE ADJACENT GROUND LEVEL
- BALUSTRADE TO BE MINIMUM 1000mm ABOVE FFL (INCLUDING ANY FLOOR COVERINGS)
- DOORS OPENING OUTWARDS EXTERNALLY MUST OPEN TO A LANDING (MIN. 750mm WIDE) WHERE THE DIFFERENCE IN LEVELS IS GREATER THAN 570mm
- NON-SLIP TREADS TO ALL TREADS AND TO COMPLY WITH NCC 11.2.4
- WHERE LANDINGS ARE NOT NOMINATED TO EXTERNAL DOORS. OPERATING DOOR LEAFS ARE TO BE SCREWED FIXED SHUT, OR PROVIDED WITH A FORMED FCR LANDING NOMINALLY 180mm BELOW FLOOR LEVEL.
- GLAZED BALUSTRADE AND HANDRAILS TO COMPLY WITH NCC PART 8.4, 11.3 AND AS1288 REQUIREMENTS

ROOFING

- ROOF TO BE COLORBOND 'CUSTOM ORB' METALDECK UNLESS NOTED OTHERWISE. PROVIDED AND INSTALLED IN ACCORDANCE WITH AS1562.1 (IF TILED REFER TO AS2050)
- PREFABRICATED ROOF TRUSSES TO BE SUPPLIED AND INSTALLED TO MANUFACTURERS SPECIFICATIONS, TRUSS MANUFACTURER TO CONFIRM LINTEL SIZES.

ELECTRICAL

- EXHAUST FAN TO COMPLY WITH CURRENT NCC PART 10.6.2 SECTION C
- EXHAUST FANS TO BE SEALED AND DUCTED TO OUTSIDE OF DWELLING IN ACCORDANCE WITH NCC VOLUME 2, PARTS 10.8.2 AND 10.8.3
- IF VENTING OCCURS DIRECTLY THROUGH WALLS/ROOF ADJACENT TO FAN. THEN UNIT REQUIRES SELF CLOSING BAFFLES TO BE CLASSIFIED AS A SEALED UNIT
- ELECTRICIAN IS TO ENSURE THAT ALL GPO'S IN WET AREAS MEET ALL STANDARD AND CODE REQUIREMENTS - ALL GPO'S TO BE 300mm FROM FFL UNLESS NOTED OTHERWISE

WET AREAS

- WALLS TO WET AREAS TO BE FINISHED WITH WET AREA PLASTERBOARD
- COMPLIANCE WITH NCC PART 10.2 AND AS3740
- ALL UNENCLOSED SHOWERS ABOVE BATHS TO HAVE MINIMUM 900mm SHOWER SCREEN OR FLOORWASTE WITHIN 1500mm OF SHOWER CONNECTION AS PER AS3740

CONDENSATION

- WHERE RAKED CEILINGS EXIST, IT IS HIGHLY RECCOMENDED THAT SUITABLE SPACING BETWEEN SARKING AND BULK INSULATION EXISTS. (NO CONTACT BETWEEN PRODUCTS). THE BUILDER IS TO ENSURE ADEQUATE SIZED TIMBER IS USED TO ENSURE THIS SEPARATION IS PROVIDED.
- IN STANDARD ROOF SPACES. IT IS HIGHLY RECOMMENDED TO PROVIDE SEPARATION BETWEEN SARKING AND CEILING INSULATION AROUND THE BUILDING PERIMETER, TO ENSURE AIRFLOW FROM EAVE VENTS IS MAINTAINED
- IT IS HIGHLY RECOMMENDED THAT ALL LIGHTWEIGHT CLADDING IS BATTENED OUT FROM STUDS (METAL / FC SHEET / TIMBER)

WOOD HEATERS

- ALL WOOD HEATERS ARE TO COMPLY WITH MANUFACTURERS SPECIFICATION AND NCC PART 12.4

FIRE SAFETY

- SMOKE ALARMS TO BE MAINS POWERED AND INSTALLED AS PER AS3786. LOCATIONS AS PER NCC 9.5.
- SMOKE ALARMS TO BE INTERCONNECTED WHERE THERE IS MORE THAN ONE ALARM
- INSTALLATION OF WOOD HEATERS TO COMPLY WITH AS2918. PROVIDE LOCAL AUTHORITIES WITH INSULATION AND **COMPLIANCE CERTIFICATES**

SUBJECT TO NCC 2022 (1 MAY 2023) WATERPROOFING & PLUMBING

PLAN ACCEPTANCE BY OWNER SIGNATURE: DATE: SIGNATURE: DATE: PLEASE NOTE THAT VARIATIONS WILL NOT BE ACCEPTED

AFTER THIS PLAN ACCEPTANCE HAS BEEN SIGNED

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WEST TAMAR

NEXTGEN

REVISION DRAWN KPH 23/10/2025 HYEONJIN PAK & HYUNMIN JANG DRAFT SALES PLAN - CP MLG 24/10/2025 ADDRESS: 2 PLANS UPDATE KPH 06/11/2025 16 THORNE AVENUE, LEGANA TAS 7277 3 PRELIM PLANS - INITIAL ISSUE LOT / SECTION / CT: COUNCIL .

99 / - / 187077

OUSE DESIGI **RIVERTON 23** FACADE DESIGN:

GENERAL NOTES

CLASSIC

SHEET TITLE:

HOUSE CODE H-WATRVT20SA FACADE CODE F-WATRVT20CLASA

SCALES:

SHEET No :

19 / 23

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WET AREA NOTES

VESSELS OR AREA WHERE THE FIXTURE IS INSTALLED	FLOORS AND HORIZONTAL SURFACES	WALLS	WALL JUNCTIONS AND JOINTS	PENETRATIONS
ENCLOSED SHOWER WITH HOB	WATERPROOF ENTIRE ENCLOSED SHOWER AREA INCLUDING HOB.	WATERPROOF TO NOT LESS THAN 150mm ABOVE THE SHOWER FLOOR SUBSTRATE OR NOT LESS THAN 25mm ABOVE THE MAXIMUM RETAINED WATER LEVEL WHICH EVER IS THE GREATER WITH THE REMAINDER BEING WATERPROOF TO A HEIGHT OF NOT LESS THAN 1800mm ABOVE THE FINISHED FLOOR LEVEL.	WATERPROOF INTERNAL AND EXTERNAL CORNERS AND HORIZONTAL JOINTS WITHIN A HEIGHT OF 1800mm ABOVE THE FLOOR LEVEL WITH NOT LESS THAN 40mm WIDTH EITHER SIDE OF THE JUNCTION.	WATERPROOF ALL PENETRATIONS.
ENCLOSED SHOWER WITHOUT HOB	WATERPROOF ENTIRE ENCLOSED SHOWER AREA, INCLUDING WATERSTOP.	WATERPROOF TO NOT LESS THAN 150mm ABOVE THE SHOWER FLOOR SUBSTRATE WITH THE REMAINDER BEING WATERPROOF TO A HEIGHT OF NOT LESS THAN 1800mm ABOVE THE FINISHED FLOOR LEVEL.	WATERPROOF INTERNAL AND EXTERNAL CORNERS AND HORIZONTAL JOINTS WITHIN A HEIGHT OF 1800mm ABOVE THE FLOOR LEVEL WITH NOT LESS THAN 40mm WIDTH EITHER SIDE OF THE JUNCTION.	WATERPROOF ALL PENETRATIONS.
ENCLOSED SHOWER WITH STEPDOWN	WATERPROOF ENTIRE ENCLOSED SHOWER AREA INCLUDING THE STEPDOWN.	WATERPROOF TO NOT LESS THAN 150mm ABOVE THE SHOWER FLOOR SUBSTRATE OR NOT LESS THAN 25mm ABOVE THE MAXIMUM RETAINED WATER LEVEL WHICHEVER IS THE GREATER WITH THE REMAINDER BEING WATERPROOF TO A HEIGHT OF NOT LESS THAN 1800mm ABOVE THE FINISHED FLOOR LEVEL.	WATERPROOF INTERNAL AND EXTERNAL CORNERS AND HORIZONTAL JOINTS WITHIN A HEIGHT OF 1800mm ABOVE THE FLOOR LEVEL WITH NOT LESS THAN 40mm WIDTH EITHER SIDE OF THE JUNCTION.	WATERPROOF ALL PENETRATIONS.
ENCLOSED SHOWER WITH PRE-FORMED SHOWER BASE	N/A	WATERPROOF TO A HEIGHT OF NOT LESS THAN 1800mm ABOVE FINISHED FLOOR LEVEL.	WATERPROOF INTERNAL AND EXTERNAL CORNERS AND HORIZONTAL JOINTS WITHIN A HEIGHT OF 1800mm ABOVE THE FLOOR LEVEL WITH NOT LESS THAN 40mm WIDTH EITHER SIDE OF THE JUNCTION.	WATERPROOF ALL PENETRATIONS.
UNENCLOSED SHOWERS	WATERPROOF ENTIRE UNCLOSED SHOWER AREA.	WATERPROOF TO NOT LESS THAN 150mm ABOVE THE SHOWER FLOOR SUBSTRATE OR NOT LESS THAN 25mm ABOVE THE MAXIMUM RETAINED WATER LEVEL WHICH EVER IS THE GREATER WITH THE REMAINDER BEING WATERPROOF TO A HEIGHT OF NOT LESS THAN 1800mm ABOVE THE FINISHED FLOOR LEVEL.	WATERPROOF INTERNAL AND EXTERNAL CORNERS AND HORIZONTAL JOINTS WITHIN A HEIGHT OF 1800mm ABOVE THE FLOOR LEVEL WITH NOT LESS THAN 40mm WIDTH EITHER SIDE OF THE JUNCTION.	WATERPROOF ALL PENETRATIONS.
AREAS OUTSIDE THE SHOWER AREA FOR CONCRETE AND COMPRESSED FIBRE CEMENT SHEET FLOORING	WATER RESISTANT TO ENTIRE FLOOR.	N/A	WATERPROOF ALL WALL/FLOOR JUNCTIONS. WHERE A FLASHING IS USED THE HORIZONTAL LEG MUST BE NOT LESS THAN 40mm.	N/A
AREAS OUTSIDE THE SHOWER AREA FOR TIMBER FLOORS INCLUDING PARTICLEBOARD, PLYWOOD AND OTHER TIMBER BASED FLOORING MATERIALS	WATERPROOF ENTIRE FLOOR.	N/A	WATERPROOF ALL WALL/FLOOR JUNCTIONS. WHERE A FLASHING IS USED THE HORIZONTAL LEG MUST BE NOT LESS THAN 40mm.	N/A
AREAS ADJACENT TO BATHS AND SPAS FOR CONCRETE AND COMPRESSED FIBRE CEMENT SHEET FLOORING.	WATER RESISTANT TO ENTIRE FLOOR.	WATERPROOF TO A HEIGHT OF NOT LESS THAN 150mm ABOVE THE VESSEL AND EXPOSED SURFACES BELOW THE VESSEL LIP TO FLOOR LEVEL.	WATERPROOF EDGES OF THE VESSEL AND JUNCTION OF BATH ENCLOSURE WITH FLOOR. WHERE THE LIP OF THE BATH IS SUPPORTED BY A HORIZONTAL SURFACE, THIS MUST BE WATERPROOF FOR SHOWERS OVER BATH AND WATER RESISTANT FOR ALL OTHER CASES.	WATERPROOF ALL TAP AND SPOUT PENETRATIONS WHERE THEY OCCUR IN A HORIZONTAL SURFACE.
AREAS ADJACENT TO BATHS AND SPAS (SEE NOTE 1) FOR TIMBER FLOORS INCLUDING PARTICLEBOARD, PLYWOOD AND OTHER TIMBER BASED FLOORING MATERIALS.	WATERPROOF ENTIRE FLOOR.	WATERPROOF TO A HEIGHT OF NOT LESS THAN 150mm ABOVE THE VESSEL AND EXPOSED SURFACES BELOW THE VESSEL LIP TO FLOOR LEVEL.	WATERPROOF EDGES OF THE VESSEL AND JUNCTION OF BATH ENCLOSURE WITH FLOOR. WHERE THE LIP OF THE BATH IS SUPPORTED BY A HORIZONTAL SURFACE, THIS MUST BE WATERPROOF FOR SHOWERS OVER BATH AND WATER RESISTANT FOR ALL OTHER CASES.	WATERPROOF ALL TAP AND SPOUT PENETRATIONS WHERE THEY OCCUR IN A HORIZONTAL SURFACE.
INSERTED BATHS	N/A FOR FLOOR UNDER BATH. ANY SHELF AREA ADJOINING THE BATH OR SPA MUST BE WATERPROOF AND INCLUDE A WATERSTOP UNDER THE VESSEL LIP.	N/A FOR WALL UNDER BATH. WATERPROOF TO NOT LESS THAN 150mm ABOVE THE LIP OF THE BATH.	N/A FOR WALL UNDER BATH. WATERPRROF TO NOT LESS THAN 150 mm ABOVE THE LIP OF A BATH OR SPA.	WATERPROOF ALL TAP AND SPOUT PENETRATIONS WHERE THEY OCCUR IN A HORIZONTAL SURFACE.
WALLS ADJOINING OTHER VESSELS (EG. SINKS, LAUNDRY TUBS AND BASINS)	N/A	WATERPROOF TO A HEIGHT OF NOT LESS THAN 150mm ABOVE THE VESSEL IF THE VESSEL IS WITHIN 75mm OF THE WALL.	WHERE THE VESSEL IS FIXED TO A WALL, WATERPROOF EDGES FOR EXTENT OF VESSEL.	WATERPROOF ALL TAP AND SPOUT PENETRATIONS WHERE THEY OCCUR IN A HORIZONTAL SURFACE.
LAUNDRIES AND WCS	WATER RESISTANT TO ENTIRE FLOOR.	WATERPROOF ALL WALL/FLOOR JUNCTIONS TO NOT	WATERPROOF ALL WALL/FLOOR JUNCTIONS.	N/A

THE ABOVE INFORMATION IS FOR GENERAL GUIDANCE AND IS INDICATIVE ONLY. WATERPROOFING INSTALLERS TO COMPLY WITH ALL CURRENT CODES OF LEGISLATION WHICH TAKE PRECEDENCE OVER THIS SPECIFICATION.

LESS THAN 25mm ABOVE THE FINISHED FLOOR LEVEL,

WET AREA WAERPROOFING BY LICENSED AND ACCREDITED INSTALLER. CERTIFICATION TO BE PROVIDED TO BUILDING SURVEYOR. CONTRACTOR OR BUILDER TO DETERMINE THE APPROPRIATE WATERPROOFING IN ACCORDANCE WITH AS3740 PART 10.2 OF N.C. CAND TO NOTIFY THE RUII DING SURVEYOR FOR INSPECTION ARRANGEMENTS DURING INSTALLATION.

SEALED TO FLOOR.

ENERGY EFFICIENCY - GENERAL

STATED R VALUES ARE FOR ADDITIONAL INSULATION REQUIRED AND ARE NOT RT VALUES (TOTAL SYSTEM VALUE)

INSULATION TO BE INSTALLED TO MANUFACTURERS SPECIFICATIONS AND ANY RELEVANT STANDARDS

BULK INSULATION IS NOT TO BE COMPRESSED AS THIS REDUCES THE EFFECTIVE R RATING

WAFFLE POD ALLOWANCES:

- R0.6 175mm DEEP
- R0 7 225mm DEEP - R0.8 - 300mm DEEP
- R0.9 375mm DEEP

N.C.C 2022 TAS PART H6

IN TASMANIA, FOR NCC PART H6 REFER TO NCC 2019 AMENDMENT 1 PART 2.6; FOR NCC PART 13.1 REFER TO NCC 2019 PART 3.12

N.C.C 2019 3.12.0 (A)

PERFORMANCE REQUIREMENT P2.6.1 FOR THE THERMAL PERFORMANCE OF THE BUILDING IS SATISFIED BY COMPLYING WITH:

3.12.0.1 - FOR REDUCING THE HEATING AND COOLING LOADS

TO REDUCE HEATING AND COOLING LOADS MUST ACHIEVE AN ENERGY RATING USING HOUSING ENERGY RATING SOFTWARE OF NOT LESS THAN 6

3.12.1.1 - FOR BUILDING FABRIC THERMAL INSULATION

BUILDER TO ENSURE THAT ALL INSULATION COMPLIES WITH AS/NZS 4859.1 AND BE INSTALLED TO N.C.C 3.12.1.1.

3.12.1.2(e) - FOR COMPENSATING FOR A LOSS OF CEILING INSULATION REFER TO ATTACHED THERMAL PERFORMANCE CERTIFICATE

- (i) IF ALLOWANCE HAS BEEN MADE FOR CEILING PENERATIONS IN NATHERS (FIRST RATE 5) CERTIFICATION PROCESS THEN NO FURTHER ACTION REQUIRED.
- (ii) IF NO ALLOWANCE HAS BEEN MADE FOR CEILING PENETRATIONS IN NATHERS (FIRST RATE 5) CERTIFICATION PROCESS THEN CEILING PENETRATION AREA MUST BE CALCULATED AND THE NECESSARY ADJUSTMENT MADE TO THE SPECIFIED INSULATION AS PER TABLE 3.12.1.1B OF NCC

3.12.1.5(c) AND 3.12.1.5(d) - FOR FLOOR EDGE INSULATION FOR CONCRETE SLAB ON GROUNG WITH IN SLAB HEATING OR COOLING.

3.12.3 - FOR BUILDING SEALING

3.12.3.1 - CHIMNEYS AND FLUES

THE CHIMNEY OR FLUE OF AN OPEN SOLID FUEL BURNING APPLIANCE MUST BE PROVIDED WITH A DAMPER OR FLAP THAT CAN BE CLOSED TO SEAL THE

3.12.3.2 - ROOF LIGHTS

- (a) A ROOF LIGHT MUST BE SEALED, OR CAPABLE OF BEING SEALED WHEN
- (i) A CONDITIONED SPACE; OR
- ii) A HABITABLE ROOM IN CLIMATE ZONES 4, 5, 6, 7 OR 8
- (b) A ROOF LIGHT REQUIRED BY (a) TO BE SEALED, OR CAPABLE OF BEING SEALED MUST BE CONSTRUCTED WITH: (i) AN IMPEREORATE CEILING DIFFUSER OR THE LIKE INSTALLED AT A
 - CEILING OR INTERNAL LINING LEVEL; OR
- (ii) A WATERPROOF SEAL; OR
- (iii) A SHUTTER SYSTEM READILY OPERATED MANUALLY, MECHANICALLY OR ELECTRONICALLY BY THE OCCUPANT

- 3.12.0.1 EXTERNAL WINDOWS AND DOORS

 (a) A SEAL TO RESTRIC AIR INFILTRATION MUST BE FITTED TO EACH OF AN EXTERNAL DOOR, OPENABLE WINDOW AND OTHER SUCH OPENING:
- (I) WHEN SERVING A CONDITIONED SPACE; OR
- (II) IN CLIMATE ZONES 4, 5, 6, 7 OR 8, WHEN SERVING A HABITABLE ROOM
- (b) A WINDOW COMPLYING WITH THE MAXIMUM AIR INFILTRATION RATES SPECIFIED IN AS2047 NEED NOT COMPLY WITH (a).
- (c) A SEAL REQUIRED BY (a)
- (i) FOR THE BOTTOM EDGE OF AN INTERNAL SWING DOOR, MUST BE A DRAFT PROTECTION DEVICE; AND
- (ii) FOR THE OTHER EDGES OF AN EXTERNAL SWING DOOR OR THE EDGES OF AN OPENABLE WINDOW OR OTHER SUCH OPENING, MAY BE A FOAM OR RUBBER COMPRESSIBLE STRIP, FIBROUS SEAL OR

3.12.3.4 - EXHAUST FANS

AN EXHAUST FAN MUST BE FITTED WITH A SEALING DEVICE SUCH AS A SELF CLOSE DAMPER, FILTER OR THE LIKE WHEN SERVING:

(a) A CONDITIONED SPACE: OR

(b) A HABITABLE ROOM IN THE CLIMATE ZONES 4, 5, 6, 7 OR 8.

3.12.3.5 - CONSTRUCTION OF ROOF, WALLS AND FLOORS

- (a) ROOFS, EXTERNAL WALLS, EXTERNAL FLOORS AND AN OPENING SUCH AS A WINDOW FRAME, DOOR FRAME, ROOF LIGHT FRAME OR THE LIKE MUST BE CONSTRUCTED TO MINIMISE AIR LEAKAGE IN ACCORDANCE WITH (b) WHEN FORMING PART OF THE EXTERNAL FABRIC OF:
- (i) A CONDITIONED SPACE; OR
- (ii) A HABITABLE ROOM IN CLIMATE ZONE 4, 5, 6, 7 OR 8.
- (b) CONSTRUCTION REQUIRED BY (a) MUST BE:
- (i) ENCLOSED BY AN INTERNAL LINING SYSTEM THAT ARE CLOSE FITTING AT CEILING, WALL AND FLOOR JUNCTIONS; OR
- (ii) SEALED BY CAULKING, SKIRTING, ARCHITRAVES, CORNICES OR THE

3.12.3.6 - EVAPORATIVE COOLERS

AN EVAPORATIVE COOLER MUST BE FITTED WITH A SELF CLOSING DAMPER OR THE LIKE WHEN SERVING:

(a) A HEATED SPACE: OR

(b) A HABITABLE ROOM IN CLIMATE ZONES 4, 5, 6, 7 OR 8.

3.12.5.5 - ARTIFICIAL LIGHTING

- (a) LAMP POWER DENSITY OR ILLUMINATION POWER DENSITY OF AN ARTIFICIAL LIGHT, EXCLUDING HEATING THAT EMITS LIGHT, MUST NOT EXCEED THE ALLOWANCE OF:
- (i) 5W/m2 IN A CLASS 1 BUILDING
- (ii) 4W/m² ON A VERANDAH, BALCONY OR THE LIKE ATTACHED TO A CLASS 1 BUILDING (NOT EXCLUDING EAVE PERIMETER LIGHTS);
- (iii) 3W/m2 IN A CLASS 10A BUILDING ASSOCIATED WITH A CLASS 1 BUILDING.
- (b) THE ILLUMINATION POWER DENSITY ALLOWANCE IN (a) MAY BE INCREASED BY DIVIDING IT BY THE ILLUMINATION POWER DENSITY ADJUSTMENT FACTOR FOR A CONTROL DEVICE AS PER N.C.C TABLE 3.12.5.3.

SUBJECT TO NCC 2022 (1 MAY 2023)

WATERPROOFING & PLUMBING

PLAN ACCEPTA	NCE BY OWNER	Wilso
SIGNATURE:	DATE:	ve - MiTek\D\Wilso
SIGNATURE:	DATE:	on: D:\OneDrive
PLEASE NOTE THAT VARIATION AFTER THIS PLAN ACCEPT		Location:

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SPECIFICATION:		REVISION	[RAWN	CLIENT:		HOUSE DESIGN:	HOUSE CODE:	DO NOT SCALE DRAWINGS, USE FIGURED DIMENSIONS ONLY. CHECK
NEXTGEN	1	DRAFT SALES PLAN - CP	KPH	23/10/2025	HYEONJIN PAK & HYU	NMIN JANG	RIVERTON 23	H-WATRVT20SA	AND VERIFY DIMENSIONS AND LEVELS PRIOR TO THE
COPYRIGHT:	2	PLANS UPDATE	MLG	24/10/2025	ADDRESS:		FACADE DESIGN:		COMMENCEMENT OF ANY WORK. ALL
9 2025	3	PRELIM PLANS - INITIAL ISSUE	KPH	06/11/2025	16 THORNE AVENUE, LE	EGANA TAS 7277	CLASSIC	F-WATRVT20CLASA	DISCREPANCIES TO BE REPORTED TO THE DRAFTING OFFICE.
					LOT / SECTION / CT:	COUNCIL:	SHEET TITLE: SHEET No.:	SCALES:	744407
					99 / - / 187077	WEST TAMAR	WET AREA & ENERGY EFFICIENCY NOTES 20 / 23		714497

Requirements for Building In Bushfire Hazard Areas Building Act 2016

Directors Determination - Bushfire Hazard Areas V1.1, dated 08 April 2021

Deemed-to-Satisfy Requirements (Part 2.3)

2.3.1 Design and construction

(1) Building work in a bushfire-prone area must be designed and constructed in accordance with either: -

(b)Standard for Steel Framed Construction in Bushfire Areas published (b)Standard for Steel Framed Construction in Bushire Areas published by the National Association of Steel Framed Housing Inc. (NASH). as appropriate for a BAL determined for that site using table 2.6 of AS 3959. (2) Subclause (1)(a) is only applicable to the following:

(a) a Class 1, 2 or 3 building; or

(b) a Class 10a building or deck associated with a Class 1, 2 or 3 building.

(3) Subclause (1)(b) is only applicable to the following:

(a) a Class 1 building; or (b) a Class 10a building or deck associated with a Class 1 building.

(4) Despite subsection (1) permissible, variations from requirements specified in 1(a) and 1(b) are as specified in Table 1.
(5) Despite subsections (1) and (4), performance requirements for buildings subject to BAL 40 or BAL Flame Zone (BAL-FZ) are not satisfied by compliance with subsections (1) or (4).

2.3.2 Property Access

2.3.2 Property Access

(1) A new building in a bushfire-prone area must be provided with property access to the building area and the firefighting water point, accessible by a carriageway, designed and constructed as specified in subclause (4).

(2) For an addition or alteration to an existing building in a bushfire-prone area, if there is no property access awailable property access must be provided to the building area and the firefighting water point accessible by a carriageway as specified in subclause (4).

(3) An addition or alteration to an existing building in a bushfire-prone area must not restrict any existing property access to the building area or to water supply for firefighting.

(4) Vehicular access from a public road to a building must:

(a) comply with the property access requirements specified in Table 2;

(b) include access from a public road to within 90 metres of the furthest part of the building measured as a hose lay; and

(c) include access to the hardstand area for the firefighting water point.

2.3.3 Water Supply for Fire fighting

(1) A new building constructed in a bushfire-prone area, must be provided with a water supply dedicated for fire fighting purposes as specified in Table 3A or Table 3B.

(2) For an addition or alteration to an existing building in a bushfire-prone area, if there is no water supply for firefighting available the building must be provided with a water supply dedicated for firefighting purposes which complies with the requirements specified in Table 3A or Table 3B.

complies with the requirements specified in Table 3A or Table 3B.

2.3.4 Hazard Management Areas

(1) A new building, and an existing building in the case of an addition or alteration to a building, in a bushfire-prone area must be provided with a hazard management area.

(2) The hazard management area must comply with the requirements specified in Table 4.

(3) The hazard management area for a particular BAL must have the minimum dimensions required for the separation distances specified for that BAL in Table 2.6 of AS 3959.

(4) The hazard management area must be established and maintained such that fuels are reduced sufficiently, and other hazards are removed such that the fuels are reduced sufficiently, and other hazards are removed such that the fuels and other hazards do not significantly contribute to the bushfire attack.

2.3.5 Bushfire emergency plan

An emergency plan must be provided for:
 a new building;

(b) an existing building in the case of an addition or alteration to a building:

building:

(c) an existing building in the case of a change of building class;

(d) a building associated with the use, handling, generation or storage of a hazardous chemical or explosive; in a bushfire-prone area.

(2) A bushfire emergency plan must comply with the requirements specified in Table 5.

7. Interpretation of Tables

7. Interpretation of Tables (1) For the purposes of the deemed-to-satisfy provisions in clause 2.3 of this Determination, Tables 1, 2, 3A, 3B, 4, and 5 must be complied with in the following way: (a) for a particular element specified in column 1, the corresponding requirement specified in column 2 must be complied with.

Table 1 - Construction Requirements & Construction Variations

	Column 1	Column 2
ELEMENT		REQUIREMENT
A. Straw Bale Construction		May be used in exposures up to and including BAL 19.
В.	Shielding provisions under Section 3.5 of AS3959-2018	To reduce construction requirements due to shielding, building plans must include suitable detailed elevations or plans that demonstrate that the requirements of Section 3.5 of the Standard can be met.
		Comment: Application of Section 3.5 of the Standard cannot result in and assessment of BAL-LOW.

Table 2 - Requirements for Property Access

	Column 1			
	ELEMENT	REQUIREMENT		
A.	Property access length is less than 30 metres; or access is not for a fire appliance to access a water connection point.	There are no specified design and construction requirements.		
В.	Property access length is 30 metres or greater; or access for a fire appliance to a water connection point.	The following design and construction requirements apply to property access: (1) All-weather construction; (2) Load capacity of at least 20 tonnes, including for bridges and culverts; (3) Minimum carriageway widths of 4 metres; (4) Minimum vertical clearance of 4 metres; (5) Minimum horizontal clearance of 0.5 metres from the edge of the carriageway; (6) Cross falls of less than 3° (1:20 or 5%); (7) Dips less than 7° (1:8 or 12.5%) entry and exit angle; (8) Curves with a minimum inner radius of 10 metres; (9) Maximum gradient of 15° (1:3.5 or 28%) for sealed roads, and 10° (1:5.5 or 18%) for unsealed roads; and (10) Terminate with a turning area for fire appliances provided by one of the following: (a) A turning circle with a minimum inner radius of 10 metres; (b) A property access encircling the building; or (c) A hammerhead "T" or "Y" turning head 4 metres wide and 8 metres long.		
C.	Property access length is 200 metres or greater.	The following design and construction requirements apply to property access: (1) The Requirements for B above; and (2) Passing bays of 2 metres additional carriageway width and 20 metres length provided every 200 metres.		
D.	Property access length is greater than 30 metres, and access is provided to 3 or more properties.	The following design and construction requirements apply to property access: (1) Complies with Requirements for B above; and (2) Passing bays of 2 metres additional carriageway width and 20 metres length must be provided every 100 metres.		

Table 3A - Reticulated Water Supply for Firefighting

Column		Column 2				
	ELEMENT	REQUIREMENT				
Α.	Distance between building area to be protected and water supply	The following requirements apply: (1) The building area to be protected must be located within 120 metres of a fire hydrant; and (2) The distance must be measured as a hose lay, between the water connection point and the furthest part of the building area.				
В.	Design criteria for fire hydrants	The following requirements apply: (1) Fire hydrant system must be designed and constructed in accordance with TasWater Supplement to Water Supply Code of Australia WSA 03 - 2011-3.1 MRWA Edition 2.0; and (2) Fire hydrants are not installed in parking areas.				
C.	Hardstand	A hardstand area for fire appliances must be provided: (1) no more than three metres from the hydrant, measured as a hose lay; (2) No closer than six metres from the building area to be protected; (3) With a minimum width of three metres constructed to the same standard as the carriageway; and (4) Connected to the property access by a carriageway equivalent to the standard of the property access				

Table 3B - Static Water Supply for Firefighting

Column 1 ELEMENT		REQUIREMENT		
Α.	Distance between building area to be be protected and water supply	The following requirements apply: (a) The building area to be protected must be located within 90 metres of the water connection point of a static water supply; and (b) The distance must be measured as a hose lay, between the water connection point and the furthest part of the building area.		
B.	Static Water Supplies	A static water supply: (a) May have a remotely located offtake connected to the static water supply; (b) May be a supply for combined use (fire fighting and other uses) but the specified minimum quantity of fire fighting water must be available at all times; (c) Must be a minimum of 10,000 litres per building area to be protected. This volume of water must not be used for any other purpose including fire fighting sprinkler or spray systems; (d) Must be metal, concrete or lagged by non-combustible materials if above ground; and (e) If a tank can be located so it is shielded in all directions in compiliance with Section 3.5 of AS 3959-2018, the tank may be constructed of any material provided that the lowest 400 mm of the tank exterior is protected by: (i) mon-combustible material; or (iii) fibre-cement a minimum of 6 mm thickness.		
C.	Fittings, pipework and accessories (including stands and tank supports)	Fittings and pipework associated with a water connection point for a static water supply must: (a) Have a minimum nominal internal diameter of 50mm; (b) Be fitted with a valve with a minimum nominal internal diameter of 50mm; (c) Be metal or lagged by non-combustible materials if above ground; (d) Where buried, have a minimum depth of 300mm (e) Provide a Din or NEN standard forged Storz 65 mm coupling fitted with a suction washer for connection to fire fighting equipment; (f) Ensure the coupling is accessible and available for connection at all times; (g) Ensure the coupling is fitted with a blank cap and securing chain (minimum 220 mm length); (h) Ensure underground tanks have either an opening at the top of not less than 250 mm diameter or a coupling compilant with this Table; and (i) Where a remote offtake is installed, ensure the offtake is in a position that is: (i) Visible; (ii) Accessible to allow connection by fire fighting equipment; (iii) At a working height of 450 - 600mm above ground level; and (iv) Protected from possible damage, including damage by vehicles.		
D.	Signage for static water connections	(1)The water connection point for a static water supply must be identified by a sign permanently fixed to the exterior of the assembly in a visible location. The sign must: (a) comply with water tank signage requirements within AS 2304; or (b) comply with the TFS Water Supply Signage Guideline.		
E.	Hardstand	A hardstand area for fire appliances must be provided: (a) No more than three metres from the water connection point, measured as a hose lay (including the minimum water level in dams, swimming pools and the like); (b) No closer than six metres from the building area to be protected; (c) With a minimum width of three metres constructed to the same standard as the carriageway; and (d) Connected to the properly access by a carriageway equivalent to the standard of the property access.		

Table 4 - Requirements for Hazard Management Area

Column 1		Column 2		
	ELEMENT	REQUIREMENT		
В.	Hazard managements areas for new buildings on lots provided with a BAL at the time of subdivision. Hazard management areas for new buildings	A new building must: (a) Be located on the lot so as to be provided wih a HMA no smaller than the required separation distances for the BAL determined at the time of the subdivision; and (b) Have a HMA established in accordance with a certified bushfire hazard management plan. A new building must: (a) Be located on the lot so as to be provided with a HMA no		
	on lots not provided with a BAL at the time of sub division.	smaller than the separation distances required for BAL 29; and (b) Have an HMA established in accordance with a certified bushfire hazard management plan.		
С.	Hazard management areas for alterations or additions to buildings.	An alteration or addition to a building must: (a) Be located on the lot so as to be provided with a HMA which: (i) Has the separation distances required for the BAL assessed for the construction of the existing building; or (ii) In the case of a building without an existing BAL assessment, is no smaller than the separation distances required for BAL 29; and (b) Have an HMA established in accordance with a certified bushfire hazard management plan.		
D.	Hazard management areas for new buildings and additions and alterations to buildings classified as an accommodation building BCA Class 1, BCA Class 2, or BCA Class 3, other than communal residence for persons with a disability, a respite centre or a residential aged care facility or similar.	A new building or an alteration or addition must: (a) be located on the lot so as to be provided with HMAs no smaller than the separation distances required for BAL 12.5; and (b) have a HMA established in accordance with a certified bushfire hazard management plan.		
E.	Hazard management areas for new buildings and additions and alterations to existing buildings classified as vulnerable use as defined in the relevant planning scheme.	A new building or an addition or alteration including change of use must: (a) be located on the lot so as to be provided with HMAs no smaller than the separation distances required for BAL 12.5; and (b) have a HMA established in accordance with a certified bushfire hazard management plan.		
F.	Hazard management areas for new buildings or additions and alterations to buildings associated with the use, handling, generation or storage of a hazardous chemical or explosive.	A new building or an alteration or addition, including change of use, for a building determined as a hazardous use must: (a) Be located on the lot so as to be provided with a HMA no smaller than the required separation distances for the BAL determined in the certified bushfire hazard management plan; and (b) Have a HMA established in accordance with a certified bushfire hazard management plan.		

Table 5 - Requirements for Emergency Planning

BUILDING ACT BUSHFIRE HAZARD AREAS 21 / 23

CLASSIC

SHEET TITLE:

	Column 1	Column 2	
	ELEMENT	REQUIREMENT	
A.	Bushfire emergency plans	An emergency plan must be developed for the site which is: (a) Consistent with TFS Bushfire Emergency Planning Guidelines; and (b) Approved by TFS or a person accredited by the TFS.	

HOUSE CODE

FACADE CODE:

SHEET No.: SCALES:

H-WATRVT20SA

F-WATRVT20CLASA

SUBJECT TO NCC 2022 (1 MAY 2023)

WATERPROOFING & PLUMBING

PLAN ACCEPTAI	NCE BY OWNER
SIGNATURE:	DATE:
SIGNATURE:	DATE:
PLEASE NOTE THAT VARIATION	NS WILL NOT BE ACCEPTED
AFTER THIS PLAN ACCEPT	ANCE HAS BEEN SIGNED

REFER TO SHEET 1 (COVER SHEET) FOR BAL-12.5 BUSHFIRE REQUIREMENTS SEE SHEET 1 (COVER SHEET) FOR DETAILS

3 PRELIM PLANS - INITIAL ISSUE

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COUNCIL:

WEST TAMAR



ALL BUILDING INFORMATION REGARDING:

SUSTAINABILITY REQUIREMENTS

GENERAL BUILDING INFORMATION

SPECIFICATION HOUSE DESIGN REVISION DRAWN KPH 23/10/2025 HYEONJIN PAK & HYUNMIN JANG NEXTGEN **RIVERTON 23** DRAFT SALES PLAN - CP MLG 24/10/2025 ADDRESS: FACADE DESIGN: 2 PLANS UPDATE

KPH 06/11/2025 16 THORNE AVENUE, LEGANA TAS 7277

LOT / SECTION / CT:

99 / - / 187077

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AS3959 (2018)

All specifications are per AS3959 (2018) and Wilson Homes request. Other materials and options may be available, refer to AS3959 for full list of compliant materials.

5.1 GENERAL

A building assessed in Section 2 as being BAL -12.5 shall comply with Section 3 and Clauses 5.2 to 5.8.

Any element of construction or system that satisfies the test criteria of AS 1530.8.1 may be used in lieu of the applicable requirements contained in Clauses 5.2 to 5.8 (see Clause 3.8).

NOTE: BAL -12.5 is primarily concerned with protection from ember attack, and radiant heat up to and including $29kW/m^2$ where the site is less than 100 m from the source of the bushfire attack.

5.2 SUBFLOOR SUPPORTS

This Standard does not provide construction requirements fo

subfloor supports where the subfloor space is enclosed with (a) a wall that complies with Clause 5.4; OR
(b) a mesh or perforated sheet with a maxium aperture of
2mm, made of corrosion resistant steel, bronze or aluminium; OR (c) a combination of Items (a) and (b)

NOTE: This requirement applies to the subject building only and not to verandas, decks, steps, ramps and landings (see Clause

C5.2 Combustile materials stored in the subfloor space may be ignited by embers and cause and impact to the building.

5.3 FLOORS

5.3.1 GENERAL

This Standard does not provide construction requirement concrete slabs on the ground

5.3.2 ELEVATED FLOORS

5.3.2.1 ENCLOSED SUBFLOOR SPACE

This standard does not provide consturction requirements for elevated floors, including bearers and joists and flooring, where the subfloor space is enclosed with

(a) a wall that complies with Clause 5.4; OR
(b) a mesh perforated sheet with a maximum aperture of 2mm,
made of corrosion resistant steel, bronze or aluminium; OR
(c) a combination of Items (a) and (b) above.

5.3.2.2 UNENCLOSED SUBFLOOR SPACE

Where the subfloor space is unenclosed, the bearers, joists and flooring, less than 400mm above finished ground level, shall be one of the following
(a) Materials that comply with the following:

(i) Bearers and joists shall be (A) non-combustible; OR
(B) bushfire-resisting timber (see Appendix F); OR
(C) a combination of Items (A) and (B) above.

(ii) Flooring shall be -

(ii) Flooring shall be (A) non-combustible; OR
(B) bushfire-resisting timber (see Appendix F); OR
(C) timber (other than bushfire-resisting timber),
particleboard or plywood flooring where the underside is lined with
sarking-type material or mineral wool insulation; OR
(D) a combination of any Items (A), (B) or (C) above.

(b) A system complying with AS1530.8.1

This standard does not provide construction requirements for elements of elevated floors, including bearers, joists and flooring, if the underside of the element is 400mm or more above finished ground level.

5.4.1 WALLS

The exposed components of an external wall that is less than 400 mm from the ground or less than 400 mm above decks, carport roofs, awnings and similar fittings having an angle of less than 18 degrees to the horizontal and extending more than 110 mm in width from the wall (see Figure D3, Appendix D) shall be:

NOTE: Examples include, but are not limited to, the following (with a minimum of 90 mm inthickness):

(i) Full masonry or masonry veneer walls with an outer leaf of clay, concrete, calcium silicate or natural stone.

(ii) Precast or in situ walls of concrete or aerated concrete

(iii) Earth wall including mud brick. OR

(b) Timber logs of a species with a density of 680kg/m³ or greater at a 12 percent moisture content; of a minimum nominal overall thickness of 90mm and a minimum thickness of 70mm (see Clause 3.11); and

gauge planed. OR
(c) Cladding that is fixed externally to a timber-framed or a steel-framed wall that is sarked on the outside of the frame and is (i) non-combustible material; OR
(ii) fibre cement a minimum of 6mm in thickness; OR

(iii) bushfire-resisting timber (see Appendix F); OR
(iv) a timber species as specified in Paragraph E1, Appendix E; pr
(v) a combination of any of Items (i), (iii), (iii) or (iv) above. OR
(d) A combination of any items (a), (b) or (c) above.

5.4.2 JOINTS

All ioints in the external surface material of walls shall be covered sealed, overlapped, backed or butt-jointed.

BAL-12.5 BUSHFIRE REQUIREMENTS SEE SHEET 1 (COVER SHEET) FOR DETAILS

5.4.3 VENTS AND WEEPHOLES

Except for exclusions provided in Clause 3.6, vents and weepholes in external walls shall be screened with a mesh made of corrosion-resistant steel, bronze

5.5.1 BUSHFIRE SHUTTERS

Where fitted, bushfire shutters shall comply with Clause 3.7 and be made from -(a) non-combustible material; OR
(b) a timber species as specified in Paragraph E1, Appendix E; OR
(c) bushfire-resisting timber (see Appendix F); OR
(d) a combination of Items (a), (b) and (c) above.

5.5.2 SCREENS FOR WINDOWS AND DOORS

Where fitted, screens for windows and doors shall have a mesh or perforated sheet made of corrosion-resistant steel, bronze or aluminium.

The frame supporting the mesh or perforated sheet shall be made from (a) metal; OR

(b) bushfire-resisting timber (see Appendix F).
(c) a timber species as specified in Paragraph E2, Appendix E.

5.5.3 WINDOWS AND SIDELIGHTS

(a) be completely protected by a bushfire shutter that complies with Clause 3.7 and clause 5.5.1; OR

(b) Be completely protected externally by screens that conform with Clause 3.6

and Clause 5.5.2. (c) Conform with the following:

(i) Frame material For window assemblies less than 400mm from the (I) Frame material For window assemblies less than 400mm from the ground or less than 400mm above decks, carport roofs, awnings and similar elements or fittings having and angle less than 18 degrees to the horizontal and extending more than 110mm in width from the window frame (see Figure D3, Appendix D), window frames and window joinery shall be made from:

(A) Bushfire-resisting timber (see Appendix F) OR

(B) A timber species as specified in Paragraph E2, Appendix F); OR

(D) Metal-reinforced uPVC. The reinforcing members shall be made uninium, stainless steel, or corrosion-resistant steel.

There are no specific restrictions on frame material for all other

windows.

(ii) Hardware There are no specific restrictions on hardware for windows.

(iii) Glazing Where glazing is less than 400mm from the grounf or less than 400mm above decks, carport roofs, awnings and similar elements or fittings having and angle less than 18 degrees to the horizontal and extending more than 110mm in width from the window frame (see Figure D3, Appendix D), this glazing shall be Grade A safety glass a minimum of 4mm in thickness or glass blocks with no restriction on glazing methods. NOTE: Where double-glazed assemblies are used above, the requirements apply to the external pane of the glazed assembly only. For all other glazing, annealed glass may be used in accordance with AS 1288.

(iv) Seals and weather strips There are no specific requirements for seals and weather strips at this BAI Level.

(iv) Seals and weather strips. There are no specific requirements for seals and weather strips at this BAL level.

(iv) Seals send weather strips at this BAL level.

(iv) Screens. The openable portions of windows shall be screened internally or externally with screens that conform with Clause 3.6 and Clause 5.5.2.

C5.5.3 For Clause 5.5.3(c), screening of the openable portions of all windows is required in all BAL's to prevent the entry of embers to the building when the

is required in all BAL's to prevent the entry or embods and fixed portions of some window is open. For Clause 5.5.3 (c)(v), screening of the openable and fixed portions of some windows is required to reduce the effects of radiant heat on some tpes of glass. If the screening is required to reduce the effects of radiant heat on glass, and has to be externally fixed.

For Clause 5.5.3 (c)(v), if the screening is required only to prevent the entry of embers, the screening may be fitted externally or internally.

5.5.4 DOORS SIDE-HUNG EXTERNAL DOORS (including French Doors, Panel Fold and Bi-fold Doors)

Side-hung external doors, including French doors, panel fold and bi-fold (a) Be protected by bushfire shutters that comply with Clause 3.7 and Clause 5.5.1.

(b) Be protected externally by screens that comply with Clause 3.6 and Clause 5.5.2.

OR
(c) conform with the following:
(i) Door panel material Materials shall be (A) non combustible; OR
(B) solid timber, laminated timber or reconstituted timber door, having a minimum thickness of 35mm for the first 400mm above the

the threshold; OR

(D) hollow core, solid timber, laminated timber or reconstituted
r protected externally by a screen that complies with Clause 5.5.2; OR
(E) for fully framed glazed door panels, the framing is made from
or bushfire resisting timber (see Appendix F), or a timber species as
fied in Paragraph E2, Appendix E or uPVC.

(A) Bushfire-resisting timber (see Appendix F). OR

(B) a timber species as specified in Paragraph E2 of Appendix E;

(C) Metal. OR (D) Metal-reinforced PVC-U. The reinforcing members shall be de from aluminium, stainless steel, or corrosion-resistant steel. (iii) Hardware There are no specific requirements for hardwarea at this

(iii) Hardware There are no specific requirements for hardwarea at this BAL level.

(iv) Glazing the glazing shall be Grade A safety glass a minimum of 4mm in thickness, or glass blocks with no restriction on glazing methods. NOTE: Where double glazed units are used the above requirements apply to the external face of the window assembly only.

(v) Seals and weather strips Weather strips, draft excluders or draft seals shall be installed.

(vi) Screens There are no specific requirements for hardwarea at this BAL level.

(vii) Doors shall be tight-fitting to the door frame and to an abutting door,

5.5.5 DOORS-SLIDING DOORS

Sliding doors shall:
(a) Be protected by bushfire shutters that comply with Clause 3.7 and Clause 5.5.1.

(b) Be protected externally by screens that comply with Clause 3.6 and Clause 5.5.2.

OR

OR

(c) conform with the following:

(i) Frame material The material for door frames, including fully framed glazed doors, shall be
(A) Bushfire-resisting timber (see Appendix F). OR

(B) a timber species as specified in Paragraph E2 of Appendix E; OR

(C) Metal. OR

(D) Metal-reinforced uPVC. The reinforcing members shall be made from aluminium, stainless steel, or corrosion-resistant steel.

(ii) Hardware There are no specific requirements for hardwarea at this BAL level.

(iii) Glazing Where doors incorporare glazing, the glazing shall be Grade A safety glass a minimum of 4mm in thickness,
(iv) Seals and weather strips There are no specific requirements for

(v) Screens There are no specific requirements for hardwarea at this BAL (vi) Sliding panels Sliding panels shall be tight-fitting in the frames.

5.5.6 DOORS-VEHICLE ACCESS DOORS

(GARAGE DOORS)

The following apply to vehicle access doors:
(a) The lower portion of a vehicle access door that is within 400mm of the ground when the door is closed (see Figure D4, Appendix D) shall be made from (i) non combustible material; OR
(ii) bushfire-resisting timber (see Appendix F); OR
(iii) fibre- cement sheet, a minimum of 6mm in thickness; OR
(iv) a timber species as specified in Paragraph E1, Appendix E; OR

E; OR (IV) a combination of any Items (i), (iii) or (iv) above. (b) All vehicle access doors doors shall be fitted with suitable weather strips, draught seals or brushes. Door assemblies fitted with guide tracks do not need edge gap protection. NOTES:

NOTES:

1 Refer to AS/NZS 4505 for door types.

2 Gaps of door edges or building elements should be protected as per Section 3.

C5.5.6(b) These guide tracks do not provide a direct passage for embers into the building.

(c) Vehicle access doors with ventilation slots shall be protected in accordance with Clause 3.6.

5.6.1 ROOFS - GENERAL

The following apply to all types of roofs and roofing systems:
(a) Roof tiles, roof sheets and roof-covering accessories shall be (b) The roof/wall junction shall be sealed, or otherwise protected in accordance with Clause 3.6.
(c) Roof ventilation openings, such as gable and roof vents, shall be fitted with ember guards made of non-combustible material or a mesh or perforated sheet conforming with Clause 3.6 and made of corrosion-resistant steel, bronze or aluminium.
(d) Only evaporative coolers manufactured in accordance with AS/NZS 60335.2.98 shall be used. Evaporative coolers with an internal damper to prevent the entry of embers into the roof space need to be screened externally. dance with Clause 3.6.

5.6.2 TILED ROOFS

Tiled roofs shall be fully sarked. The sarking shall (a) be located on top of the roof framing, except that the roof battens may be fixed above the sarking; (b) cover the entire roof area including ridges and hips; and (c) extend into gutters and valleys.

5.6.3 SHEET ROOFS

(a) be fully sarked in accordance with Clause 5.6.2, except that (b) have any gaps sealed at the fascia or wall line and at valleys, hips and ridges by (i) a mesh or perforated sheet that conforms with Clause 3.6 and that is

nade of corrosion-resistant steel, bronze or aluminium; or

(iii) other non-combustible material; or

(iv) a combination of any of Items (i), (ii) or (iii) above. C5.6.3 - Sarking is used as a secondary form of ember protection for the roof space to account for minor gaps that may develop in sheet

5.6.4 VERANDA, CARPORT AND AWNING ROOFS

The following apply to veranda, carport and awning roofs: (a) A veranda, carport or awning roof forming part of the main roof space [see Figure D1(a), Appendix D] shall meet all the rements for the main roof, as specified in Clauses 5.6.1,

(b) A veranda, carport or awning roof separated from the main (v) A veranus, capt of awiming tool separate norm tier main roof space by an external wall [see Figures D1(b) and D1(c), Appendix D] complying with Clause 5.4 shall have a non-combustible roof covering, except where the roof covering is a translucent or transparent material.

NOTE: There is no requirement to line the inderside of a veranda carport or awning roof that is separated from the main roof space

5.6.5 ROOF PENETRATIONS

The following apply to roof penetrations:
(a) Roof penetrations, including roof lights, roof ventilators, roof-mounted evaporative cooling units, aerials, vent pipes and supports for solar collectors shall be sealed. The material used to seal the penetration shall be non-combustible.
(b) Openings in vented roof lights, roof ventilators or vent pipes

shall conform with Clause 3.6 and be made of corrosion-resistant steel, bronze or aluminiun

This requirement does not apply to a room sealed gas appliance. NOTE: A gas appliance designed such that air for combustion dose not enter from, or combustion products enter into, the room which the appliance is located. In the case of gas appliance flues, ember guards shall not be

NOTE: AS/NZS 5601 contains requirements for gas appliance flue systems and cowls. Advice can be obtained from manufacturers and State and Territory gas technical regulators. (c) All overhead glazing shall be Grade A safety glass complying

(d) Glazed elements in roof lights and skylights may be of polymer provided a Grade A safety glass diffuser, complying with AS 1288, is installed under the glazing. Where glazing is an insulating glazing unit (IGU), Grade A toughened safety glass of minimum 4 mm in thickness shall be used in the outer pane of the IGU.

(e) Flashing elements of tubular skylights may be of a fire-retardan material, provided the roof integrity is maintained by an underflashing of a material having a flammability index not exceeding

five..

(f) Evaporative cooling units shall be fitted with non-combustible butterfly closers as close as practicable to the roof level, or the unit shall be fitted with non-combustible covers with a mesh or perforated sheet with a maximum aperture of 2mm, made of corrosion-resistant steel, bronze or aluminium.

(g) Vent pipes made from PVC are permitted.

(h) Eaves lighting shall be adequately sealed and not compromise the performance of the element.

5.6.6 EAVES LININGS, FASCIAS AND GABLES

The following apply to eaves linings, fascias and gables:
(a) Gables shall comply with Clause 5.4.
(b) Eaves penetrations shall be protected the same as for roof penetrations, as specified in Clause 5.6.5.

(c) Eaves ventilation openings shall be fitted with ember guards in accordance with Clause 3.6 and made of corrosion-resistant steel, bronze or aluminium Joints in eaves linings, fascias and gables may be sealed with

plastic joining strips or timber storm moulds. This standard does not provide construction requirements for fascias, bargeboards and eaves linings.

5.6.7 GUTTERS AND DOWNPIPES

This Standard does not provide material requirements for downpipe Inis Standard uodes not provide inaterial requirements to cowinpipes if installed, gutter and valley leaf guards shall be non-combustible. With the exception of box gutters, gutters shall be metal or PVC-U. Box gutters shall be non-combustible and flashed at the junction with the roof with noncombustible material.

5.7.1 VERANDAS, DECKS, STEPS AND LANDINGS - GENERAL

Decking may be spaced.

There is no requirement to enclose the subfloor spaces of verandas, decks, steps, ramps or landings.

C5.7.7 - Spaced decking is nominally spaced at 3 mm (in accordance with standard industry practice); however, due to the nature of timber decking with seasonal changes in moisture content, that spacing may range from 0 - 5 mm during service. It should be noted that recent research studies have shown that gaps at 5 mm spacing afford opportunity for embers to become lodged in between timbers, which may contribute to a fire. Larger gap spacings of 10 mm may preclude this from happening but such a spacing regime may not be practical for a timber deck.

5.7.2 ENCLOSED SUBFLOOR SPACES OF VERANDAS, DECKS, STEPS, RAMPS AND LANDINGS

5.7.2.1 Materials to enclose a subfloor space

This standard does not provide construction requirements for the materials used to enclose a subfloor space except where those materials are less than 400mm from the ground. Where the materials used to enclose a subfloor space are less than 400mm from the ground, they shall conform with Clause 5.4.

This Standard does not provide construction requirements for support posts, columns, stumps, stringers, piers and poles.

This Standard does not provide construction requirements for the framing of verandas, decks, ramps or landings (i.e., bearers and joists).

5.7.2.4 Decking, stair treads and the trafficable surfaces of ramps and landings

This standard does not provide construction requirements for decking, stair treds and the trafficable surfaces and landings that are more than 300mm from a glazed element.

Decking, stair treads and the trafficable surfaces of ramps and landings less than 300mm (measured horizontally at deck level) from glazed elements that are less than 400mm (measured vertically) from the surface of the deck (see Figure D2, Appendix D) shall be made from
(a) of non-combustible material; or

(b) of bushfire-resisting timber (see Appendix F); or (c) a timber species as specified in Paragraph E1, Appendix E; or (e) a combination of Items (a), (b), (c) or (d).

5.7.3 UNENCLOSED SUBFLOOR SPACES OF VERANDAS.

DECKS, STEPS, RAMPS AND LANDINGS

This Standard does not provide construction columns, stumps, stringers, piers and poles.

This Standard does not provide construction requirements for the framing of verandas, decks, ramps or landings (i.e., bearers and joists). 5.7.3.3 Decking, stair treads and the trafficable surfaces of ramps and landings

This Standard does not provide construction requirements for deshing, stair treds and the trafficable surfaces of ramps and landings that are more than 300mm from a glazed element.

Decking, stair treads and the trafficable surfaces of ramps and landings less than 300mm (measured horizontally at deck level) from glazed elements that are less than 400mm (measured vertically) from the surface of the deck (see Figure D2, Appendix D) shall be made from
(a) of non-combustible material; or

(b) of bushfire-resisting timber (see Appendix F); or (c) a timber species as specified in Paragraph E1, Appendix E; or

(e) a combination of any of Items (a), (b), (c) or (d). 5.7.4 BALUSTRADES, HANDRAILS OR OTHER BARRIERS

This Standard does not provide construction requirements for balustrades,

5.7.5 VERANDA POSTS

d) uPVC: or

5./.5 VEKANDA PUDIO

Verandah Posts
(a) Shall be timber mounted on galvanised mounted shoes or stirrups with a clearance of no less than 75mm above adjacent ground level; or (b) if less than 40mm (measured vertically) from the surface of the deck or ground (see Fig D2, Appendix D) shall be made from
(i) non-combustible material; or

(ii) bushfire-resisting timber (see Appendix F); or

(iii) a timbers species as specified in Paragraph E1, Appendix E; or

(iv) a combination of any of items (a) or (b).

5.8 WATER AND GAS SUPPLY PIPES

Above-ground, exposed water and gas supply pipes shall be metal

HOUSE CODE

FACADE CODE:

H-WATRVT20SA

SUBJECT TO NCC 2022 (1 MAY 2023)

WATERPROOFING & PLUMBING

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KPH 06/11/2025 16 THORNE AVENUE, LEGANA TAS 7277 COUNCIL .

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CLASSIC SHEET TITLE: BAL 12.5 NOTES

RIVERTON 23

FACADE DESIGN:

F-WATRVT20CLASA SHEET No.: | SCALES: 22 / 23

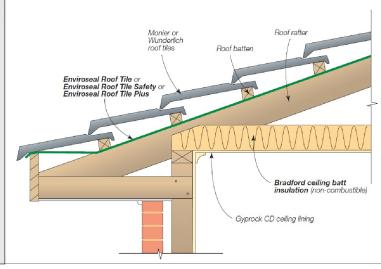
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- Install EnviroSeal roof tile sarking on top of the roof framing and below the roof battens.
- For further fixing details contact CSR technical support.



Application	Product
Sarking	EnviroSeal [™] Resiwrap
Foil faced insulation blanket	Bradford Anticon™
Gap seal	Bradford Fireseal BAL 12.5 - 40 Blanket

Figure 5.2.1. Fascia Detail - Metal Roof (BAL12.5-40)

- Install EnviroSeal Resiwrap to the entire roof area over the top of the battens.
- · Immediately above the fascia install BAL12.5 - 40 Blanket extending up the roof and over the first batten. Compress with the roof sheeting.
- For further fixing details contact CSR technical support.

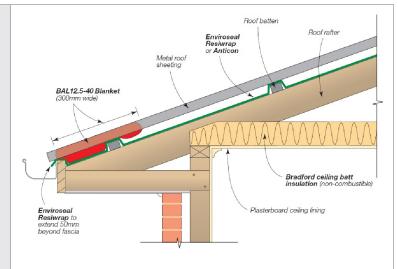


Figure 5.2.2. Valley Detail - Steel Roof (BAL-12.5 - BAL-40)

 Install EnviroSeal Resiwrap to the entire roof area over the top of the battens.

BAL12.5 - 40 Blanket to be laid over the top of the sarking extending into the outer edge of the valley gutter. Compress with roof sheeting.

 For further fixing details contact CSR technical support.

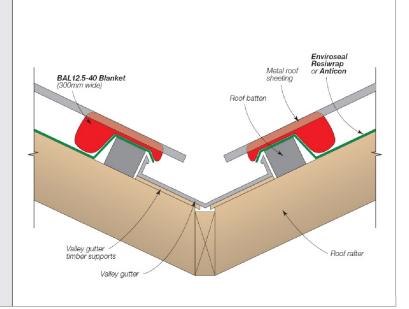


Figure 5.2.3. Barge **Detail - Steel Roof** (BAL-12.5 - BAL-40)

- Install EnviroSeal Resiwrap to the entire roof area over the top of the battens.
- At barge install BAL12.5 - 40 Blanket and compress with roof sheeting.
- For further fixing details contact CSR technical support.

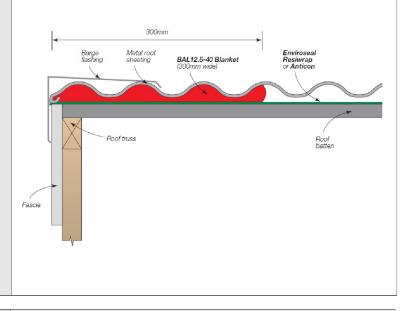
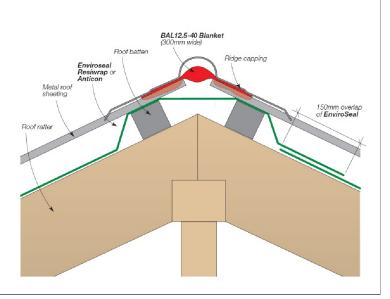


Figure 5.2.4. Hip/Ridge Detail - Steel Roof (BAL-12.5 - BAL-40)

- Install EnviroSeal Resiwrap to the entire roof area over the top of the battens.
- At the ridge/hip lay BAL12.5 - 40 Blanket over the gap between the roof sheets and compress with the ridge capping to the roof profile.
- For further fixing details contact CSR technical support.

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BAL-12.5 BUSHFIRE REQUIREMENTS SEE SHEET 1 (COVER SHEET) FOR DETAILS

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FACADE DESIGN: CLASSIC SHEET TITLE: BAL 12.5 - BAL 40 ROOF DETAILS

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