

PLANNING APPLICATION FORM

Section 57 & 58

OFFICE USE
ONLY

Application Number PA2025381

Assess No: A13824

PID No: 9351851

Applicant Name:	Wilson Homes Tasmania Pty Ltd					
Applicant Contact Name						
Postal Address:						
Contact Phone:	Home		Work		Mobile	
Email Address:						

Planning Application Lodgement Checklist

The following documents have been submitted to support the consideration of this application:

1. A current copy of the property title text, folio plan and schedule of easements ☐
2. A completed application form including a detailed description of the proposal ☐
3. A complete plan set: ☐
 - a) Floor plans ☐
 - b) Elevations (from all orientations/sides and showing natural ground level and finished surface level) ☐
 - c) Site Plan showing: ☐
 - Orientation
 - All title boundaries
 - Location of buildings and structure (both existing and proposed)
 - Setbacks from all boundaries
 - Native vegetation to be removed
 - Onsite services, connections and drainage details (including sewer, water and stormwater)
 - Cut and/or Fill
 - Car parking and access details (including construction material of all trafficable areas)
 - Fence details
 - Contours
4. Other: ☐

*If submitting plans in over the counter please ensure they are A3.
All plans must be to scale.*

WEST TAMAR COUNCIL



Application Number: «Application Number»

APPLICANT DETAILS

Applicant Name: Wilson Homes Tasmania Pty Ltd

Note: Full name(s) of person(s) or company making the application and postal address for correspondence.

LAND DETAILS

Owner/Authority Name:
(as per certificate of title) HYUNMIN JANG and HYEONJIN PAK

Location / Address: C/- Wilson Homes Tasmania Pty Ltd

Title Reference:

Zone(s):

Existing Development/Use: 0

Existing Developed Area: 239.64 m²

Are any of the components in this Application seeking retrospective approval?
E.g. Use and/or development that has commenced without a Planning Permit.

YES ☐

NO ☒

(If yes please specify the relevant components):

DEVELOPMENT APPLICATION DETAILS

Proposed Use:

Residential: <input checked="" type="checkbox"/>	Visitor Accommodation: <input type="checkbox"/>	Commercial: <input type="checkbox"/>	Other: <input type="checkbox"/>
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Description of Use:

Development Type:

Building work: <input checked="" type="checkbox"/>	Demolition: <input type="checkbox"/>	Subdivision: <input type="checkbox"/>	Other: <input type="checkbox"/>
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Description of development:

New or Additional Area:

Estimated construction cost of the proposed development:

\$603,790

Building Materials:

Wall Type: Brick Veneer

Colour: TBC

Roof Type: Sheet Metal

Colour: TBC

Application Number: «Application Number»

VISITOR ACCOMMODATION

☐ N/A

Gross Floor Area to be used per lot:		Number of Bedrooms to be used:	
Number of Carparking Spaces:		Maximum Number of Visitors at a time:	

SUBDIVISION

☐ N/A

Subdivision creating additional lots ☐

Boundary adjustment with no additional lots created ☐

Number of Lots (existing) :		Number of Lots (proposed) :	
Description:			
If applying for a subdivision which creates a new road(s), please supply three proposed names for the road(s), in order of preference:			
1.			
2.			
3.			

COMMERCIAL, INDUSTRIAL OR OTHER NON-RESIDENTIAL DEVELOPMENT/USE

☐ N/A

Hours of Operation:	Monday / Friday:		To	
	Saturday:		To	
	Sunday:		To	

Existing Car Parking:	
Proposed Car Parking:	

Number of Employees: (Existing)	
Number of Employees: (Proposed)	

Type of Machinery installed:	
Details of trade waste and method of disposal:	

Application Number: «Application Number»

APPLICANT DECLARATION

Owner: As the owner of the land, I declare that the information contained in this application is a true and accurate representation of the proposal and I consent to this application being submitted and for Council Officers to conduct inspections as required for the proposal,

Owner_Name Name (print)	 Signed	 Date
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Applicant: As the applicant, I declare that I have notified the owner of my intention to make this application and that the information contained in this application is a true and accurate representation of the proposal,

(if not the owner)

Lutzia Brown Applicant_Name Name (print)	<i>Lutzia Brown</i> Signed	20/11/25 Date
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Please Note: If the application involves Crown Land you will need to provide a letter of consent and this form signed by the Minister, or a delegated officer of the Crown with a copy of the delegation.

Crown Consent (if required)	 Name (print)	 Signed	 Date
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Chief Executive Officer (if required)	 Name (print)	 Signed	 Date
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If the subject site is accessed via a right of way, the owner of the ROW must also be notified of the application.



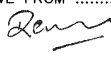
Right of Way Owner:

<i>Lutzia Brown</i>


As the applicant, I declare that I have notified the owner of the land encumbered by the Right Of Way, of my intent to lodge this application that will affect their land.

Lutzia Brown Name (print)	<i>Lutzia Brown</i> Signed	20/11/25 Date
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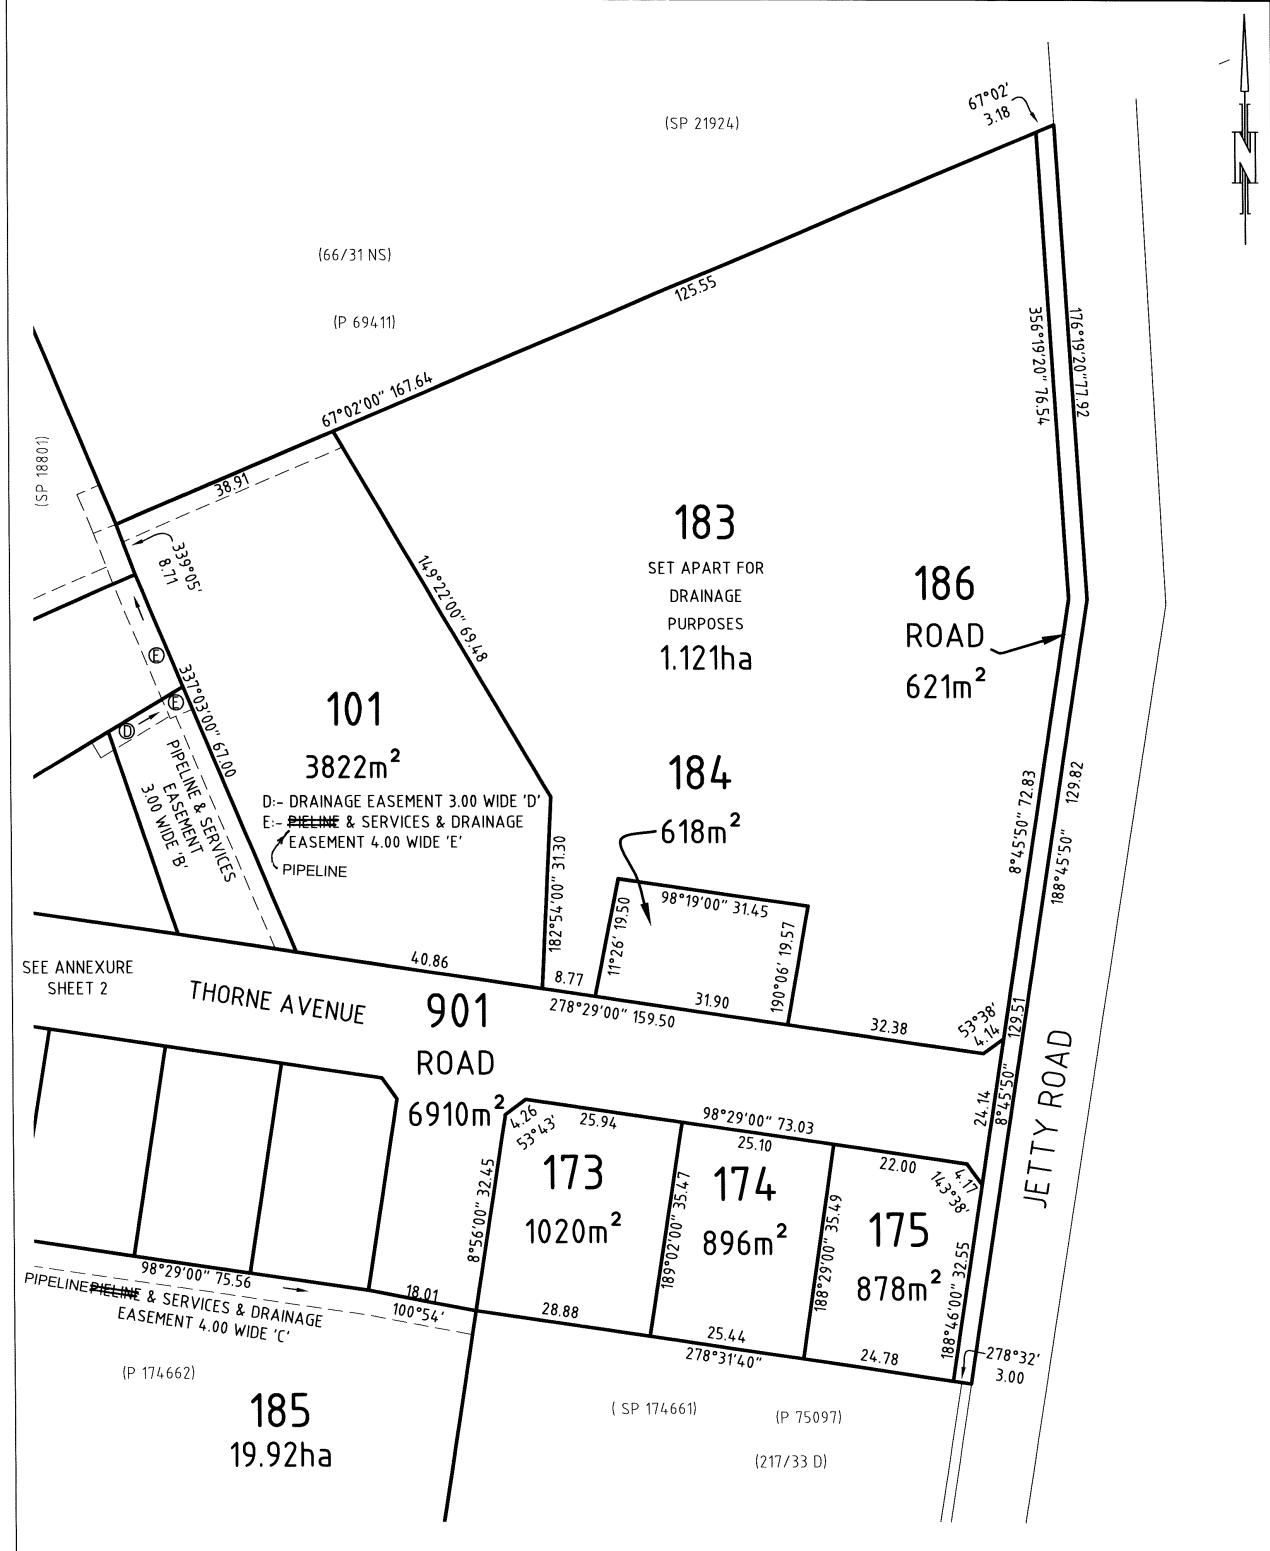
[illegible]

<p>PLAN OF SURVEY ANNEXURE SHEET</p> <p>SHEET 1 OF 3 SHEETS</p>	<p>OWNER: VOS CONSTRUCTION & JOINERY PTY LTD</p> <p>FOLIO REFERENCE: F.R.174662/1 & 174706/1</p> <p>SCALE 1:600 LENGTH IN METRES</p>	<p>Registered Number</p> <p>SP 187077</p>
<p>SIGNED FOR IDENTIFICATION PURPOSES</p> <p> Council Delegate</p> <p>27/11/24 Date</p>	<p>THIS ANNEXURE SHEET FORMS PART OF THE ATTACHED INDEX PLAN.</p> <p> Registered Land Surveyor</p> <p>08/04/2024 Date</p>	<p>APPROVED 13 DEC 2024</p> <p>EFFECTIVE FROM  Recorder of Titles</p>

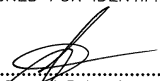

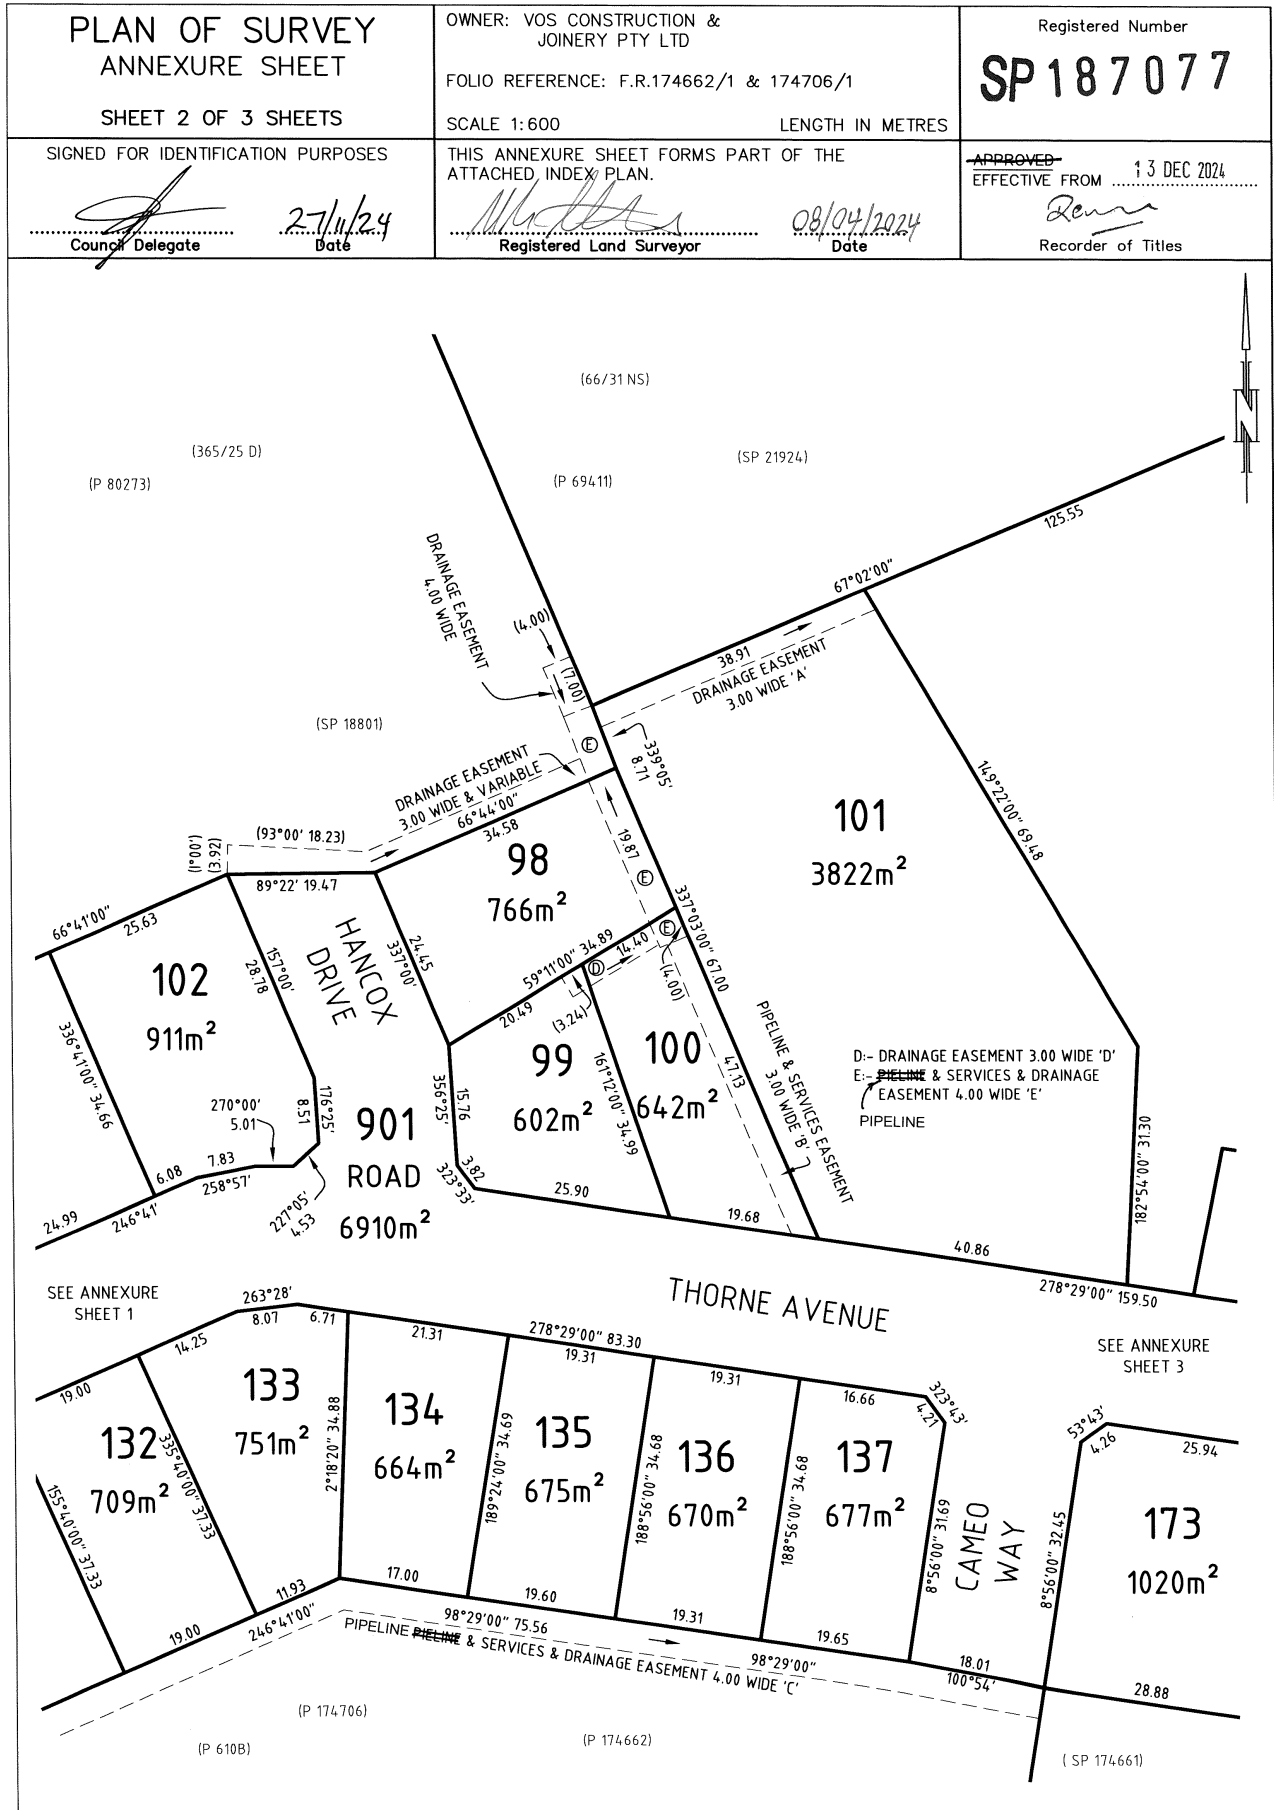

<p>PLAN OF SURVEY ANNEXURE SHEET</p> <p>SHEET 3 OF 3 SHEETS</p>	<p>OWNER: VOS CONSTRUCTION & JOINERY PTY LTD</p> <p>FOLIO REFERENCE: F.R.174662/1 & 174706/1</p> <p>SCALE 1:750 LENGTH IN METRES</p>	<p>Registered Number</p> <p>SP187077</p>
<p>SIGNED FOR IDENTIFICATION PURPOSES</p> <p><i>[Signature]</i> 27/11/24 Council Delegate Date</p>	<p>THIS ANNEXURE SHEET FORMS PART OF THE ATTACHED INDEX PLAN.</p> <p><i>[Signature]</i> 08/04/2024 Registered Land Surveyor Date</p>	<p>APPROVED EFFECTIVE FROM 13 DEC 2024</p> <p><i>[Signature]</i> Recorder of Titles</p>



SCHEDULE OF EASEMENTS NOTE: THE SCHEDULE MUST BE SIGNED BY THE OWNERS & MORTGAGEES OF THE LAND AFFECTED. SIGNATURES MUST BE ATTESTED.	Registered Number SP187077
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PAGE 1 OF 3 PAGE/S

EASEMENTS AND PROFITS

Each lot on the plan is together with:-

- (1) such rights of drainage over the drainage easements shown on the plan (if any) as may be necessary to drain the stormwater and other surplus water from such lot; and
(2) any easements or profits a prendre described hereunder.

Each lot on the plan is subject to:-

- (1) such rights of drainage over the drainage easements shown on the plan (if any) as passing through such lot as may be necessary to drain the stormwater and other surplus water from any other lot on the plan; and
(2) any easements or profits a prendre described hereunder.

The direction of the flow of water through the drainage easements shown on the plan is indicated by arrows.

Lots 98, 100 and 185 on the Plan are subject to a Right of Drainage ~~of the~~ in favour of the West Tamar Council over the land marked "PIPELINE & SERVICES & DRAINAGE EASEMENT 4.00 WIDE 'E'" shown passing through those lots on the Plan.

Lots 98, 100 and 185 on the Plan ("the Lot") are subject to a Pipeline and Services Easement (as defined herein) in gross in favour of TasWater over the land marked "PIPELINE & SERVICES & DRAINAGE EASEMENT 4.00 WIDE 'E'" shown on the Plan ("the Easement Land").

Lots 99 and 100 on the Plan are subject to a Right of Drainage in favour of the West Tamar Council over the land marked "DRAINAGE EASEMENT 3.00 WIDE 'D'" shown passing through those lots on the Plan.

Lot 100 ("the Lot") on the Plan is subject to a Pipeline and Services Easement (as defined herein) in gross in favour of TasWater over the land marked "PIPELINE & SERVICES EASEMENT 3.00 WIDE 'B'" shown on the Plan ("the Easement Land").

Lot 101 on the Plan is subject to a Right of Drainage ~~of the~~ in favour of the West Tamar Council over the land marked "DRAINAGE EASEMENT 3.00 WIDE 'A'" shown passing through Lot 101 on the Plan.

Lot 185 on the Plan is subject to a Right of Drainage ~~of the~~ in favour of the West Tamar Council over the land marked "DRAINAGE EASEMENT 3.00 WIDE & VARIABLE" shown passing through Lot 185 on the Plan.

Lot 185 on the Plan is subject to a Right of Drainage ~~of the~~ in favour of the West Tamar Council over the land marked "PIPELINE & SERVICES & DRAINAGE EASEMENT 4.00 WIDE 'C'" shown passing through Lot 185 on the Plan.

Lot 185 on the Plan ("the Lot") is subject to a Pipeline and Services Easement (as defined herein) in gross in favour of TasWater over the land marked "PIPELINE & SERVICES & DRAINAGE EASEMENT 4.00 WIDE 'C'" shown on the Plan ("the Easement Land").

Lot 185 on the Plan is subject to a Right of Drainage ~~of the~~ in favour of the West Tamar Council over the land marked "DRAINAGE EASEMENT 4.00 WIDE" shown passing through Lot 185 on the Plan.

(USE ANNEXURE PAGES FOR CONTINUATION)

SUBDIVIDER: Vos Construction & Joinery Pty Ltd FOLIO REF: Volume 174662 Folio 1 and Volume 174706 Folio 1 SOLICITOR & REFERENCE: Penny Sproal - 246482	PLAN SEALED BY: West Tamar Council DATE: 27/11/2024 PA2021064 REF NO. Council Delegate
NOTE: The Council Delegate must sign the Certificate for the purposes of identification.	

ANNEXURE TO SCHEDULE OF EASEMENTS PAGE 2 OF 3 PAGES	Registered Number SP. 187077
SUBDIVIDER: Vos Construction & Joinery Pty Ltd FOLIO REFERENCE: Volume 174662 Folio 1 and Volume 174706 Folio 1	

That part of each lot on the plan formerly comprised in Lot 1 on Plan 174662 is together with a right of carriage way over all the Roadways shown on Plan No. 610 other ~~than~~ the Roadway marked thereon as "Track from West Tamar Road to Homestead".

INTERPRETATION

In this Schedule of Easements:

"Pipeline Easement" means:

The full and free right and liberty to draw water through pipes now or to be installed as hereinafter appears within that portion of each Lot subject thereto marked pipeline easement on the plan and for that purpose to enter thereon and to lay in, under and upon the pipeline easement such pipe or pipes as shall from time to time be necessary for the purposes aforesaid and to draw water through such pipes and at all times to enter into and upon the pipeline easement for the purpose of maintaining any pumping system and inspecting, cleaning, maintaining, removing and renewing such pipes and to carry out all necessary work thereon causing as little damage as possible and making reasonable compensation for all damage done or caused thereby.

"Pipeline & Services Easement" means:

FIRSTLY, THE FULL AND FREE RIGHT AND LIBERTY for TasWater and its employees, contractors, agents and all other persons duly authorized by it, at all times to:

- (1) enter and remain upon the Easement Land with or without machinery, vehicles, plant and equipment
- (2) investigate, take soil, rock and other samples, survey, open and break up and excavate the Easement Land for any purpose or activity that TasWater is authorized to do or undertake
- (3) install, retain, operate, modify, relocate, maintain, inspect, cleanse, repair, remove and replace the Infrastructure
- (4) run and pass sewerage, water and electricity through and along the Infrastructure
- (5) do all works reasonably required in connection with such activities or as may be authorized or required by any law:
 - (a) without doing unnecessary damage to the Easement Land, and
 - (b) leaving the Easement Land in a clean and tidy condition.
- (6) if the Easement Land is not directly accessible from a highway, then for the purpose of undertaking any of the preceding activities TasWater may with or without employees, contractors, agents and any other persons authorized by it, and with or without machinery, vehicles, plant and equipment enter the Lot from the highway at any vehicle entry and cross the Lot to the Easement Land, and
- (7) use the Easement Land as a right of carriage way for the purpose of undertaking any of the preceding purposes on other land, TasWater reinstating any damage that it causes in doing so to any boundary fence of the Lot.

SECONDLY, the benefit of a covenant in gross for TasWater with the registered proprietor/s of the Easement Land and their successors and assigns not to erect any building, or place any structures, objects, vegetation, or remove any thing that supports, protects or covers any Infrastructure on or in the Easement Land, without the prior written consent of TasWater to the intent that the burden of the covenant may run with and bind the servient land and every part thereof and that the benefit thereof may be annexed to the easement herein described.

NOTE: Every annexed page must be signed by the parties to the dealing or where the party is a corporate body be signed by the persons who have attested the affixing of the seal of that body to the dealing.

ANNEXURE TO SCHEDULE OF EASEMENTS PAGE 3 OF 3 PAGES	Registered Number SP 187077
SUBDIVIDER: Vos Construction & Joinery Pty Ltd FOLIO REFERENCE: Volume 174662 Folio 1 and Volume 174706 Folio 1	

Interpretation:

"Infrastructure" means infrastructure owned on for which TasWater is responsible and includes but is not limited to:


- (a) Sewer pipes and water pipes and associated valves,
- (b) Telemetry and monitoring devices,
- (c) Inspection and access pits,
- (d) Electricity assets and other conducting media (excluding telemetry and monitoring devices),
- (e) Markers or signs indicating the location of the Easement Land or any other Infrastructure or any warnings or restrictions with respect to the Easement Land or any other Infrastructure,
- (f) Anything reasonably require to support, protect or cover any other Infrastructure,
- (g) Any other infrastructure whether of a similar nature or not to the preceding which is reasonably required for the piping of sewerage or water, or the running of electricity, through the Easement Land or monitoring or managing that activity, and
- (h) Where the context permits, any part of the Infrastructure.

"TasWater" means Tasmanian Water & Sewerage Corporation Pty Ltd (ACN 162 220 653), its successors and assigns.


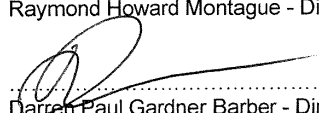
FENCING COVENANT

The Owner of each lot on the Plan covenants with the Vendor (Vos Construction & Joinery Pty Ltd) that the Vendor shall not be required to fence.

EXECUTED by VOS CONSTRUCTION & JOINERY PTY LTD (ACN 009 558 258) being the registered proprietor of the lands comprised in Folio of the Register Volume 174706 Folio 1 and Folio of the Register Volume 174662 Folio 1 in accordance with Section 127 of the Corporations Act 2001:

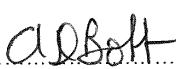
.....
Darren Roelf Vos - Director
.....
Adrian Donald Bott - Secretary

LEGANA ORCHARDS PTY LTD (ACN 009 520 852) as mortgagee under Mortgage No. E308992 hereby consents to this Schedule of Easements:


.....
Raymond Howard Montague - Director
.....
Darren Paul Gardner Barber - Director

NOTE: Every annexed page must be signed by the parties to the dealing or where the party is a corporate body be signed by the persons who have attested the affixing of the seal of that body to the dealing.

DA
TASMANIAN PLANNING SCHEME

SHEET INDEX

1	COVER SHEET
2	SITE PLAN
3	SOIL & WATER MANAGEMENT PLAN
4	GROUND FLOOR PLAN
5	ELEVATIONS / SECTION
6	ELEVATIONS
7	WINDOW & DOOR SCHEDULES
8	CALCULATIONS
9	DETAILS (FACE BRICKWORK)
10	ROOF DRAINAGE PLAN
11	FLOOR COVERINGS
12	KITCHEN DETAILS
13	BUTLER'S PANTRY DETAILS
14	BATHROOM DETAILS
15	ENSUITE DETAILS
16	POWDER ROOM DETAILS
17	LAUNDRY DETAILS
18	3D VIEWS
19	GENERAL NOTES
20	WET AREA & ENERGY EFFICIENCY NOTES
21	BUILDING ACT BUSHFIRE HAZARD AREAS
22	BAL 12.5 NOTES
23	BAL 12.5 - BAL 40 ROOF DETAILS

TOTAL FLOOR AREAS

MAIN DWELLING, GROUND FLOOR	
ALFRESCO	10.50
COURTYARD	6.90
GARAGE	39.43
LIVING	179.58
PORCH	3.23
	239.64 m²

HIGHLY REACTIVE /
PROBLEMATIC SOIL TYPE.
REFER TO HYDRAULICS PLANS
AND DETAILS PREPARED BY
GANDY AND ROBERTS

AS & NCC COMPLIANCE

- ALL CONSTRUCTION TO BE IN ACCORDANCE WITH NCC 2022 AND APPLICABLE AUSTRALIAN STANDARDS AT TIME OF APPROVAL.
- SLAB IN ACCORDANCE WITH AS 2870. REFER TO ENGINEERS DETAILS FOR ALL SLAB DETAILS.
 - BRICK CONTROL JOINTS PROVIDED IN ACCORDANCE WITH NCC 2022.
 - ALL STEEL FRAMING TO BE DESIGNED TO AS 4100-2020 OR AS/NZS 4600-2018.
 - INSULATION TO BE INSTALLED IN ACCORDANCE WITH NCC 2022 AND ALL APPLICABLE AUSTRALIAN STANDARDS.
 - TERMITE PROTECTION IN ACCORDANCE WITH AS 3660 AND NCC 2022.
 - GLAZING IN ACCORDANCE WITH AS 1288 AND NCC 2022.
 - SMOKE ALARMS IN ACCORDANCE WITH AS 3786 AND NCC 2022.
 - INTERNAL WATERPROOFING IN ACCORDANCE WITH NCC 2022 HOUSING PROVISIONS PART 10.2.
 - EXTERNAL WATERPROOFING IN ACCORDANCE WITH AS 3740 AND AS 4654.
 - WET AREA FLOORS TO FALL TO FLOOR WASTES AT MIN. 1:80 AND MAX. 1:50 GRADE (IF APPLICABLE).
 - CONDENSATION MANAGEMENT IN ACCORDANCE WITH NCC 2019.
 - BUILDING SEALING IN ACCORDANCE WITH NCC 2022.
 - SERVICES IN ACCORDANCE WITH NCC 2022.
 - EARTHWORKS IN ACCORDANCE WITH AS 3798-2007.
 - EXTERNAL WALL WRAP (SARKING) IN ACCORDANCE WITH NCC 2022 (IF APPLICABLE).
 - EXHAUST FANS DUCTED TO OUTSIDE AIR (IF APPLICABLE).

SITE SPECIFIC CONTROLS

CONTROL	DETAILS
ACID SULPHATE SOIL	NO
BIODIVERSITY	NO
BUILDING ENVELOPE	NO
BUSHFIRE	BAL-12.5
CLIMATE ZONE (NCC)	ZONE 7 - COOL TEMPERATE
DESIGN WIND CLASSIFICATION	N3 (NOT EXPOSED)
ESTATE/DEVELOPER GUIDELINES	NO
FLOOD OVERLAY	NO
HERITAGE	NO
LANDSLIP HAZARD	NO
MINIMUM FLOOR LEVEL	NO
NATURAL ASSET CODE	NO
NOISE ATTENUATION	NO
SALINE SOIL	YES
SHIELDING FACTOR	PS - PARTIAL SHIELDING
SITE CLASSIFICATION	P
SPECIFIC AREA PLAN OVERLAY	NO
TERRAIN CATEGORY	TC2
TOPOGRAPHIC CLASSIFICATION	T3
WATERWAY & COASTAL OVERLAY	NO
WIND REGION	A - NORMAL
WITHIN 1km CALM SALT WATER	NO
WITHIN 50km BREAKING SURF	NO
ZONING	GENERAL RESIDENTIAL

BUILDING CONTROLS & COMPLIANCE

CONTROL	REQUIRED	PROPOSED
SETBACKS		
FRONT	MIN. 4,500mm	2,605mm
GARAGE TO BOUNDARY	MIN. 5,500mm	9,759mm
SIDE A	MIN. 1,500mm	1,500mm
SIDE B	MIN. 3,000mm	3,081mm
REAR	MIN. 1,500mm	1,500mm
BULK & SCALE		
SITE AREA	602m²	
SITE COVERAGE	MAX. 50%	38.66%
BUILDING HEIGHT	MAX. 8,500mm	5,000mm
LANDSCAPE		
NO APPLICABLE CONTROLS		
EARTHWORKS		
CUT DEPTH	MAX. 2,000mm	826mm
FILL DEPTH	MAX. 1,000mm	666mm
ACCESS & AMENITY		
PARKING SPACES	MIN. 2 SPACES	2 SPACES
PRIVATE OPEN SPACE	MIN. 24m²	24m²

3D PERSPECTIVE



NOTE TO OWNER

THESE PLANS MAY FEATURE WORKS THAT ARE EXCLUDED FROM THE SCOPE OF WORKS WITH THE BUILDER, BUT THEY HAVE BEEN INCLUDED IN THESE DRAWINGS TO ASSIST IN THE OVERALL PLANNING AND ASSESSMENT OF THE BUILDING PROJECT. EXAMPLES OF SOME REGULARLY EXCLUDED WORKS INCLUDE DRIVEWAYS, RETAINING WALLS, SOLAR PANEL SPACING AND SITE DRAINAGE. PLEASE REFER TO YOUR SCOPE OF WORKS AND COLOUR SELECTIONS DOCUMENTATION FOR DETAILS OF INCLUDED WORKS. SOME DETAILS ARE INDICATIVE ONLY FOR EXAMPLE FLOORING, TILING, BRICKWORK AND CLADDING (EXPANSION JOINTS, ORIENTATION AND LAYOUT) AND ARE SUBJECT TO CHANGE.

LOCATION MAP



This Plan has been prepared prior to the receipt of one or more of the following documents:-
Certificate of Title inclusive of lot specific zoning, easement and covenant documents, BAL report and rating, approved subdivision plans providing crossover locations and service connection points, power and communications connection point information, Geotechnical Site Investigation, Contour Survey, Dial Before You Dig information, Planning Approval.

BUILDING INFORMATION

GROUND FLOOR TOP OF WALL HEIGHT(S) 2745mm	
NOTE: CEILING HEIGHT 45mm LOWER THAN TOP OF WALL	
ROOF PITCH (U.N.O.)	23.0°
ELECTRICITY SUPPLY	SINGLE PHASE
GAS SUPPLY	NONE
ROOF MATERIAL	SHEET METAL
ROOF COLOUR	N/A
WALL MATERIAL	BRICK VENEER
SLAB CLASSIFICATION	TBC

INSULATION

ROOF	MIN. 60mm FOIL FACED BLANKET UNDER ROOFING
CEILING	R4.1 BATTS (EXCL. GARAGE, ALFRESCO & PATIO)
EXT. WALLS	R2.0 BATTS (EXCL. GARAGE) WALL WRAP TO ENTIRE HOUSE
INT. WALLS	R2.0 BATTS ADJACENT TO GARAGE AND AS PER PLANN)
FLOOR	BIAX SLAB R0.60

NCC 2022 LIVABLE HOUSING COMPLIANCE

ACCESSIBLE SANITARY COMPARTMENT: PWD
ACCESSIBLE SHOWER LOCATION: BATH

GENERAL NOTES:

- THRESHOLD OF ACCESSIBLE SHOWER ENTRY TO BE MAX. 5MM
- 1 EXTERIOR DOOR NOMINATED AS 870 OR GREATER TO ACHIEVE MIN 820MM CLEAR OPENING
- REFER TO APPLICABLE WET AREA PLANS AND INTERIOR ELEVATIONS OR LOCATIONS OF REQUIRED WALL REINFORCEMENT FOR FUTURE GRAB RAIL INSTALLATION.

THE OWNERS ACKNOWLEDGE THAT THESE CONTRACT PLANS MAY NOT REFLECT ALL THE SELECTIONS THAT HAVE BEEN MADE OR CHANGES REQUESTED. THE OWNERS AGREE THAT FOLLOWING THE COLOUR SELECTIONS VARIATION OR UPDATING OF PLANS, THEY WILL BE PROVIDED WITH CONSTRUCTION PLANS FOR SIGNATURE PRIOR TO COMMENCEMENT OF CONSTRUCTION.

SIGNATURE:

DATE:

SUBJECT TO NCC 2022
(1 MAY 2023)
WATERPROOFING & PLUMBING

PLAN ACCEPTANCE BY OWNER

SIGNATURE: DATE:

SIGNATURE: DATE:

PLEASE NOTE THAT VARIATIONS WILL NOT BE ACCEPTED AFTER THIS PLAN ACCEPTANCE HAS BEEN SIGNED

PRELIMINARY PLAN SET

3	PRELIMINARY PLAN SET - INITIAL ISSUE	ALL	2025.11.06	KPH	-
No.	AMENDMENT	SHEET	DATE	DRAWN	CHECK

© 2025 WILSON HOMES PTY LTD (ABN 96 126 636 897). THIS DRAWING IS AN ORIGINAL ARTISTIC WORK WITHIN THE MEANING OF THE COPYRIGHT ACT 1968 (CTH). WILSON HOMES PTY LTD IS THE OWNER OF COPYRIGHT IN THIS DRAWING. YOU HEREBY AGREE AND UNDERTAKE THAT YOU WILL NOT IN ANY WAY REPRODUCE, COPY, MODIFY, USE OR TAKE ADVANTAGE OF THE DRAWING TO BUILD A HOUSE BASED ON THIS PLAN (WHETHER IN WHOLE OR IN PART) WITHOUT THE PRIOR WRITTEN CONSENT OF WILSON HOMES PTY LTD.



SPECIFICATION: NEXTGEN	REVISION	DRAWN	CLIENT:	HOUSE DESIGN:	HOUSE CODE:	DO NOT SCALE DRAWINGS. USE FIGURED DIMENSIONS ONLY. CHECK AND VERIFY DIMENSIONS AND LEVELS PRIOR TO THE COMMENCEMENT OF ANY WORK. ALL DISCREPANCIES TO BE REPORTED TO THE DRAFTING OFFICE.
COPYRIGHT: © 2025	1 DRAFT SALES PLAN - CP	KPH 23/10/2025	HYEONJIN PAK & HYUNMIN JANG	RIVERTON 23	H-WATRV T20SA	
	2 PLANS UPDATE	MLG 24/10/2025	ADDRESS: 16 THORNE AVENUE, LEGANA TAS 7277	FACADE DESIGN: CLASSIC	FACADE CODE: F-WATRV T20CLASA	
	3 PRELIM PLANS - INITIAL ISSUE	KPH 06/11/2025	LOT / SECTION / CT: 99 / - / 187077	COUNCIL: WEST TAMAR	SHEET TITLE: COVER SHEET	
					SHEET No.: 1 / 23	SCALES: 1:100
						714497

REFER TO SHEET 1 (COVER SHEET) FOR ALL BUILDING INFORMATION REGARDING:

- SUSTAINABILITY REQUIREMENTS
- SITE CLASSIFICATION
- GENERAL BUILDING INFORMATION



APPROX. CUT/FILL		
CUT	53.48m³	120.33t
FILL	54.65m³	122.96t
DIFFERENCE	1.17m³	2.63t
EVEN CUT & FILL		

LOT SIZE: 801m²
HOUSE (COVERED AREA): 249.79m²
SITE COVERAGE: 31.18%

DRY STACK WALLS <1m HIGH:
ISLAND BLOCK & PAVING FREESTONE
ECO RETAINING WALL INSTALLATION TO
MANUFACTURER'S SPECIFICATION AND
DETAILS

BAL-12.5 BUSHFIRE REQUIREMENTS
SEE SHEET 1 (COVER SHEET) FOR DETAILS

BAL - 12.5 HAZARD MANAGEMENT
AREA (ENTIRE LOT)

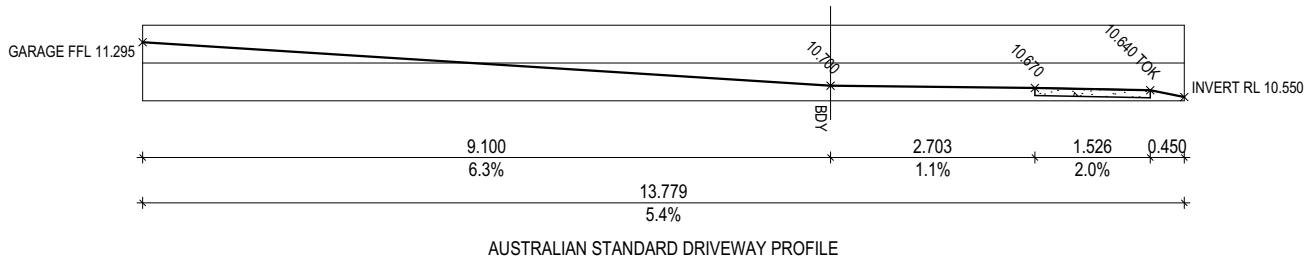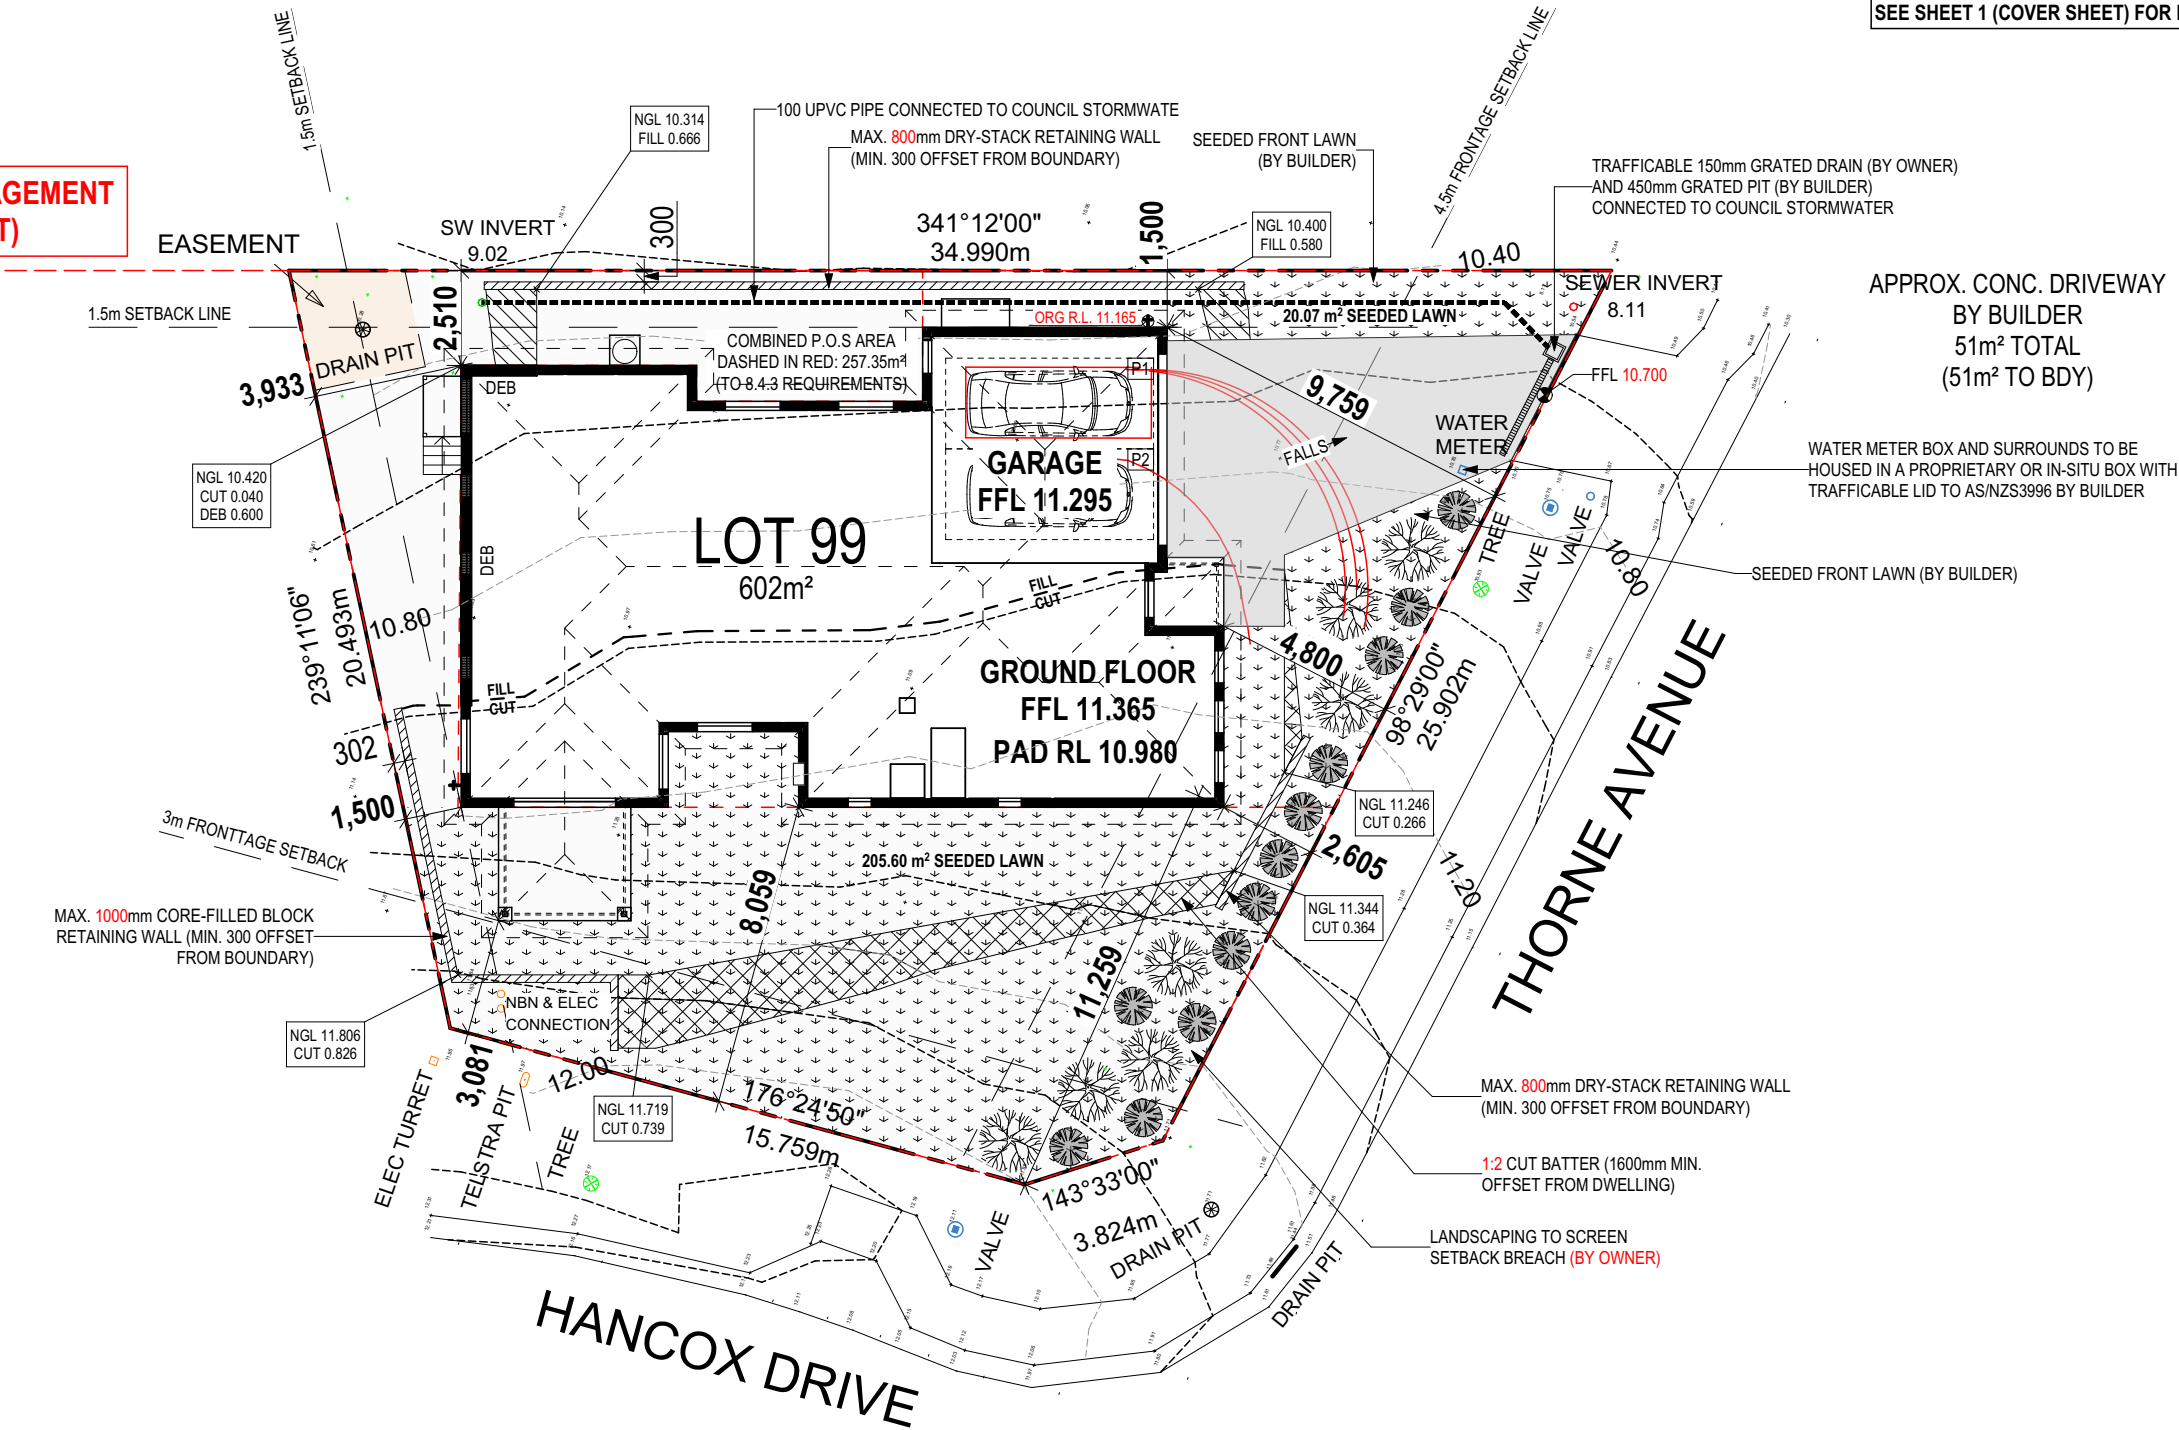

SUBJECT TO NCC 2022
(1 MAY 2023)
WATERPROOFING & PLUMBING

PLAN ACCEPTANCE BY OWNER

SIGNATURE: DATE:

SIGNATURE: DATE:

PLEASE NOTE THAT VARIATIONS WILL NOT BE ACCEPTED
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NEXTGEN		1	DRAFT SALES PLAN - CP	KPH	23/10/2025	HYEONJIN PAK & HYUNMIN JANG		RIVERTON 23		H-WATRV20SA		
COPYRIGHT:		2	PLANS UPDATE	MLG	24/10/2025	ADDRESS:		FACADE DESIGN:		FACADE CODE:		
© 2025		3	PRELIM PLANS - INITIAL ISSUE	KPH	06/11/2025	16 THORNE AVENUE, LEGANA TAS 7277		CLASSIC		F-WATRV20CLASA		
						LOT / SECTION / CT:		SHEET TITLE:		SHEET No.:		714497
						99 / - / 187077		COUNCIL:		2 / 23		
						WEST TAMAR		SITE PLAN		1:200		


ALL VEGETATION OUTSIDE THE BUILDING ZONE WILL BE MAINTAINED.

OWNER TO STABILISE THE SITE ON COMPLETION OF THE BUILD WITH TURF LAWNS, GRASS SEEDS, NATIVE GROUND COVERS AND/ OR MULCH SPREAD TO A DEPTH OF 75-100mm




THE FOLLOWING IS A STANDARD APPROACH. SEDIMENT AND EROSION CONTROL MEASURES WILL BE REVIEWED PRIOR TO COMMENCING WORK AND INSTALLED BASED ON THE OUTCOME OF THAT REVIEW.

- NOTES:
1. ALL EROSION AND SEDIMENT CONTROL STRUCTURES TO BE INSPECTED EACH WORKING DAY AND MAINTAINED IN GOOD WORKING ORDER.
 2. ALL GROUND COVER VEGETATION OUTSIDE THE IMMEDIATE BUILDING AREA TO BE PRESERVED DURING THE BUILDING PHASE.
 3. ALL EROSION AND SEDIMENT CONROL MEASURES TO BE INSTALLED PRIOR TO COMMENCEMENT OF MAJOR EARTHWORKS.
 4. STOCKPILES OF CLAYEY MATERIAL TO BE COVERED WITH AN IMPERVIOUS SHEET.
 5. ROOF WATER DOWNPIPES TO BE CONNECTED TO THE PERMANENT UNDERGROUND STORMWATER DRAINAGE SYSTEM AS SOON AS PRACTICAL AFTER THE ROOF IS LAID.

6. DIVERSION DRAINS ARE TO BE CONNECTED TO A LEAGAL DISCHARGE POINT (COUNCIL STORMWATER SYSTEM, WATERCOURSE OR ROAD DRAIN).
7. SEDIMENT RETENTION TRAPS INSTALLED AROUND THE INLETS TO THE STORMWATER SYSTEM TO PREVENT SEDIMENT & OTHER DEBRIS BLOCKING THE DRAINS.

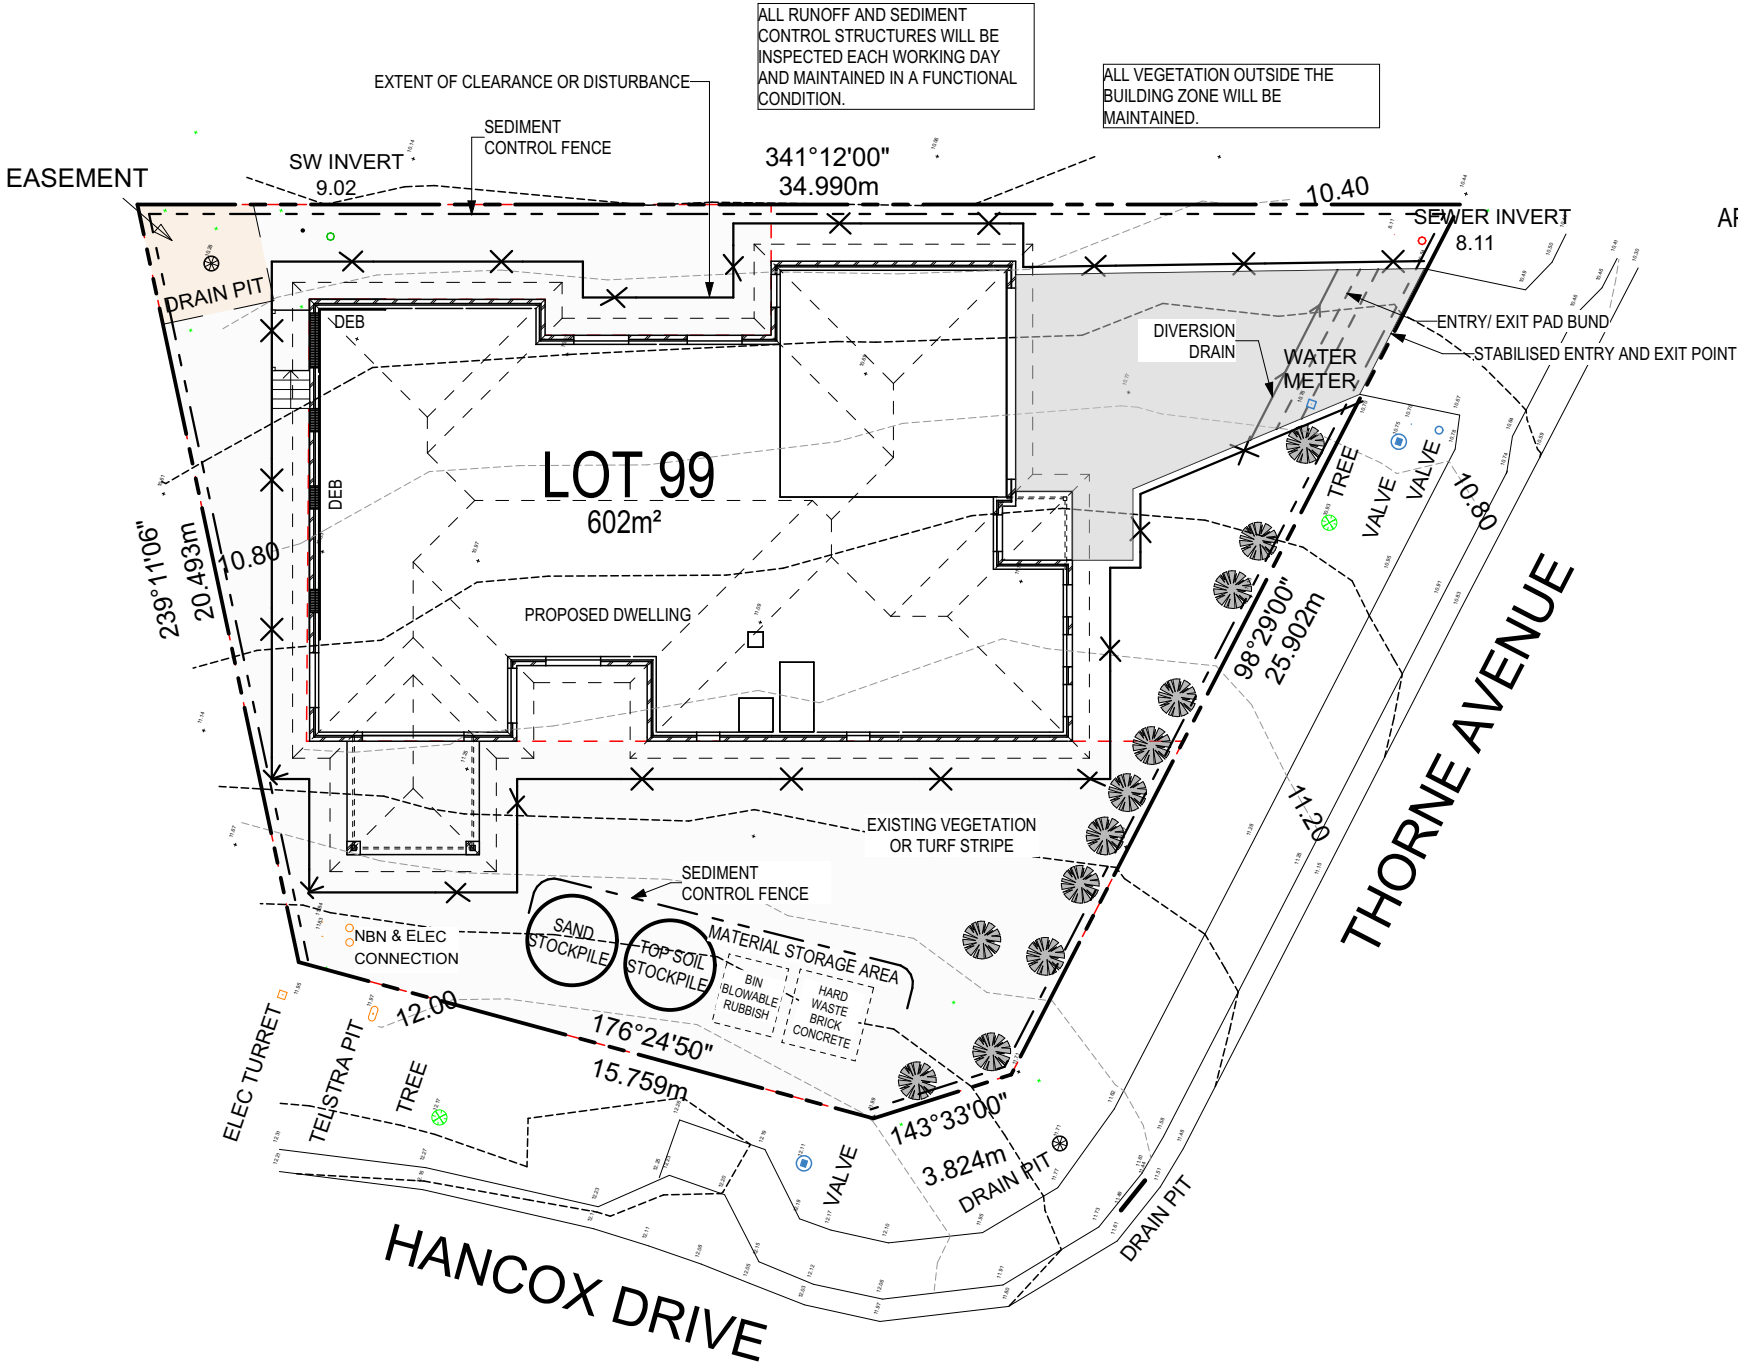

APPROX. CONC. DRIVEWAY
BY BUILDER
51m² TOTAL
(51m² TO BDY)

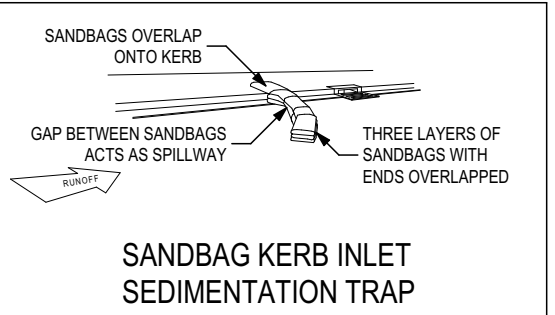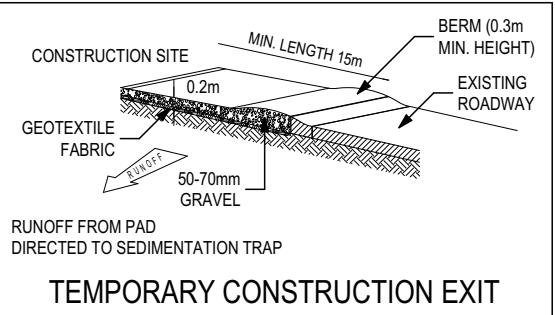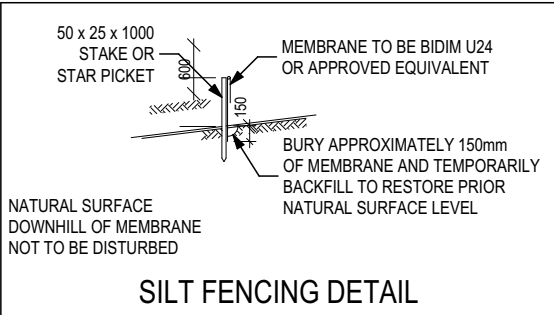


**SUBJECT TO NCC 2022
(1 MAY 2023)
WATERPROOFING & PLUMBING**

PLAN ACCEPTANCE BY OWNER

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	NEXTGEN	1	DRAFT SALES PLAN - CP	KPH 23/10/2025	HYEONJIN PAK & HYUNMIN JANG		RIVERTON 23		H-WATRTVT20SA	
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						LOT / SECTION / CT:	COUNCIL:	SHEET TITLE:	SHEET No.:	
					99 / - / 187077	WEST TAMAR	SOIL & WATER MANAGEMENT PLAN	3 / 23	1:200	714497

BAL-12.5 BUSHFIRE REQUIREMENTS
SEE SHEET 1 (COVER SHEET) FOR DETAILS

REFER TO SHEET 1 (COVER SHEET) FOR ALL BUILDING INFORMATION REGARDING:

- SUSTAINABILITY REQUIREMENTS
- SITE CLASSIFICATION
- GENERAL BUILDING INFORMATION

ALL MECHANICAL VENTILATION TO BE DISCHARGED TO OUTDOOR AIR AS PER NCC 2022 REQUIREMENTS

FIRE RESISTANT PLASTERBOARD TO BE INSTALLED BEHIND COOKTOP

ALL GROUND FLOOR BULKHEAD AND SQUARE SET OPENING FRAMES TO BE 2455 ABOVE FFL UNLESS NOTED OTHERWISE

ALL GROUND FLOOR INTERNAL DOORS TO BE 2340 HIGH UNLESS NOTED OTHERWISE (EXCLUDES CAVITY SLIDING DOORS)

REFER TO WINDOW AND DOOR SCHEDULES FOR FULL DETAILS OF ALL WINDOWS AND DOORS. PLEASE NOTE WINDOW AND DOOR SIZES ARE BASED ON MANUFACTURERS SPECIFICATIONS AT DEPOSIT STAGE AND MAY DIFFER SLIGHTLY TO THE SIZES NOMINATED IN THE SCOPE OF WORKS DUE TO MANUFACTURING CHANGES AT THE TIME OF CONSTRUCTION.

FINAL WINDOW AND EXTERIOR DOOR LOCATIONS MAY BE ADJUSTED ON SITE TO SUIT BRICKWORK GAUGE

ALL STAIR TREADS TO PROVIDE A MINIMUM SLIP RESISTANCE TO MEET NCC 2022 REQUIREMENTS

UNLESS NOTED OTHERWISE ALL ROOMS ARE REFERENCED AS FOLLOWS:



LEGEND

HS / WS	HOB SPOUT / WALL SPOUT
	FACE BRICK / COMMON BRICK
	RENDER
	SOUND INSULATION
AJ	BRICK ARTICULATION JOINT
SDP	STANDARD DOWNSPIPE
CDP	CHARGED DOWNSPIPE
	DENOTES DRAWER SIDE
	MECHANICAL VENTILATION
L.B.W	LOAD BEARING WALL
PB	PLASTERBOARD
FC	FIBRE CEMENT
	THIS DOOR OPENS FIRST
	SMOKE ALARM
#	LIFT OFF HINGE
+	WATER POINT
	FLOOR WASTE
	GAS BAYONET

MAIN DWELLING, GROUND FLOOR

ALFRESCO	10.50
COURTYARD	6.90
GARAGE	39.43
LIVING	179.58
PORCH	3.23
	239.64 m²

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2	PLANS UPDATE
3	PRELIM PLANS - INITIAL ISSUE

DRAWN

KPH	23/10/2025
MLG	24/10/2025
KPH	06/11/2025

CLIENT:

HYEONJIN PAK & HYUNMIN JANG

ADDRESS:

16 THORNE AVENUE, LEGANA TAS 7277

LOT / SECTION / CT:

99 / - / 187077

COUNCIL:

WEST TAMAR

HOUSE DESIGN:

RIVERTON 23

FACADE DESIGN:

CLASSIC

SHEET TITLE:

GROUND FLOOR PLAN

SHEET No.:

4 / 23

HOUSE CODE:

H-WATRV20SA

FACADE CODE:

F-WATRV20CLASA

SCALES:


1:100

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714497

PROPOSED SPOTTED GUM DECK, NATURAL TREATED PINE STEPS AND HANDRAILS.
MIN. 1m HIGH SELECTED NCC COMPLIANT HANDRAIL.

2R+G = 570 (OK)
RISERS = 5 @ 160mm
GOINGS = 4 @ 250mm

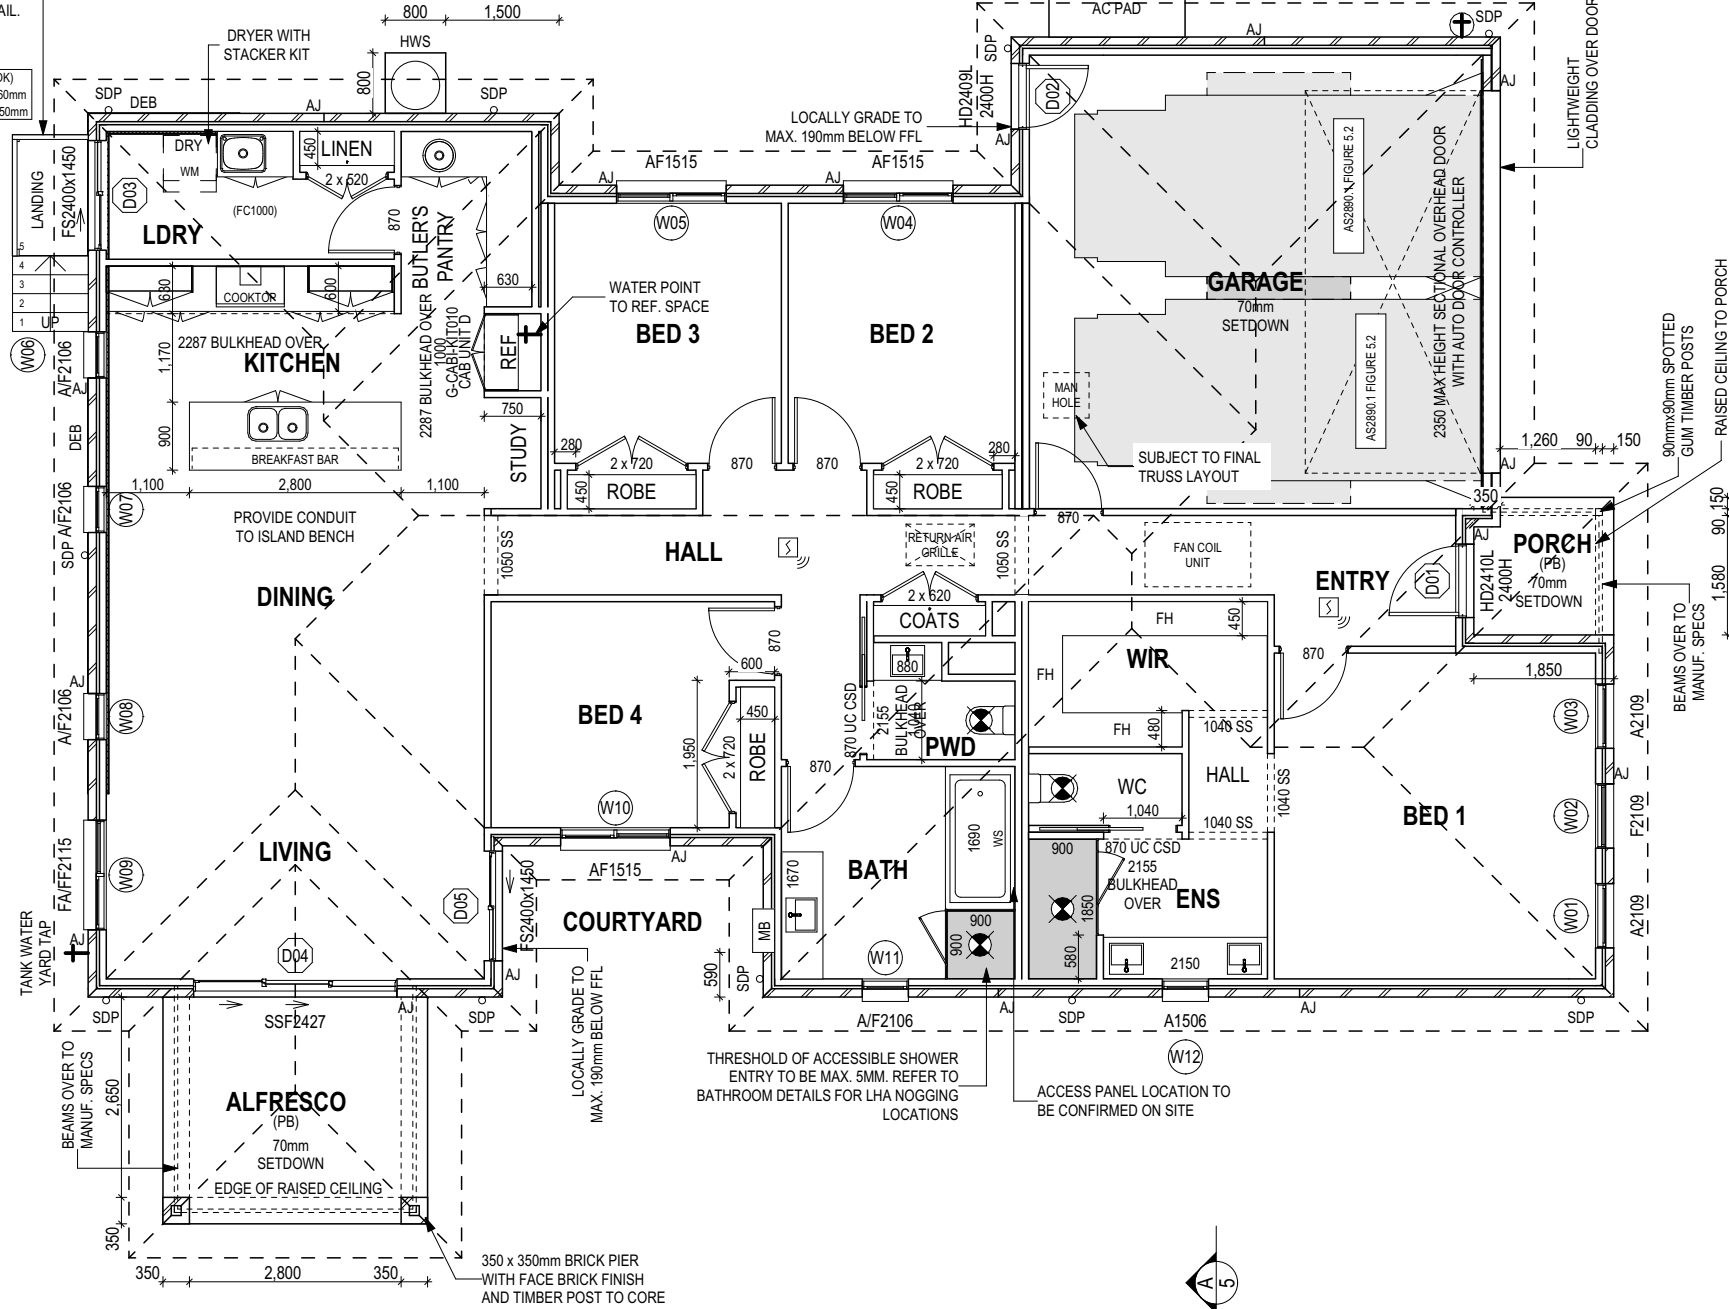


PROVIDE AND INSTALL SINGLE PHASE REVERSE CYCLE AIR CONDITIONING SYSTEM. NUMBER AND POSITIONING OF OUTLETS AND THE FINAL LOCATION OF THE RETURN AIR GRILLE WILL BE DETERMINED ON SITE BY THE AIR CONDITIONING CONTRACTOR AND IS SUBJECT TO TRUSS LAYOUT AND ANY OTHER CONSTRUCTION CONSTRAINTS.

FRAME MANUFACTURER TO PROVIDE CLEARANCE FOR PASSAGE OF FAN COIL UNIT FROM RETURN AIR OPENING TO FINAL FAN COIL LOCATION.

ANY PART OF THE FASCIA, GUTTERING OR DOWNSPIPE THAT IS WITHIN 450mm OF ANY BOUNDARY IS TO BE NON-COMBUSTIBLE IN ACCORDANCE WITH NCC 2022

ALL EXTERIOR SLABS TO BE GRADED BY CONCRETE TO ACHIEVE APPROX 1:100 FALL TO OUTSIDE EDGE WITH MAXIMUM CROSSFALL OF 30mm OVER ENTIRE SLAB.

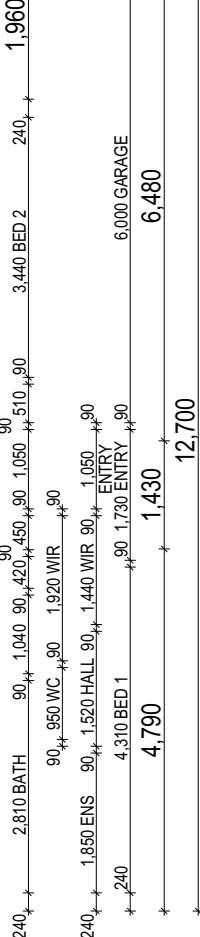

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(1 MAY 2023)
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BAL-12.5 BUSHFIRE REQUIREMENTS
SEE SHEET 1 (COVER SHEET) FOR DETAILS

LOW REFLECTANCE GLAZING TO BE USED
ON WINDOWS AND GLAZED DOORS AS
REQUIRED BY CLA-S4.7.1

REFER TO SHEET 1 (COVER SHEET) FOR
ALL BUILDING INFORMATION REGARDING:
- SUSTAINABILITY REQUIREMENTS
- SITE CLASSIFICATION
- GENERAL BUILDING INFORMATION


SOME DETAILS ON THIS SHEET ARE
INDICATIVE ONLY FOR EXAMPLE
BRICKWORK AND CLADDING (EXPANSION
JOINTS, ORIENTATION AND LAYOUT) AND
ARE SUBJECT TO CHANGE.

SH = SNAP HEADER SILL


BEDROOM WINDOW OPENINGS
ABOVE 2m OFF THE SURFACE
BENEATH TO BE RESTRICTED AS
REQUIRED BY NCC 11.3.7 (VOLUME
TWO)

ROOMS OTHER THAN BEDROOM
WINDOW OPENINGS ABOVE 4m OFF
THE SURFACE BENEATH TO BE
RESTRICTED AS REQUIRED BY NCC
11.3.7 (VOLUME TWO)


REFER TO THE FOLLOWING DETAILS:
BRICK COURSING W-BRIC-001

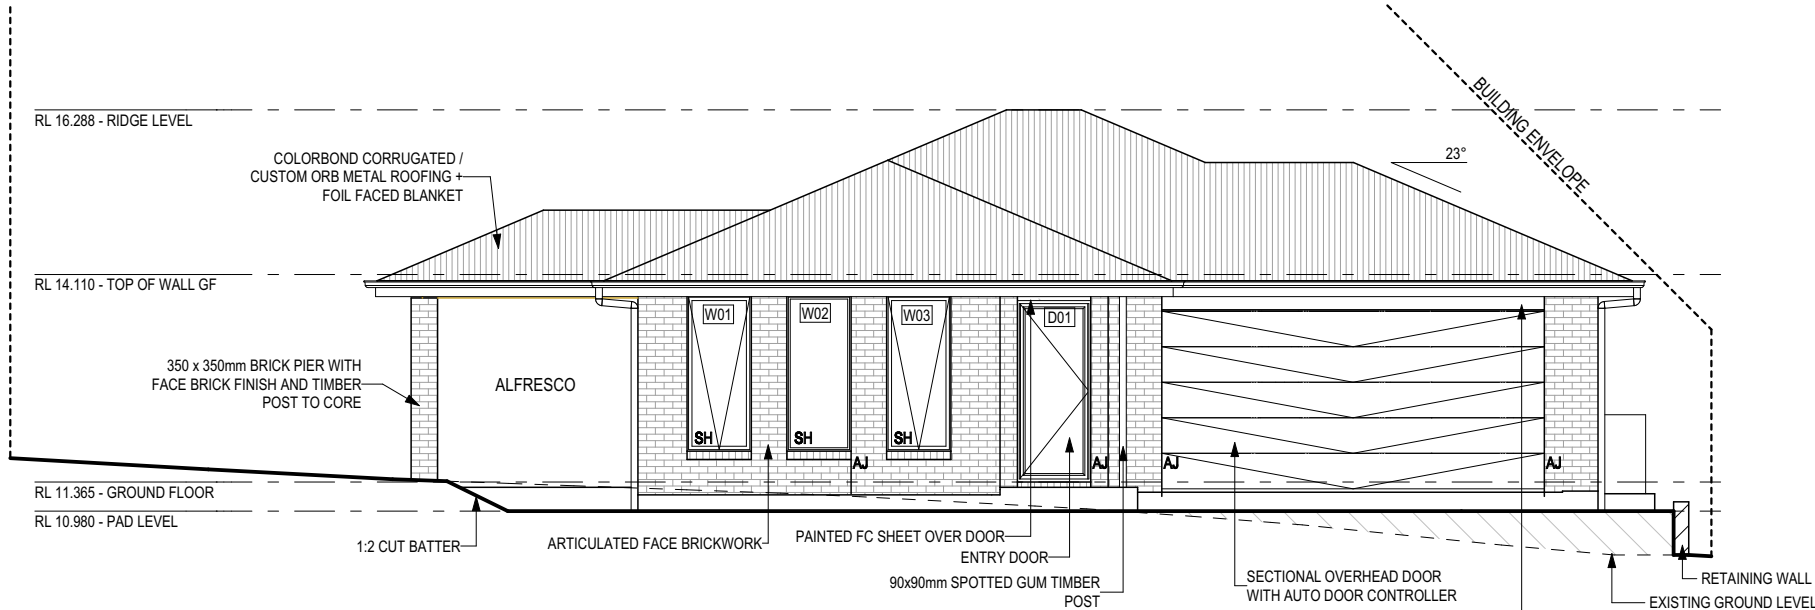

SOUTH ELEVATION
SCALE: 1:100

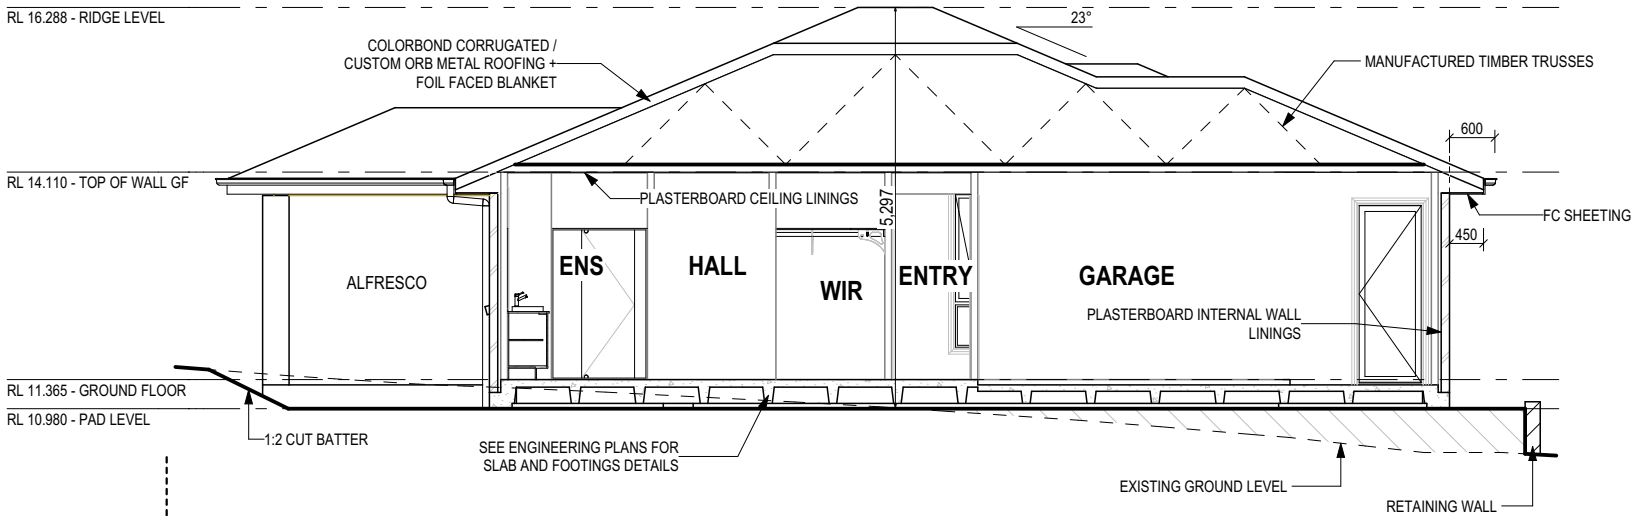


SECTION A-A
SCALE: 1:100

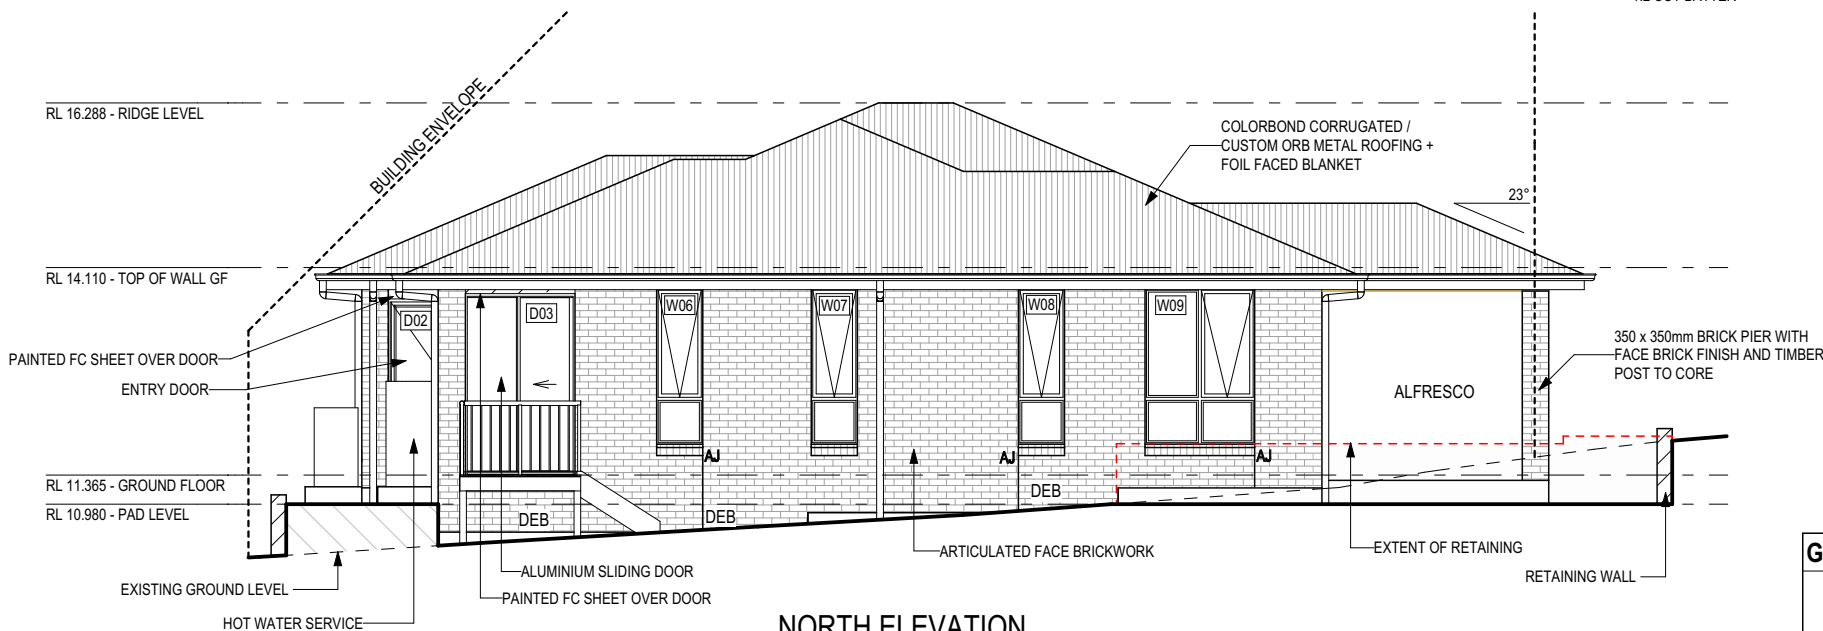


NORTH ELEVATION
SCALE: 1:100

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GLASS TYPE LEGEND

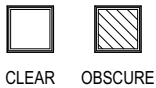

WINDOW TYPE LEGEND

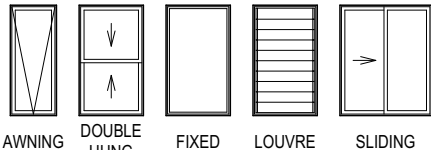

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16 THORNE AVENUE, LEGANA TAS 7277
LOT / SECTION / CT:
99 / - / 187077
COUNCIL:
WEST TAMAR

HOUSE DESIGN:
RIVERTON 23

FACADE DESIGN:
CLASSIC

SHEET TITLE:
ELEVATIONS / SECTION

SHEET No.:
5 / 23

HOUSE CODE:
H-WATRV20SA
FACADE CODE:
F-WATRV20CLASA
SCALES:
1:100

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BAL-12.5 BUSHFIRE REQUIREMENTS
SEE SHEET 1 (COVER SHEET) FOR DETAILS

LOW REFLECTANCE GLAZING TO BE USED
ON WINDOWS AND GLAZED DOORS AS
REQUIRED BY CLA-S4.7.1

REFER TO SHEET 1 (COVER SHEET) FOR
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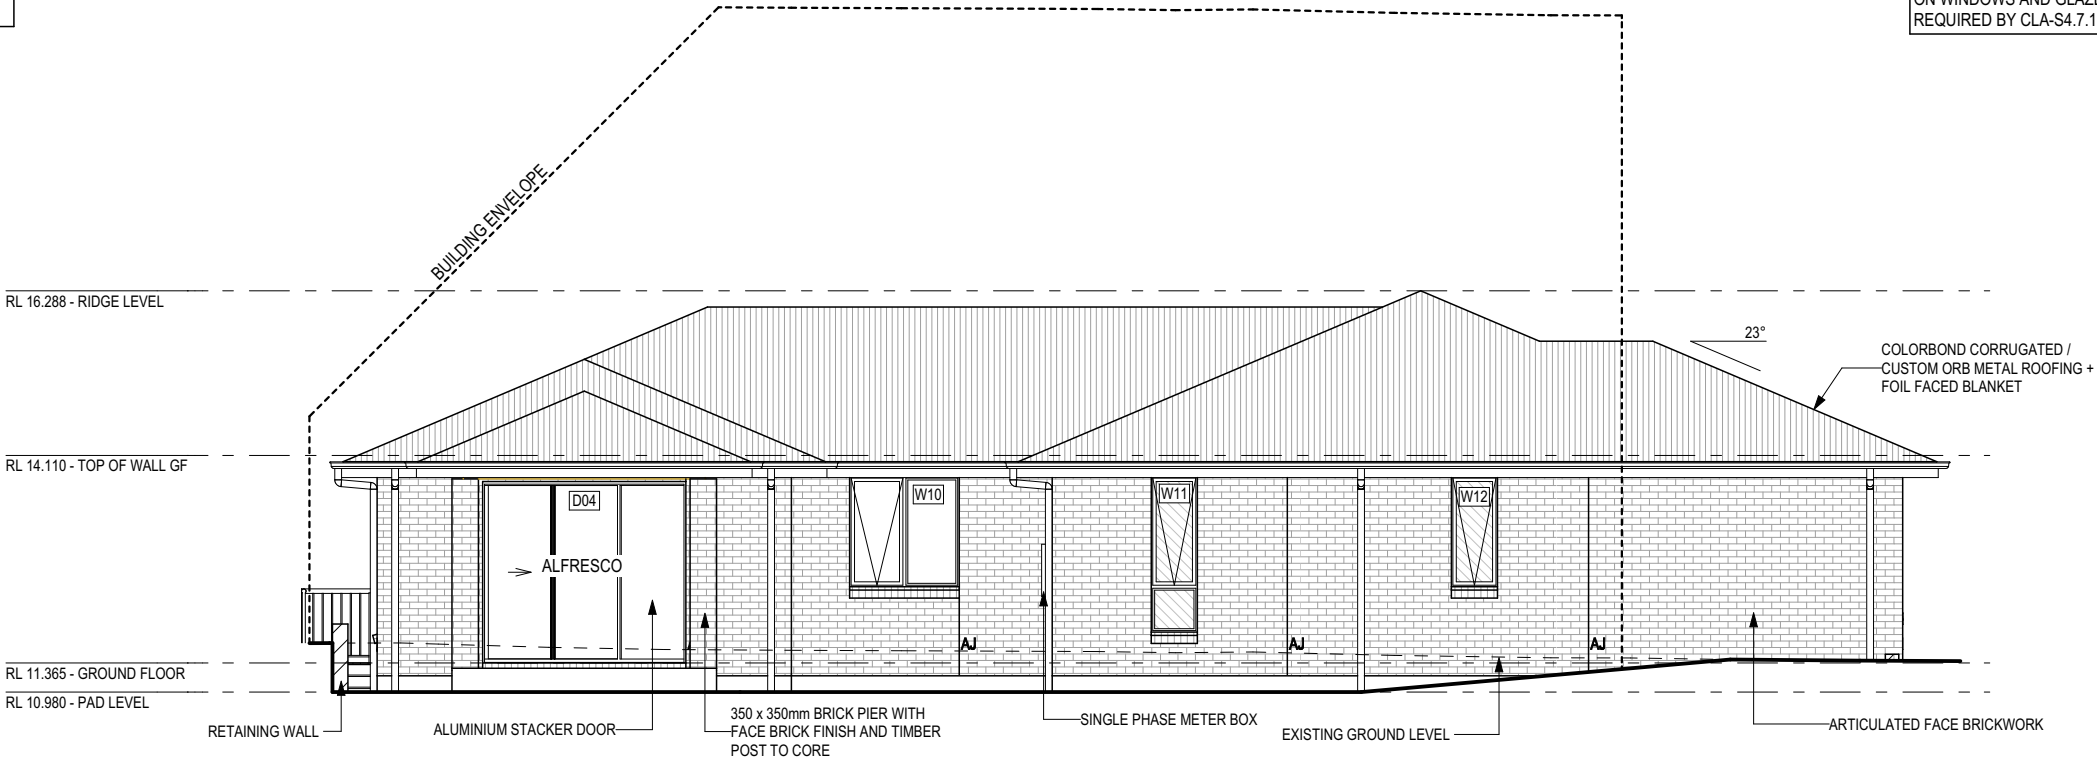
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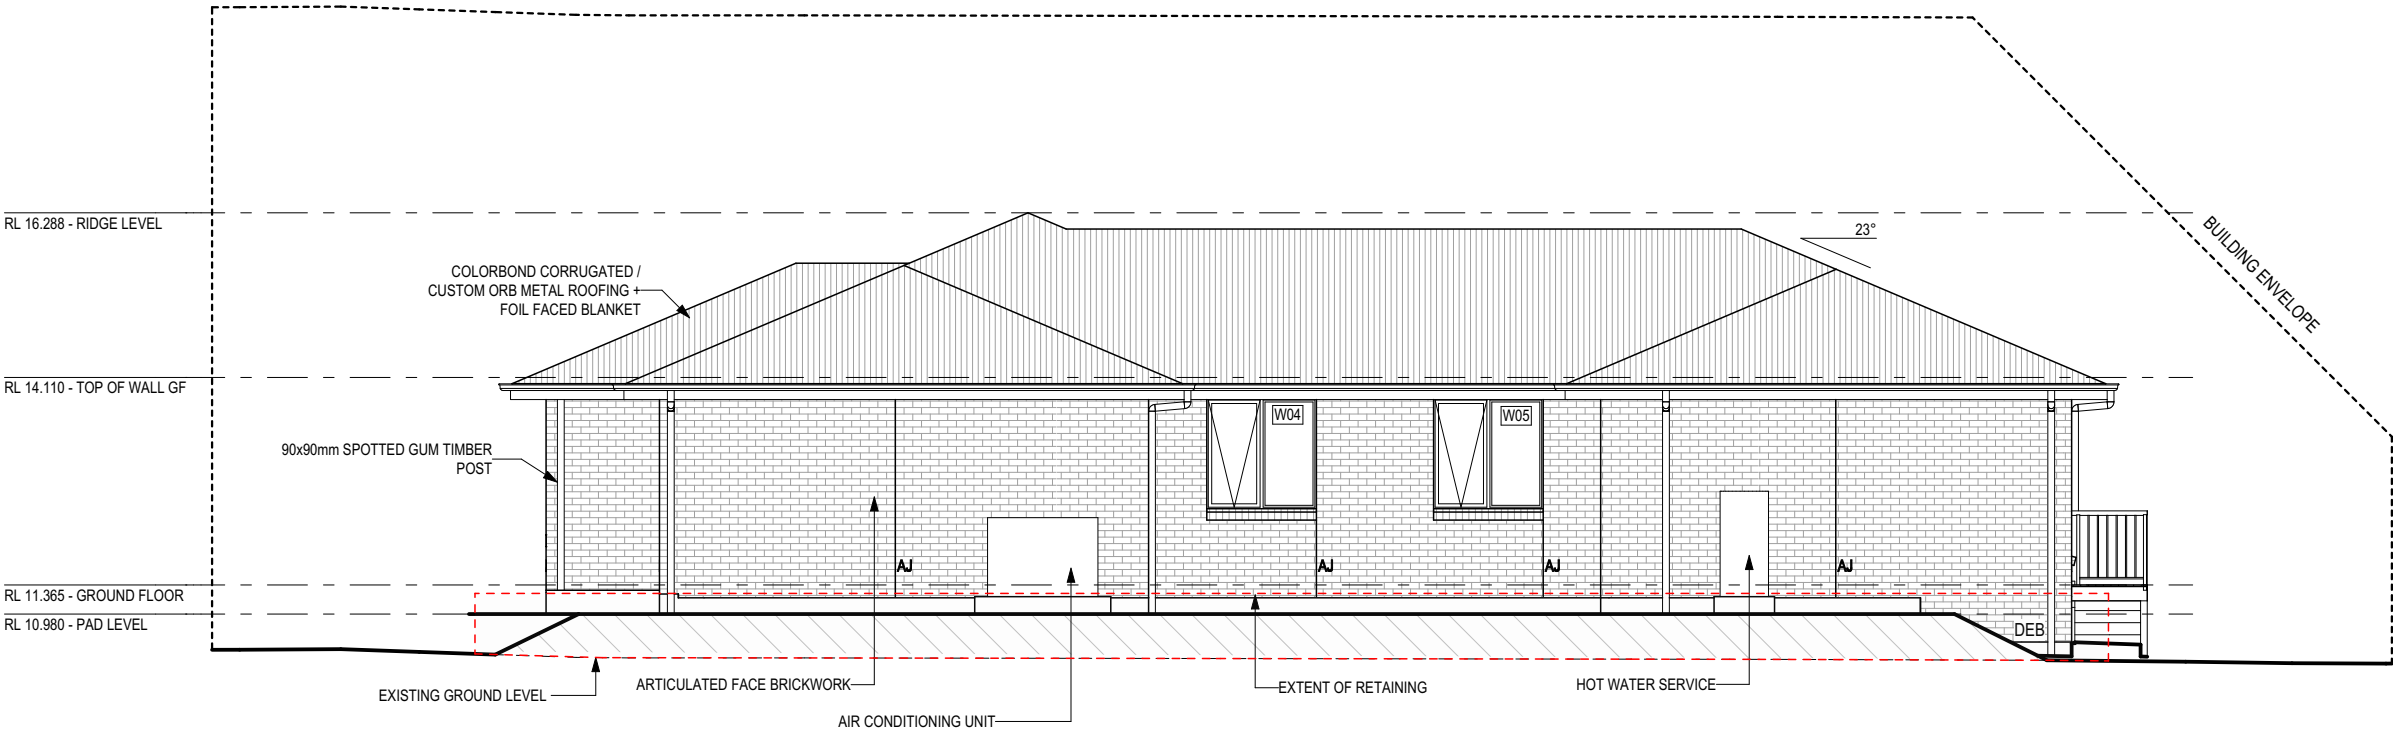
BEDROOM WINDOW OPENINGS
ABOVE 2m OFF THE SURFACE
BENEATH TO BE RESTRICTED AS
REQUIRED BY NCC 11.3.7 (VOLUME
TWO)

ROOMS OTHER THAN BEDROOM
WINDOW OPENINGS ABOVE 4m OFF
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11.3.7 (VOLUME TWO)

REFER TO THE FOLLOWING DETAILS:
BRICK COURSING W-BRIC-001




WEST ELEVATION
SCALE: 1:100




EAST ELEVATION
SCALE: 1:100

GLASS TYPE LEGEND

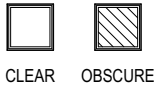

WINDOW TYPE LEGEND

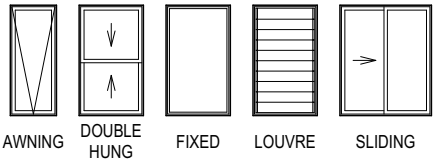

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FACADE DESIGN:

CLASSIC

SHEET TITLE:

ELEVATIONS

SHEET No.:

6 / 23

HOUSE CODE:

H-WATRV20SA

FACADE CODE:

F-WATRV20CLASA

SCALES:

1:100

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EXTERIOR WINDOW & DOOR SCHEDULE 1,2 ASSUME LOOKING FROM OUTSIDE

STOREY	ID	CODE¹	TYPE	ROOM	HEIGHT	WIDTH	PERIMETER	AREA (m²)	FRAME TYPE	BAL RATING	SILL TYPE	ORIENT.	GLAZING AREA (m²)	GLAZING TYPE <small>(SINGLE GLAZING U.N.O.)</small>	ADDITIONAL INFORMATION²
WINDOW															
GROUND FLOOR	W01	A2109	AWNING	BED 1	2,057	850	5,814	1.75	ALUMINIUM	BAL-12.5	SNAP HEADER	S	1.40	CLEAR, DOUBLE GLAZED	
GROUND FLOOR	W02	F2109	FIXED	BED 1	2,057	850	5,814	1.75	ALUMINIUM	BAL-12.5	SNAP HEADER	S	1.54	CLEAR, DOUBLE GLAZED	
GROUND FLOOR	W03	A2109	AWNING	BED 1	2,057	850	5,814	1.75	ALUMINIUM	BAL-12.5	SNAP HEADER	S	1.40	CLEAR, DOUBLE GLAZED	
GROUND FLOOR	W04	AF1515	AWNING	BED 2	1,457	1,450	5,814	2.11	ALUMINIUM	BAL-12.5	ANGLED	E	1.70	CLEAR, DOUBLE GLAZED	MP 725
GROUND FLOOR	W05	AF1515	AWNING	BED 3	1,457	1,450	5,814	2.11	ALUMINIUM	BAL-12.5	ANGLED	E	1.70	CLEAR, DOUBLE GLAZED	MP 725
GROUND FLOOR	W06	A/F2106	AWNING	KITCHEN	2,057	610	5,334	1.25	ALUMINIUM	BAL-12.5	ANGLED	N	0.93	CLEAR, DOUBLE GLAZED	BP 600
GROUND FLOOR	W07	A/F2106	AWNING	DINING	2,057	610	5,334	1.25	ALUMINIUM	BAL-12.5	ANGLED	N	0.93	CLEAR, DOUBLE GLAZED	BP 600
GROUND FLOOR	W08	A/F2106	AWNING	LIVING	2,057	610	5,334	1.25	ALUMINIUM	BAL-12.5	ANGLED	N	0.93	CLEAR, DOUBLE GLAZED	BP 600
GROUND FLOOR	W09	FA/FF2115	AWNING	LIVING	2,057	1,450	7,014	2.98	ALUMINIUM	BAL-12.5	ANGLED	N	2.39	CLEAR, DOUBLE GLAZED	BP 600, MP 725/725
GROUND FLOOR	W10	AF1515	AWNING	BED 4	1,457	1,450	5,814	2.11	ALUMINIUM	BAL-12.5	ANGLED	W	1.70	CLEAR, DOUBLE GLAZED	MP 725
GROUND FLOOR	W11	A/F2106	AWNING	BATH	2,057	610	5,334	1.25	ALUMINIUM	BAL-12.5	ANGLED	W	0.93	OBSCURER, DOUBLE GLAZED, TOUGHENED	BP 600
GROUND FLOOR	W12	A1506	AWNING	ENS	1,457	610	4,134	0.89	ALUMINIUM	BAL-12.5	ANGLED	W	0.64	OBSCURER, DOUBLE GLAZED, TOUGHENED	
							67,368 mm	20.47					16.18		
DOOR															
GROUND FLOOR	D01	HD2410L	SWINGING	ENTRY	2,400	970	6,740	2.33	ALUMINIUM	BAL-12.5	SNAP HEADER	S	1.63	CLEAR	
GROUND FLOOR	D02	HD2409L	SWINGING	GARAGE	2,400	870	6,540	2.09	ALUMINIUM	BAL-12.5	SNAP HEADER	N	1.41	CLEAR	
GROUND FLOOR	D03	FS2400x1450	SLIDING	LDRY	2,400	1,450	7,700	3.48	ALUMINIUM	BAL-12.5	SNAP HEADER	N	2.98	CLEAR, DOUBLE GLAZED, TOUGHENED	
GROUND FLOOR	D04	SSF2427	STACKER	LIVING	2,400	2,688	10,176	6.45	ALUMINIUM	BAL-12.5	SNAP HEADER	W	5.70	CLEAR, DOUBLE GLAZED, TOUGHENED	
GROUND FLOOR	D05	FS2400x1450	SLIDING	LIVING	2,400	1,450	7,700	3.48	ALUMINIUM	BAL-12.5	SNAP HEADER	S	2.98	CLEAR, DOUBLE GLAZED, TOUGHENED	
							38,856 mm	17.83					14.71		
							106,224 mm	38.30					30.89		

NOTE:
Provide BAL- 12.5 rated aluminium windows and external glass sliding doors in lieu of standard.
Provide flyscreens with corrosion resistant mesh to all opening window sashes only.

Window Manufacturer: Dowell Windows

No BAL / BAL 12.5 Window Type	WERS Code	U Value	SHGC
Sliding Window	DOW-022-003	2.9	0.64
Awning Window	DOW-005-001	3.9	0.58
Fixed External Window	DOW-038-001	3.03	0.71
Sliding Door	DAR-034-001	3.97	0.63
Stacking Door	DAR-034-001	3.97	0.63
Hinged Door	DOW-017-001	4.1	0.55
Bi-Fold Door	DOW-020-001	4.1	0.54
BAL 19 Window Type	WERS Code	U Value	SHGC
Sliding Window	TND-034-001	3.1	0.61
Awning Window	STG-001-066	3.91	0.54
Fixed External Window	DOW-038-005	3.02	0.66
Sliding Door	AUW-009-009	4.03	0.58
Stacking Door	AUW-009-009	4.03	0.58
Hinged Door	GRN-009-001	4.25	0.53
Bi-Fold Door	DOW-020-001	4.1	0.54
BAL 29 Window Type	WERS Code	U Value	SHGC
Sliding Window	TND-034-001	3.1	0.61
Awning Window	STG-001-066	3.91	0.54
Fixed External Window	DOW-038-005	3.02	0.66
Sliding Door	AMJ-007-005	4.03	0.59
Stacking Door	AMJ-007-005	4.03	0.59
Hinged Door	GRN-009-001	4.29	0.53

NOTE:
Windows supplied MUST HAVE Uw better and or equal to stated figures and SHGC within +/- 5% of stated figures. Restricted windows to have their openability restricted as per N.C.C 11.3.6.

PICTURE, TV RECESS AND SS WINDOW OPENINGS

QTY	TYPE	HEIGHT	WIDTH	AREA (m²)
-----	------	--------	-------	-----------

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WATERPROOFING & PLUMBING

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INTERIOR WINDOW & DOOR SCHEDULE

STOREY	QTY	CODE	TYPE	HEIGHT	WIDTH	GLAZING TYPE	ADDITIONAL INFORMATION
DOOR							
GROUND FLOOR	3	1040 SS	SQUARE SET OPENING	2,455	1,040	N/A	
GROUND FLOOR	2	1050 SS	SQUARE SET OPENING	2,455	1,050	N/A	
GROUND FLOOR	1	2 x 520	SWINGING	2,340	1,040	N/A	
GROUND FLOOR	1	2 x 620	SWINGING	2,340	1,240	N/A	
GROUND FLOOR	3	2 x 720	SWINGING	2,340	1,440	N/A	
GROUND FLOOR	7	870	SWINGING	2,340	870	N/A	
GROUND FLOOR	2	870 UC CSD	CAVITY SLIDING	2,040	870	N/A	20mm UNDERCUT

REFER TO SHEET 1 (COVER SHEET) FOR ALL BUILDING INFORMATION REGARDING:
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- SITE CLASSIFICATION
- GENERAL BUILDING INFORMATION

BAL-12.5 BUSHFIRE REQUIREMENTS
SEE SHEET 1 (COVER SHEET) FOR DETAILS

NOTE: INTERNAL DOORS TO WET AREAS WITH MECHANICAL VENTILATION TO BE UNDERCUT 20mm

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1 DRAFT SALES PLAN - CP

2 PLANS UPDATE

3 PRELIM PLANS - INITIAL ISSUE

DRAWN

KPH 23/10/2025

MLG 24/10/2025

KPH 06/11/2025

CLIENT:

HYEONJIN PAK & HYUNMIN JANG

ADDRESS:

16 THORNE AVENUE, LEGANA TAS 7277

LOT / SECTION / CT:

99 / - / 187077

COUNCIL:

WEST TAMAR

HOUSE DESIGN:

RIVERTON 23

FACADE DESIGN:

CLASSIC

SHEET TITLE:

WINDOW & DOOR SCHEDULES

HOUSE CODE:

H-WATRV20SA

FACADE CODE:

F-WATRV20CLASA

SHEET No.:

7 / 23

SCALES:

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NATURAL LIGHT AND VENTILATION

ROOM	AREA (m2)	WINDOW ID	LIGHT REQUIRED (m2)	LIGHT ACHIEVED (m2)	VENTILATION REQ`D (m2)	VENTILATION ACH`D (m2)
OPEN KITCHEN/ LIVING/ DINING/ STUDY	48.36 m²	D04, D05, W06, W07, W08, W09	4.84 m²	13.86 m²	2.42 m²	9.05 m²
BED 1	18.32 m²	W01, W02, W03	1.83 m²	4.34 m²	0.92 m²	3.26 m²
BED 2	11.22 m²	W04	1.12 m²	1.70 m²	0.56 m²	0.97 m²
BED 3	11.19 m²	W05	1.12 m²	1.70 m²	0.56 m²	0.97 m²
BED 4	10.99 m²	W10	1.10 m²	1.70 m²	0.55 m²	0.97 m²

PART 10.5.1 LIGHT: Minimum 10% of the floor area of a habitable room required (natural light)

PART 10.6 VENTILATION: Minimum 5% of the floor area of a habitable room required. (An exhaust fan may be used for sanitary compartment, laundry or bathroom provided contaminated air discharges directly to the outside of the building by way of ducts).

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BAL-12.5 BUSHFIRE REQUIREMENTS
SEE SHEET 1 (COVER SHEET) FOR DETAILS

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	2 PLANS UPDATE	MLG 24/10/2025	ADDRESS:	FACADE DESIGN:	FACADE CODE:	
	3 PRELIM PLANS - INITIAL ISSUE	KPH 06/11/2025	16 THORNE AVENUE, LEGANA TAS 7277	CLASSIC	F-WATRV20CLASA	
			LOT / SECTION / CT:	SHEET TITLE:	SCALES:	
			99 / - / 187077	WEST TAMAR	8 / 23	714497


WHERE DOWNPIPES ARE FURTHER THAN 1.2m AWAY FROM VALLEY REFER TO N.C.C. 7.3.5(2)


POSITION AND QUALITY OF DOWNPIPES ARE NOT TO BE ALTERED WITHOUT CONSULTATION WITH DESIGNER.

AREA'S SHOWN ARE SURFACE AREAS/ CATCHMENT AREAS, NOT PLAN AREAS

Roofing Data		
	268.49	Flat Roof Area (excluding gutter and slope factor) (m ²)
	291.68	Roof Surface Area (includes slope factor, excludes gutter) (m ²)
Downpipe roof calculations (as per AS/NZA3500.3:2021)		
Ah	282.90	Area of roof catchment (including 115mm Slotted Quad Gutter) (m ²)
Ac	342.31	Ah x Catchment Area Multiplier for slope (Table 3.4.3.2 from AS/NZS 3500.3:2021) (1.21 for 23° pitch) (m ²)
Ae	6300	Cross sectional area of 57 x 115 Slotted Quad Gutter (mm ²)
DRI	91	Design Rainfall Intensity (determined from Table E1 from AS/NZS 3500.3:2021)
Acdp	64	Catchment area per Downpipe (determined from Figure 3.5(A) from AS/NZS 3500.3:2021) (m ²)
Required Downpipes	5.35	Ac / Acdp
Downpipes Provided	10	

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	© 2025	3	PRELIM PLANS - INITIAL ISSUE		KPH	06/11/2025	16 THORNE AVENUE, LEGANA TAS 7277		CLASSIC		F-WATRV20CLASA				
							LOT / SECTION / CT:		COUNCIL:		SHEET TITLE:			SHEET No.:	SCALES:
							99 / - / 187077		WEST TAMAR		ROOF DRAINAGE PLAN		10 / 23	1:100	714497

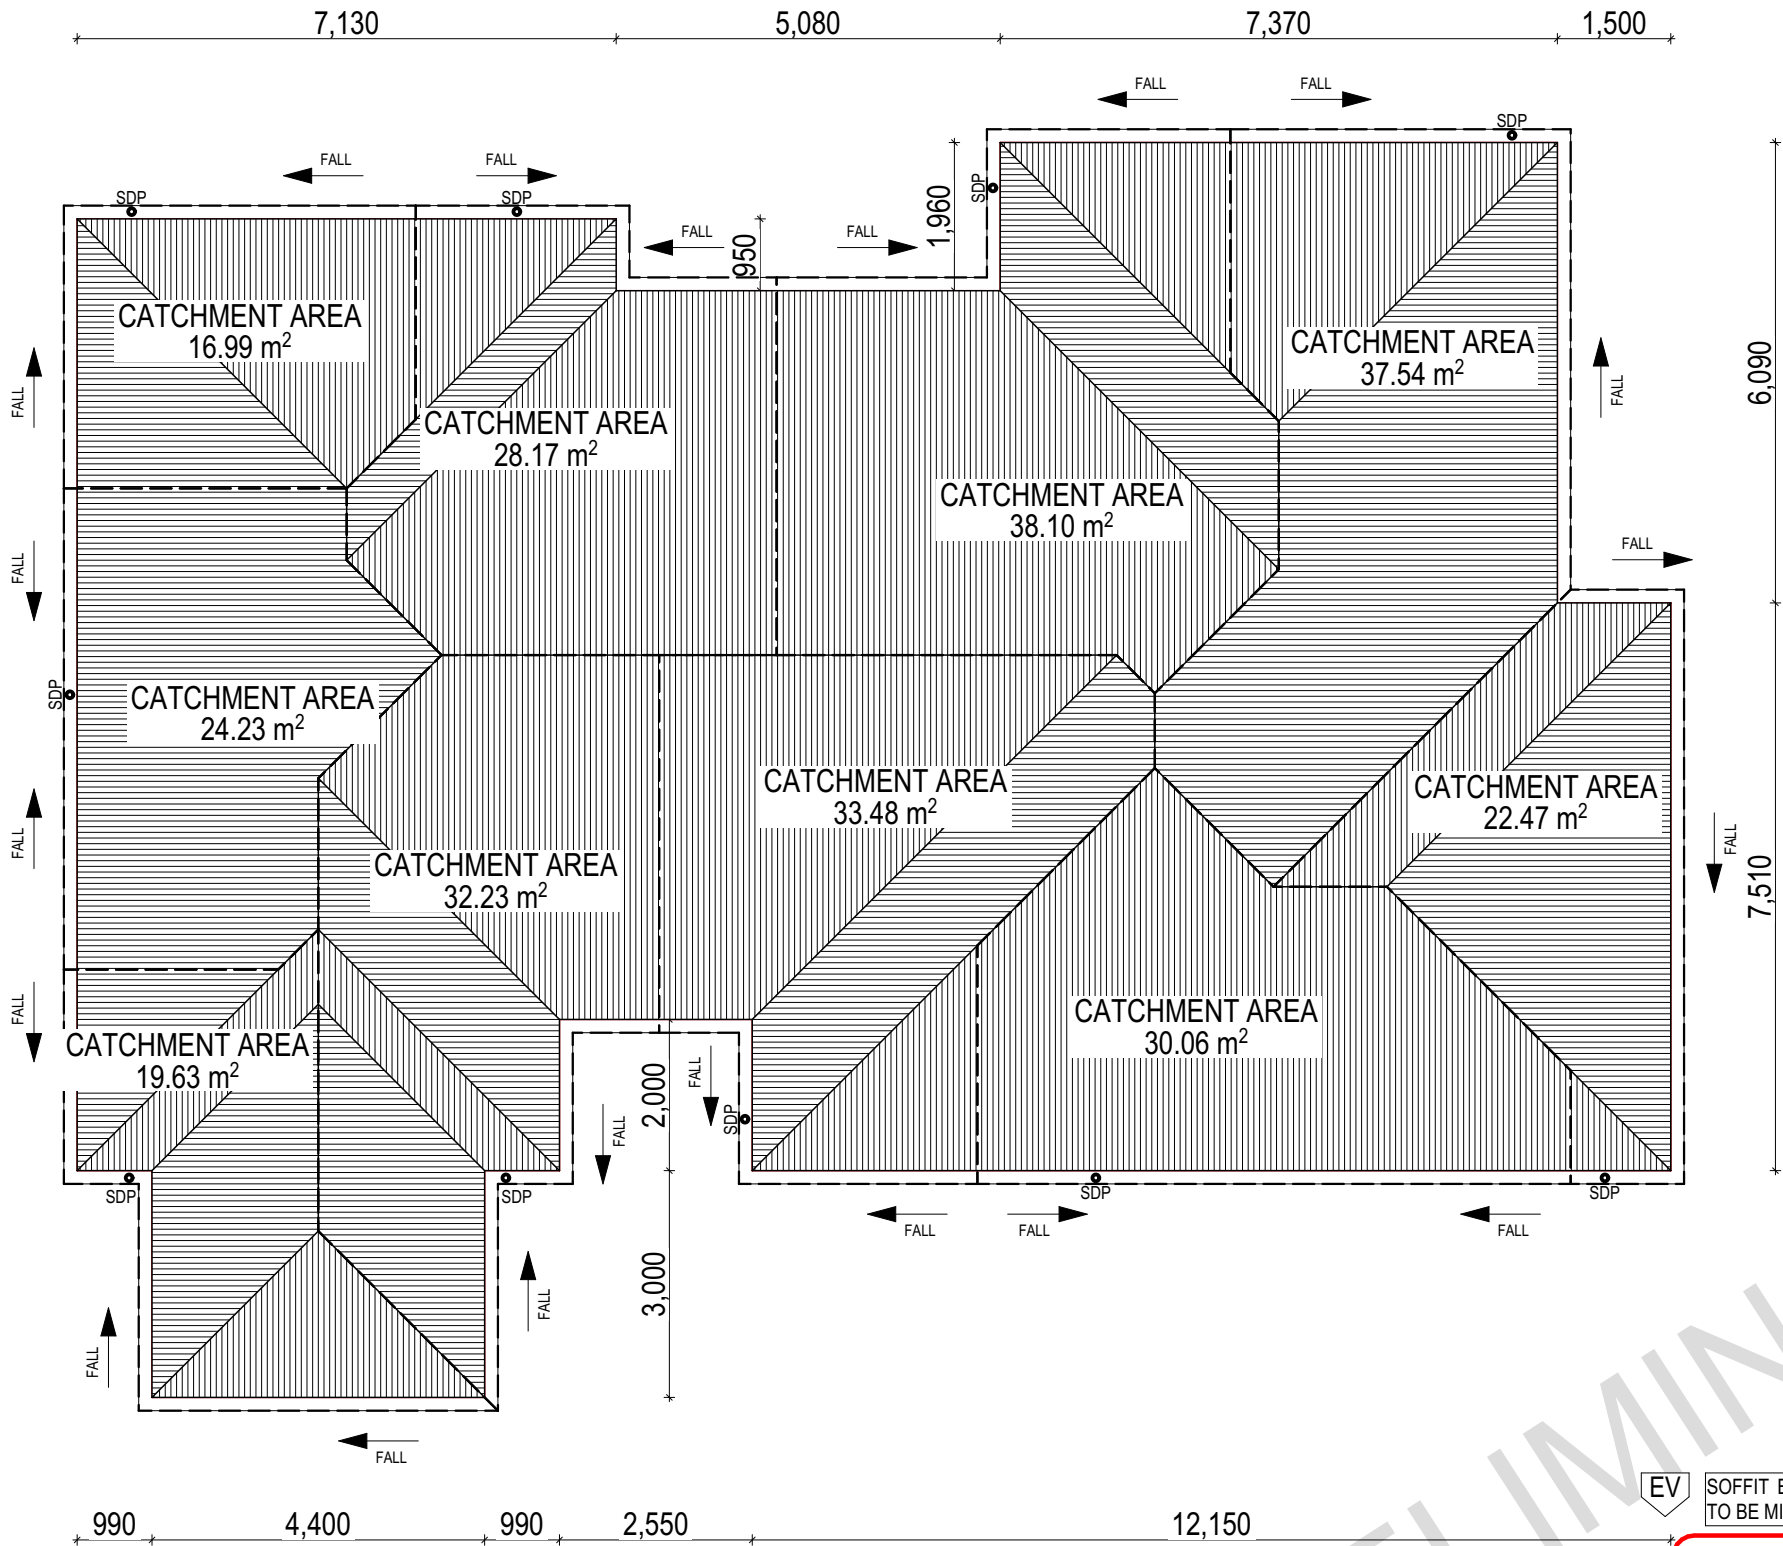

EV SOFFIT EAVE VENT PROPOSED LOCATION TO BE MIN. 1M FROM CORNER JOINT

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(1 MAY 2023)
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PLAN ACCEPTANCE BY OWNER	
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SIGNATURE:	DATE:
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- SITE CLASSIFICATION
- GENERAL BUILDING INFORMATION

FLOOR TILES SHOWN ON PLAN DO NOT INDICATE THE SIZE OR JOINT LOCATIONS OF THE ACTUAL FLOOR TILES.

TIMBER FLOORING SHOWN ON PLAN DOES NOT INDICATE THE BOARD SIZE OR DIRECTION OF THE ACTUAL FLOORING.

COVERINGS LEGEND

	NO COVERING
	COVER GRADE CONCRETE
	CARPET
	LAMINATE
	TILE (STANDARD WET AREAS)
	TILE (UPGRADED AREAS)
	DECKING



BAL-12.5 BUSHFIRE REQUIREMENTS
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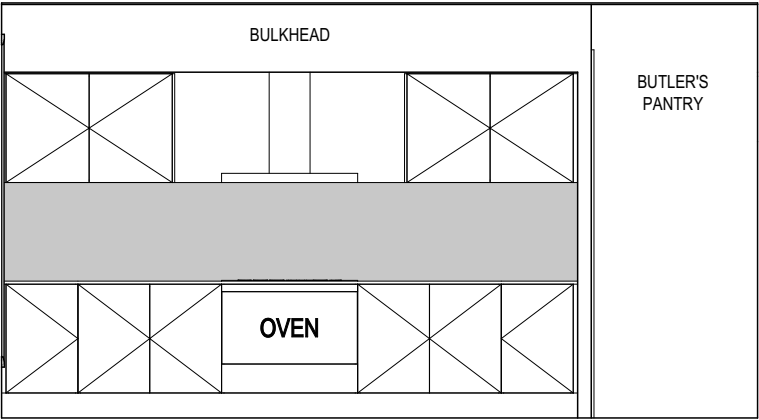


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			LOT / SECTION / CT: 99 / - / 187077	SHEET TITLE: FLOOR COVERINGS	SCALES: 1:100	
			COUNCIL: WEST TAMAR	SHEET No.: 11 / 23		714497


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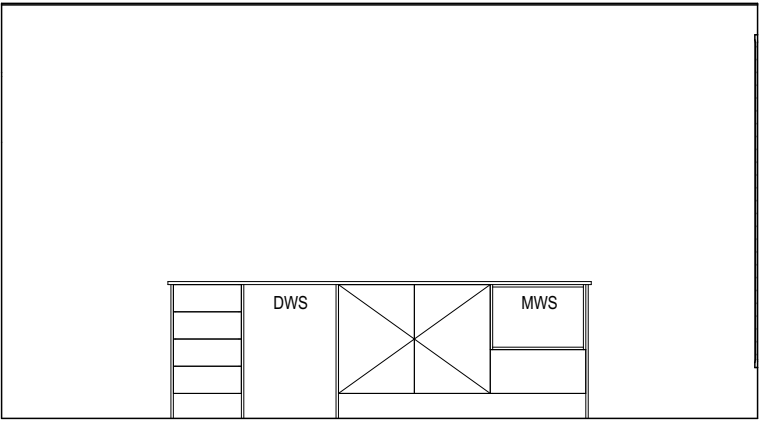
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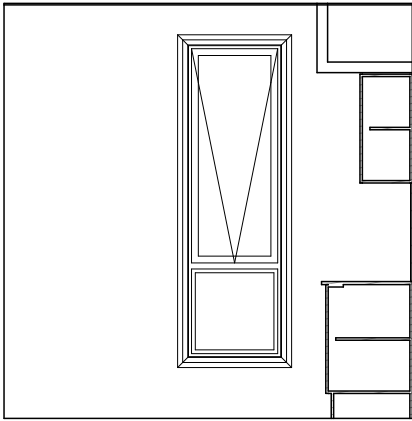
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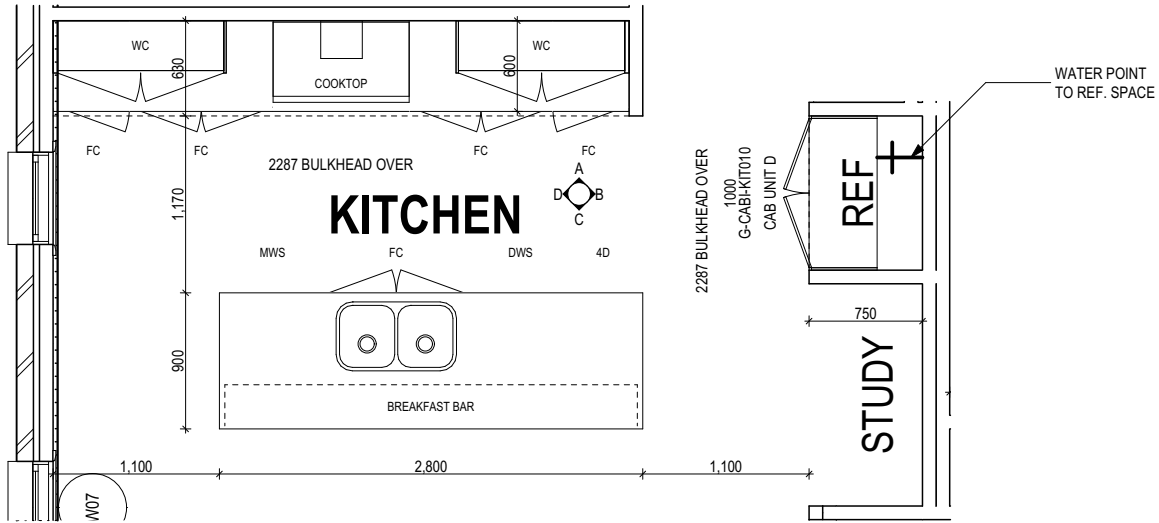
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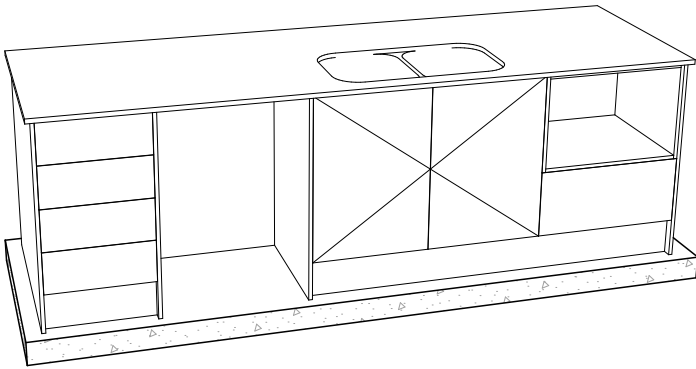
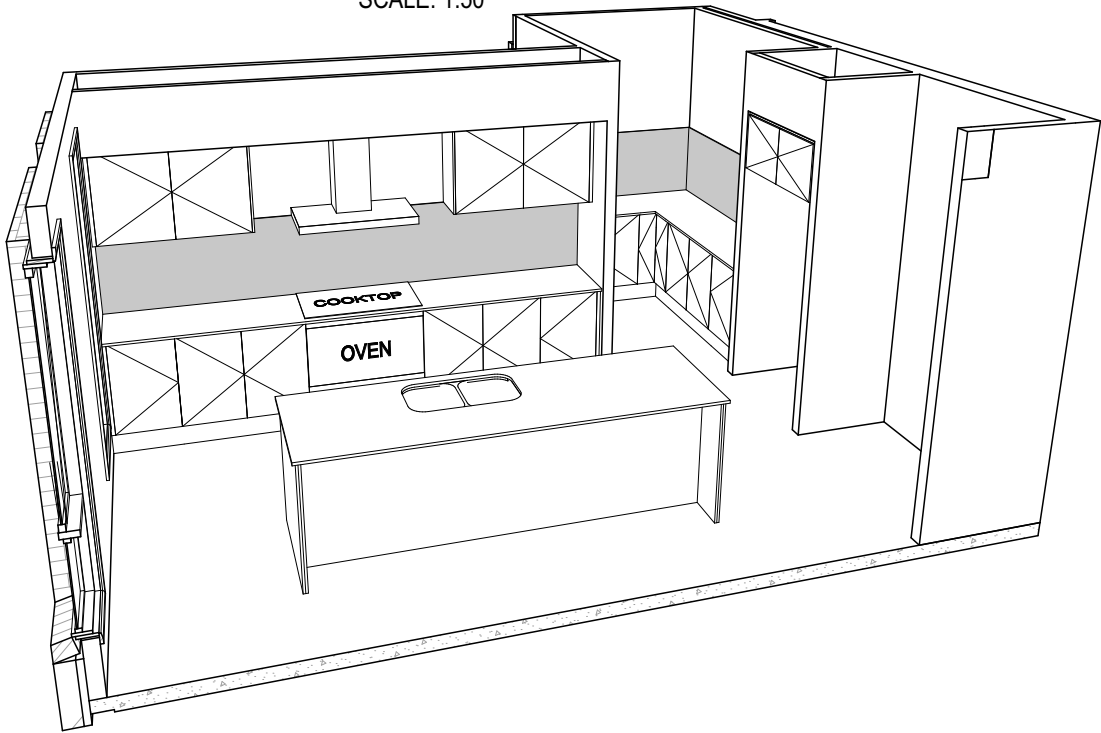
ELEVATION C
SCALE: 1:50



ELEVATION D
SCALE: 1:50



KITCHEN PLAN
SCALE: 1:50

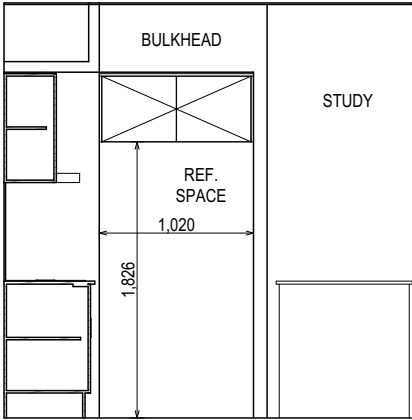

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DRAWN
KPH 23/10/2025
MLG 24/10/2025
KPH 06/11/2025

CLIENT:
HYEONJIN PAK & HYUNMIN JANG
ADDRESS:
16 THORNE AVENUE, LEGANA TAS 7277
LOT / SECTION / CT:
99 / - / 187077
COUNCIL:
WEST TAMAR

HOUSE DESIGN:
RIVERTON 23
FACADE DESIGN:
CLASSIC
SHEET TITLE:
KITCHEN DETAILS

HOUSE CODE:
H-WATRV20SA
FACADE CODE:
F-WATRV20CLASA
SHEET No.:
12 / 23


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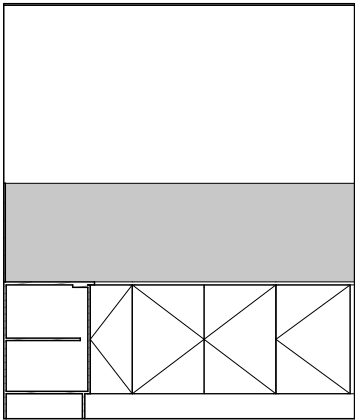
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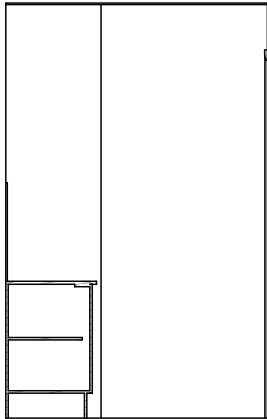
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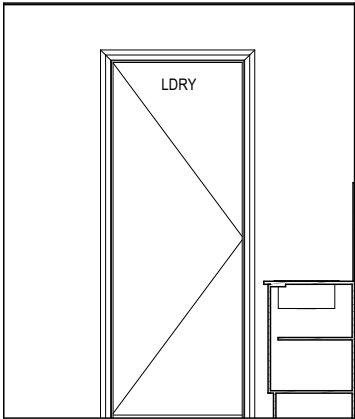
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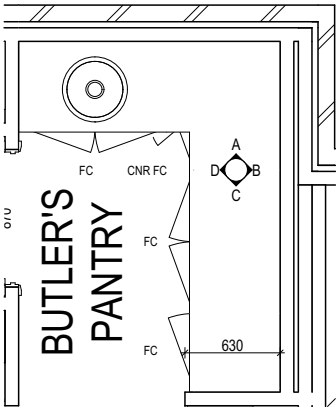
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SCALE: 1:50



ELEVATION C
SCALE: 1:50



ELEVATION D
SCALE: 1:50

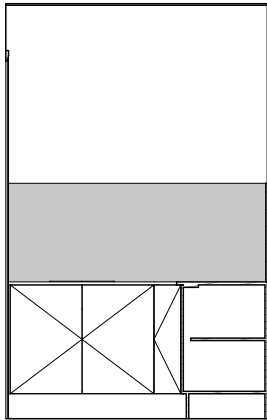

BUTLER'S PANTRY PLAN
SCALE: 1:50

SUBJECT TO NCC 2022
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			LOT / SECTION / CT: 99 / - / 187077	SHEET TITLE: BUTLER'S PANTRY DETAILS	SHEET No.: 13 / 23	
			COUNCIL: WEST TAMAR		SCALES: 1:50	714497

BAL-12.5 BUSHFIRE REQUIREMENTS
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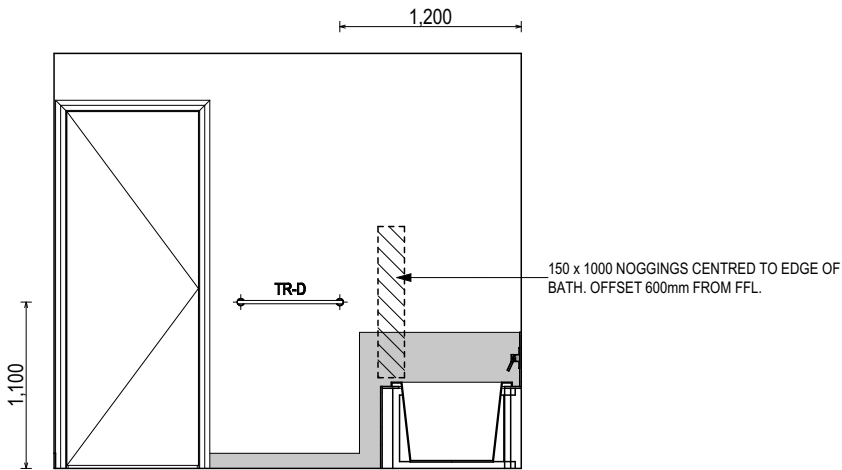
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WINDOW OVER BATH HOB D-WIND-ALU001
STANDARD BATH HOB D-WETA-BATH003
WET AREA TILING LAYOUTS D-WETA-TILE002
SQUARE SET WINDOWS G-WIND-SSET02
FULL HEIGHT TILING D-LINI-WETA

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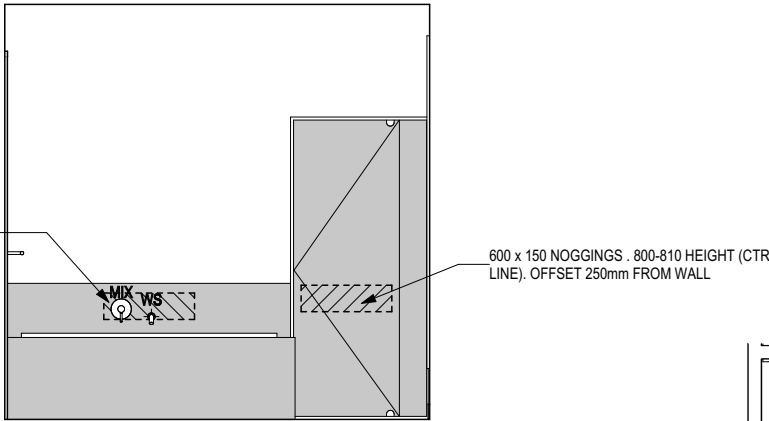
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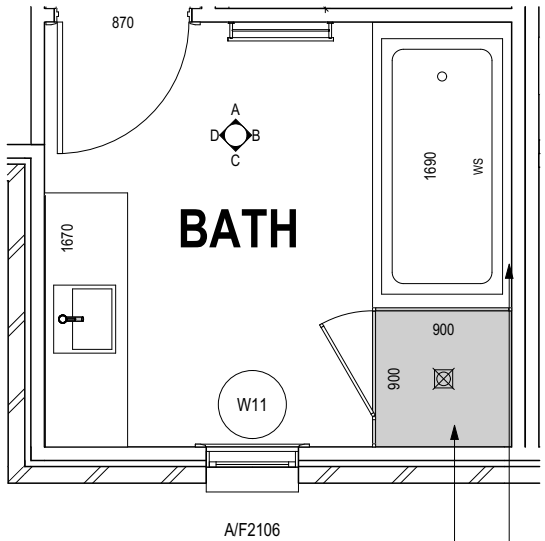
- RSHR RAIL SHOWER
ROSE SHOWER ROSE
ELBW SHOWER ELBOW
CONNECTION
MIX MIXER TAP
HT HOT TAP
CT COLD TAP
HS HOB SPOUT
WS WALL SPOUT
SC STOP COCK
TRH TOILET ROLL HOLDER
TR-S TOWEL RAIL - SINGLE
TR-D TOWEL RAIL - DOUBLE
TL TOWEL LADDER
TH TOWEL HOLDER
TR TOWEL RACK
TMB TUMBLER HOLDER
RNG TOWEL RING
RH ROBE HOOK
SHLF SHELF
SR SHAMPOO RECESS
SOAP SOAP HOLDER




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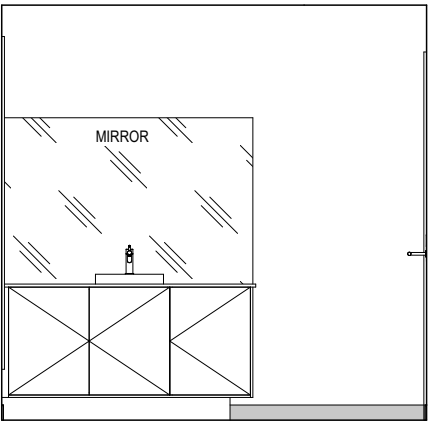
ELEVATION B
SCALE: 1:50



BATHROOM PLAN
SCALE: 1:50



ELEVATION C
SCALE: 1:50

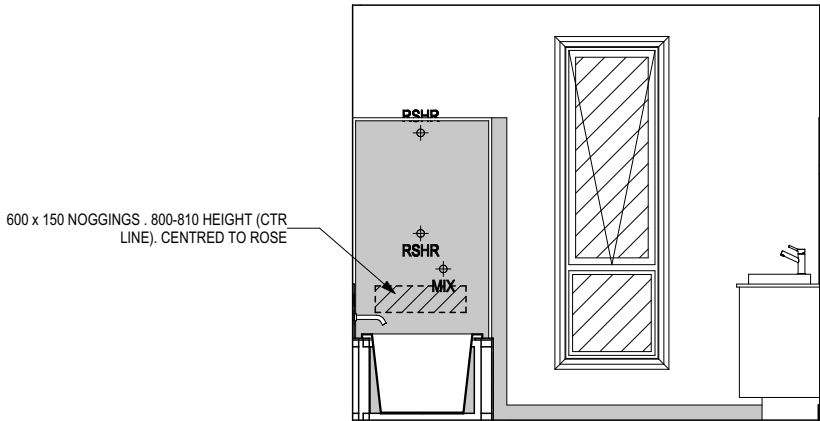

ELEVATION D
SCALE: 1:50

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FACADE CODE:
F-WATRV20CLASA
SHEET No.:
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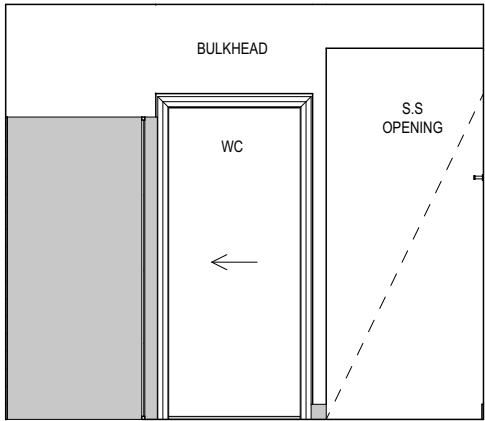
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VANITY DETAILS G-VANI-001
WINDOW OVER BATH HOB D-WIND-ALU001
STANDARD BATH HOB D-WETA-BATH003
WET AREA TILING LAYOUTS D-WETA-TILE002
SQUARE SET WINDOWS G-WIND-SSET02
FULL HEIGHT TILING D-LINI-WETA

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- GENERAL BUILDING INFORMATION


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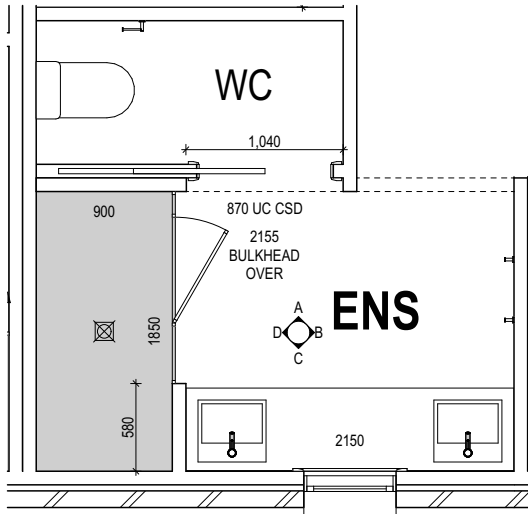
- RSHR RAIL SHOWER
ROSE SHOWER ROSE
ELBW SHOWER ELBOW
CONNECTION
MIX MIXER TAP
HT HOT TAP
CT COLD TAP
HS HOB SPOUT
WS WALL SPOUT
SC STOP COCK
TRH TOILET ROLL HOLDER
TR-S TOWEL RAIL - SINGLE
TR-D TOWEL RAIL - DOUBLE
TL TOWEL LADDER
TH TOWEL HOLDER
TR TOWEL RACK
TMB TUMBLER HOLDER
RNG TOWEL RING
RH ROBE HOOK
SHLF SHELF
SR SHAMPOO RECESS
SOAP SOAP HOLDER




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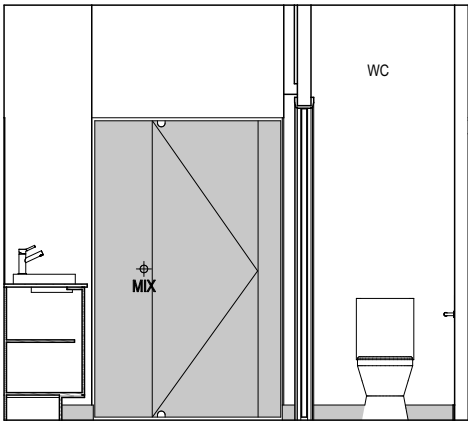
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ENSUITE PLAN
SCALE: 1:50



ELEVATION C
SCALE: 1:50

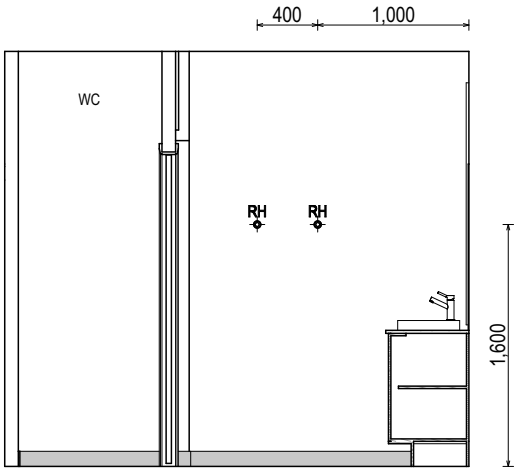

ELEVATION D
SCALE: 1:50

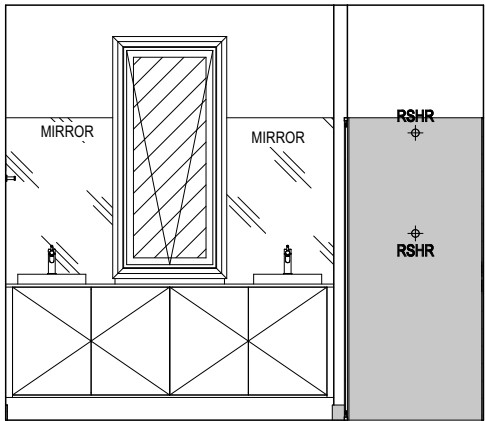SUBJECT TO NCC 2022
(1 MAY 2023)
WATERPROOFING & PLUMBING

PLAN ACCEPTANCE BY OWNER

SIGNATURE: DATE:

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REVISION

1 DRAFT SALES PLAN - CP

2 PLANS UPDATE

3 PRELIM PLANS - INITIAL ISSUE

DRAWN

KPH 23/10/2025

MLG 24/10/2025

KPH 06/11/2025

CLIENT:

HYEONJIN PAK & HYUNMIN JANG

ADDRESS:

16 THORNE AVENUE, LEGANA TAS 7277

LOT / SECTION / CT:

99 / - / 187077

COUNCIL:

WEST TAMAR

HOUSE DESIGN:

RIVERTON 23

FACADE DESIGN:

CLASSIC

SHEET TITLE:

ENSUITE DETAILS

SHEET No.:

15 / 23

HOUSE CODE:

H-WATRV20SA

FACADE CODE:

F-WATRV20CLASA


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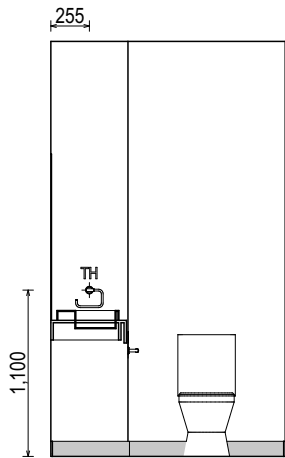
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714497


BAL-12.5 BUSHFIRE REQUIREMENTS
SEE SHEET 1 (COVER SHEET) FOR DETAILS




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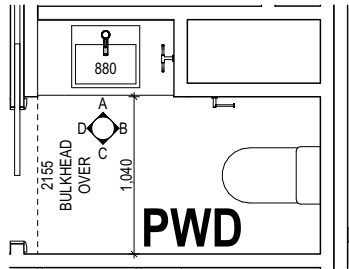
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ELEVATION C
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ELEVATION D
SCALE: 1:50

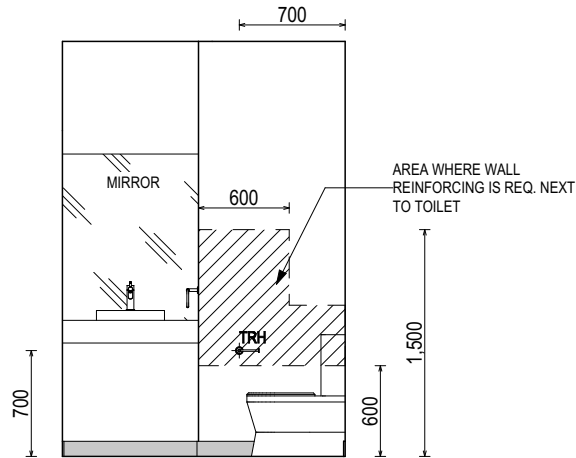

POWDER ROOM PLAN
SCALE: 1:50

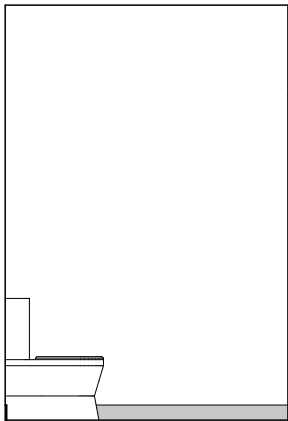REFER TO THE FOLLOWING DETAILS:
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ROSE	SHOWER ROSE
ELBW	SHOWER ELBOW CONNECTION
MIX	MIXER TAP
HT	HOT TAP
CT	COLD TAP
HS	HOB SPOUT
WS	WALL SPOUT
SC	STOP COCK
TRH	TOILET ROLL HOLDER
TR-S	TOWEL RAIL - SINGLE
TR-D	TOWEL RAIL - DOUBLE
TL	TOWEL LADDER
TH	TOWEL HOLDER
TR	TOWEL RACK
TMB	TUMBLER HOLDER
RNG	TOWEL RING
RH	ROBE HOOK
SHLF	SHELF
SR	SHAMPOO RECESS
SOAP	SOAP HOLDER

SUBJECT TO NCC 2022
(1 MAY 2023)
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2 PLANS UPDATE	MLG 24/10/2025
3 PRELIM PLANS - INITIAL ISSUE	KPH 06/11/2025
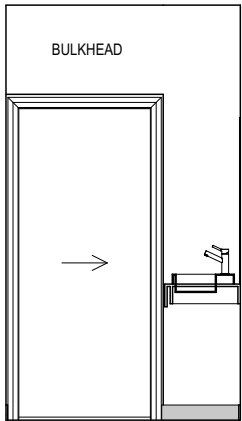
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LOT / SECTION / CT:
99 / - / 187077
COUNCIL:
WEST TAMAR

HOUSE DESIGN:
RIVERTON 23
FACADE DESIGN:
CLASSIC
SHEET TITLE:
POWDER ROOM DETAILS

HOUSE CODE:
H-WATRV20SA
FACADE CODE:
F-WATRV20CLASA
SHEET No.:
16 / 23


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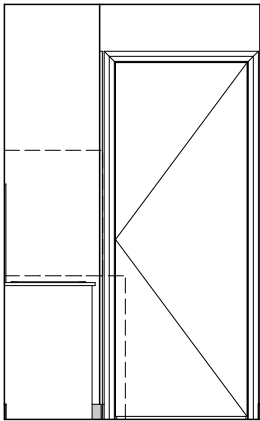
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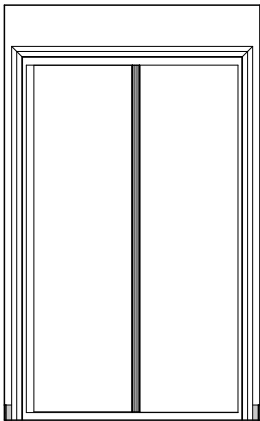
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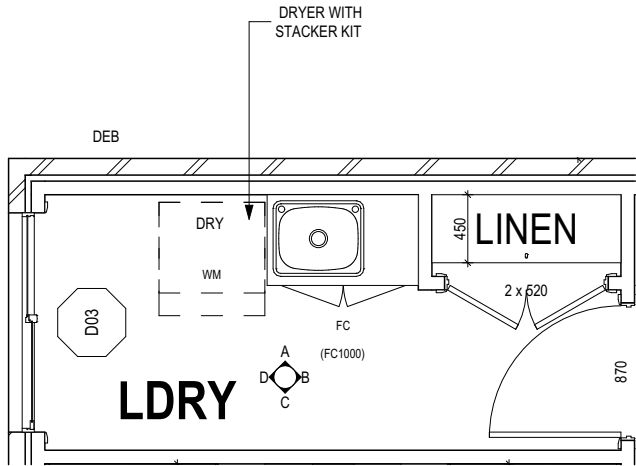
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ELEVATION C
SCALE: 1:50



ELEVATION D
SCALE: 1:50



LAUNDRY PLAN
SCALE: 1:50

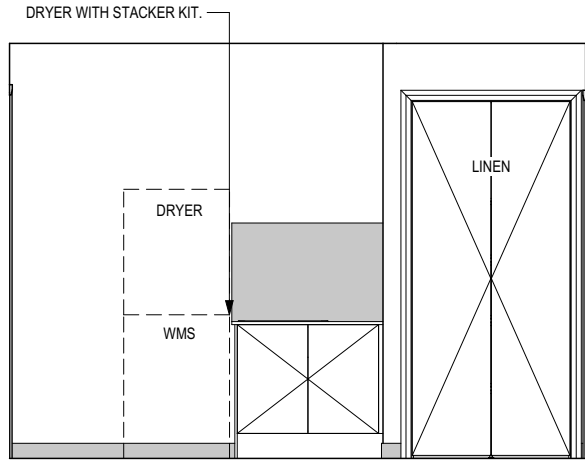SUBJECT TO NCC 2022
(1 MAY 2023)
WATERPROOFING & PLUMBING

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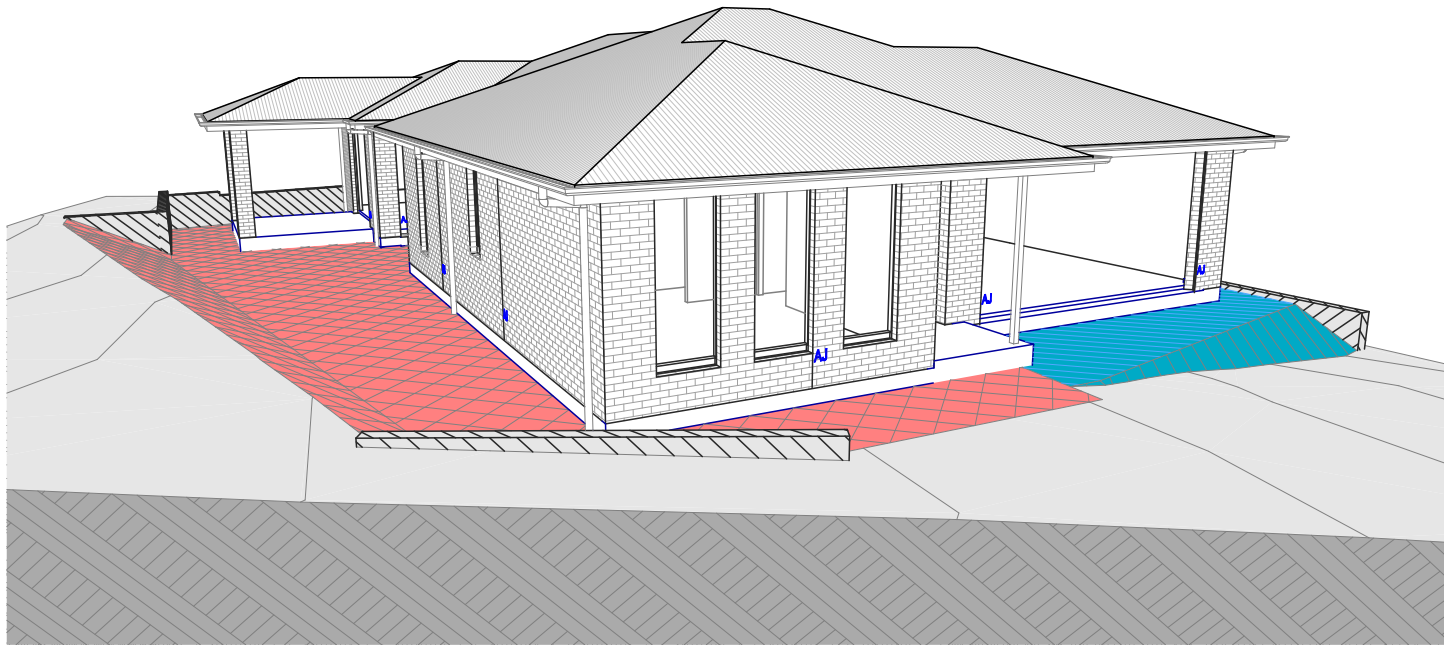
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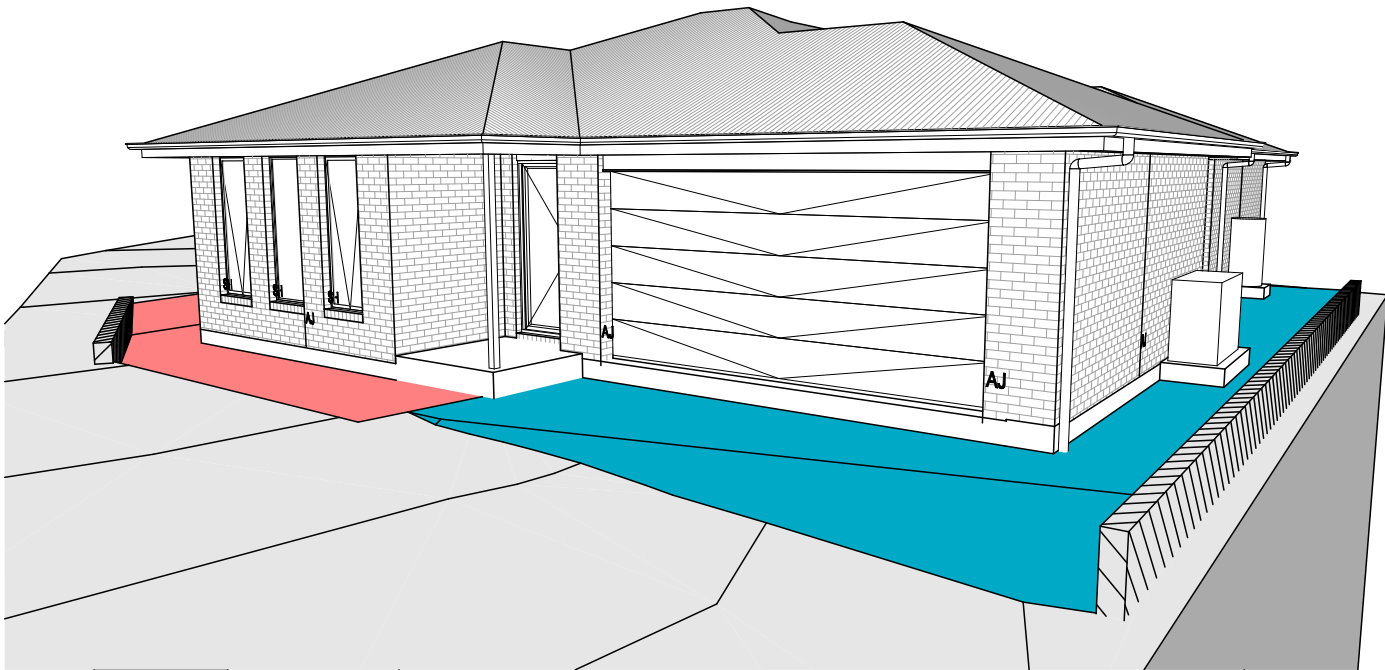
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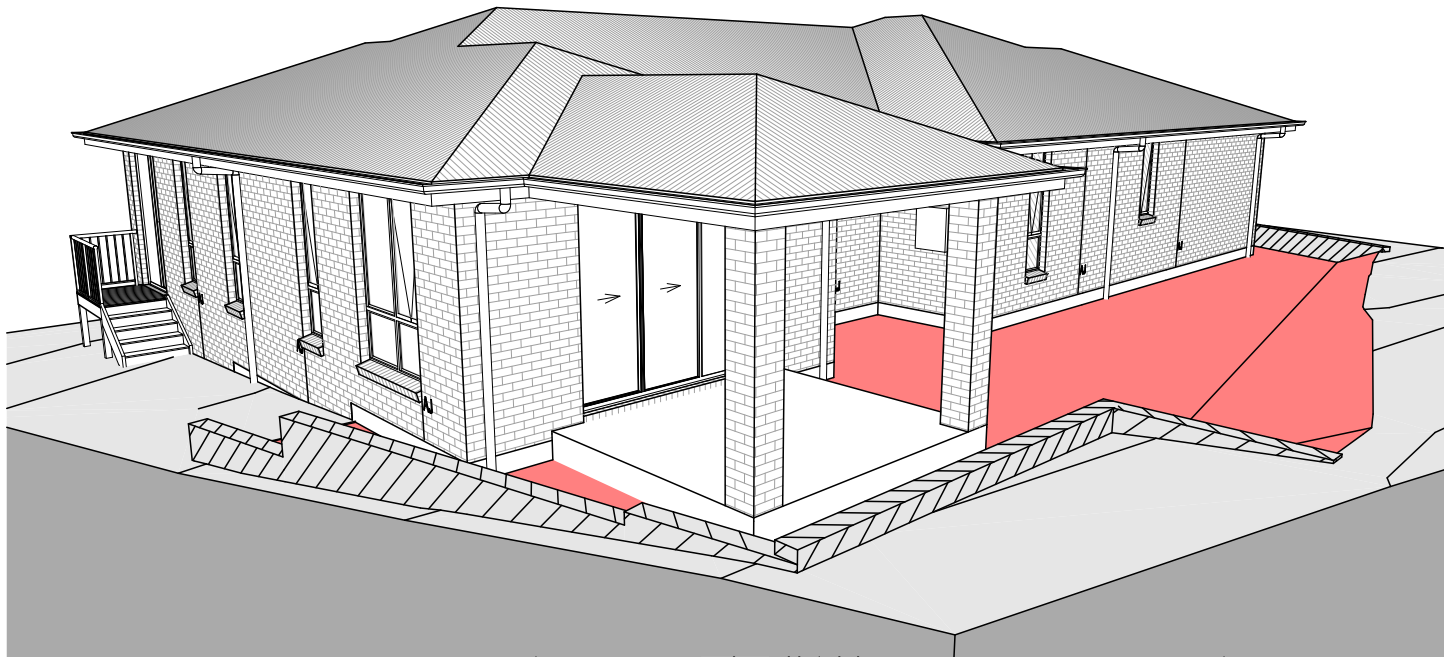
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	2 PLANS UPDATE	MLG 24/10/2025	ADDRESS:	FACADE DESIGN:	FACADE CODE:	
	3 PRELIM PLANS - INITIAL ISSUE	KPH 06/11/2025	16 THORNE AVENUE, LEGANA TAS 7277	CLASSIC	F-WATRV20CLASA	
			LOT / SECTION / CT: 99 / - / 187077	SHEET TITLE: LAUNDRY DETAILS	SHEET No.: 17 / 23	
			COUNCIL: WEST TAMAR		SCALES: 1:50	714497




FRONT LEFT



FRONT RIGHT



REAR LEFT

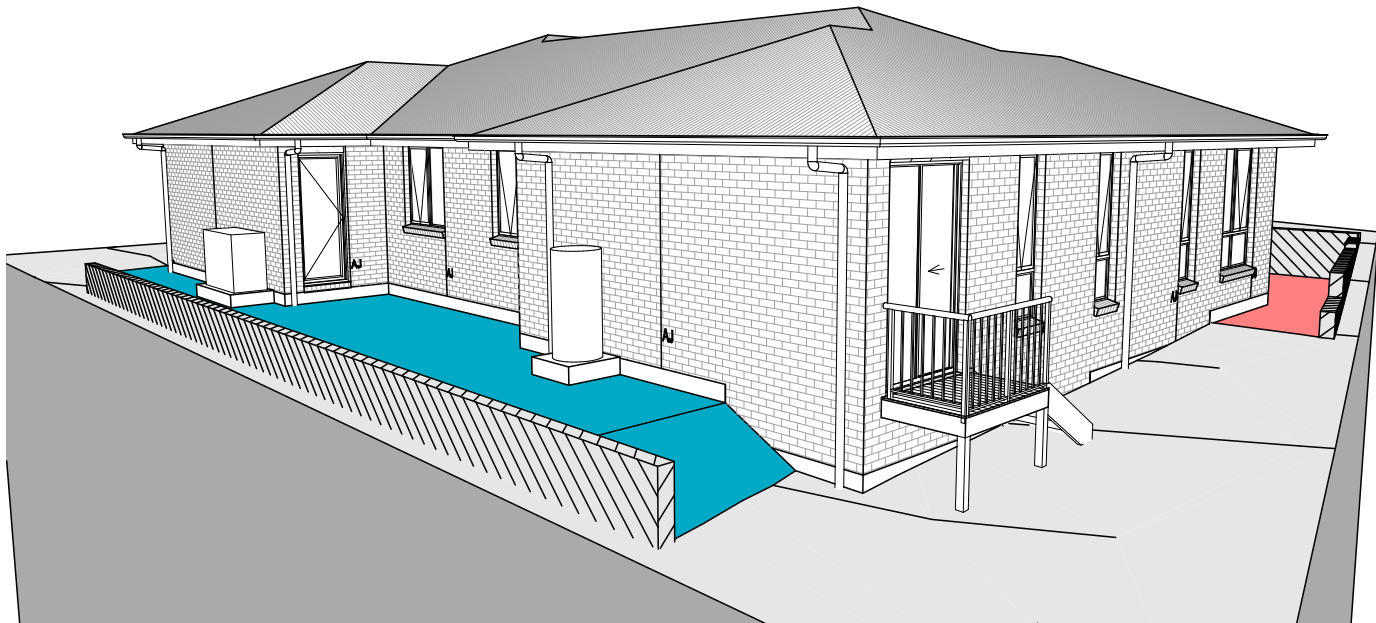

REAR RIGHT

BAL-12.5 BUSHFIRE REQUIREMENTS
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NOTE: SITE LEVELS AND SETBACKS SHOWN ARE INDICATIVE ONLY AND SUBJECT TO A FINAL CONTOUR SURVEY AND REGISTERED REPORTS BEING COMPLETED. 3D IMAGES ARE FOR ILLUSTRATIVE PURPOSES ONLY AND ARE SUBJECT TO CHANGE.

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			LOT / SECTION / CT: 99 / - / 187077	SHEET TITLE: 3D VIEWS	SCALES:	
			COUNCIL: WEST TAMAR		SHEET No.: 18 / 23	

GENERAL

- BUILDER TO VERIFY ALL DIMENSIONS AND LEVELS ON SITE PRIOR TO COMMENCEMENT OF WORK
- ALL WORK TO BE CARRIED OUT IN ACCORDANCE WITH THE NATIONAL CONSTRUCTION CODE (NCC)
- INTERNAL DIMENSIONS ARE TO WALL FRAMING ONLY AND DO NOT INCLUDE WALL LININGS

SITE WORKS

- CUT AND FILL BATTERS ARE INDICATIVE ONLY. BATTER TO COMPLY WITH THE NCC TABLE 3.2.1
- ALL CUTS AND FFL'S SHOWN (DA DRAWINGS) ARE SUBJECT TO ENGINEERING ADVICE ONCE A SATISFACTORY SOIL TEST HAS BEEN RECEIVED AND REVIEWED
- ALL EMBANKMENTS THAT ARE LEFT EXPOSED MUST BE STABILISED WITH VEGETATION OR SIMILAR TO PREVENT EROSION
- EMBANKMENTS CANNOT EXCEED 2.0m IN HEIGHT WITHOUT THE AID OF RETAINING WALLS OR OTHER APPROVED TYPES OF SOIL RETAINING METHODS
- ALL UNPROTECTED EMBANKMENTS MUST COMPLY WITH THE SLOPE RATIOS FOR SOIL TYPE IN TABLE 3.2.1 OF THE NCC

SOIL TYPE / CLASSIFICATION	EMBANKMENT OF SLOPE	
	COMPACTED FILL	CUT
STABLE ROCK (A)	3 : 3	8 : 1
SAND (A)	1 : 2	1 : 2
SILT (P)	1 : 4	1 : 4
FIRM CLAY	1 : 2	1 : 1
SOFT CLAY	NOT SUITABLE	2 : 3
SOFT SOILS (P)	NOT SUITABLE	NOT SUITABLE

MASONRY

- ALL MASONRY TO BE CONSTRUCTED IN ACCORDANCE WITH AS3700
- EXTERNAL WALLS TO BE 110mm BRICKWORK UNLESS NOTED OTHERWISE
- MORTAR MIXED @ 1:1:6 CEMENT:LIME:SAND UNLESS STATED OTHERWISE BY ENGINEER
- DAMP-PROOF COURSE IN ALL PERIMETER WALLS CUT INTO EXTERNAL WALLS BELOW FLOOR LEVEL WITH WEEP HOLES @ 1200 CTRS IN ACCORDANCE WITH AS2904
- VERTICAL ARTICULATION JOINTS TO BE PROVIDED @ 6m MAX. CTRS FOR UNREINFORCED MASONARY WALLS EXCEPT WHERE BUILT ON CLASS A OR S SOIL AND SPACED AS PER AS3700 SECTION 12.6.4. WILSON HOMES REQUEST THAT @ 5M CTRS.
- WHERE NECESSARY, STEEL LINTELS ARE TO BE PROVIDED IN ACCORDANCE WITH AS4100 AND AS3700a

TIMBER FRAMING

- ALL WORK TO BE CARRIED OUT IN ACCORDANCE WITH THE CURRENT NCC
- ALL TIMBER FRAMING TO BE CARRIED OUT IN ACCORDANCE WITH AS1684
- MGP10 PINE FRAMING OR F17 SOLID AND FINGER JOINED FRAMING TO ALL STRUCTURAL COMPONENTS. 90 x 35mm FRAMING TO INTERNAL AND EXTERNAL WALLS. TIMBER COMPOSITE ENGINEERED ROOF TRUSSES WITH HARDWOOD AND MGP COMPONENTS
- GALVANISED WALL TIES TO MASONRY @ 450 CTRS HORIZONTALLY AND 600 CTRS VERTICALLY, WITH SPACING REDUCED BY 50% AROUND OPENINGS

BRACING / LINTELS

- WALL BRACING AS PER AS1684-2 2021 AND AS1170 WIND LOADS
- WALL BRACING AS SHOWN ON PLAN IS A MINIMUM ONLY. BUILDER TO PROVIDE ADDITIONAL BRACING TO SUIT THE CONSTRUCTION OF WALL FRAMES IN ACCORDANCE WITH GOOD BUILDING PRACTICE.
- PLYWOOD BRACING IN ACCORDANCE WITH AS1684 TABLE 8.18 (H) METHOD B. 900 WIDE SHEET PLY BRACING PANELS (6mm THICK F11 OR 4mm THICK F14) TO BE FIXED TO STUD FRAME WITH 2.8mm DIA x 30mm LONG MIN. FLAT HEAD NAILS.
- 65 x 19mm HW DIAGONAL TIMBER BRACING CHECKED INTO STUDS AND FIXED IN ACCORDANCE WITH AS1684

TIMBER LINTELS FOR SINGLE (OR UPPER STORY) TO BE F17 HARDWOOD AS FOLLOWS:

0 - 15001500 - 24002400 - 2700

120 x 35140 x 35190 x 35

TIEDOWN AND FIXING CONNECTIONS TO COMPLY WITH AS1684

STEEL LINTELS FOR SINGLE (OR UPPER STOREY) TO BE AS FOLLOWS:

0 - 27002700 - 32003200 - 4000

90 x 90 x 6 EA100 x 100 x 8 EA150 x 90 x 8 EA

*LINTELS REQUIRE 150mm BEARING EITHER SIDE OF OPENING

ALL LINTEL SIZES SHOWN ARE SUBJECT TO ENGINEERS DETAILS

CONCRETE

- CONCRETE FOOTING AND SLABS TO BE IN ACCORDANCE WITH AS2870
- CONCRETE TO BE MANUFACTURED TO COMPLY WITH AS3600 AND:
 - HAVE A STRENGTH @ 28 DAYS OF NOT LESS THAN 25MpA (N25 GRADE)
 - HAVE A 20mm NOMINAL AGGREGATE SIZE
 - HAVE A NOMINAL 80mm SLUMP
- CONCRETE SLAB TO BE LAID OVER 0.2mm POLYTHENE MEMBRANE, 50mm WELL BEDDED SAND AND MINIMUM COMPACTED FCR (20mm)
- SLAB THICKNESS AND REINFORCEMENT TO BE AS PER ENGINEERS DESIGN

WINDOWS

- WINDOWS TO BE ALUMINIUM FRAMED SLIDING UNLESS NOTED OTHERWISE
- ALL WINDOWS TO BE FABRICATED AND INSTALLED IN ACCORDANCE WITH AS1288 AND AS2047 TO SPECIFIC WIND SPEED AS PER ENGINEERS REPORT
- ALL OPENING WINDOWS TO COMPLY WITH NCC 8 REQUIREMENTS
- AS PER NCC 11.3.6 ALL BEDROOM WINDOWS WHERE THE LOWEST OPENABLE PORTION OF THE WINDOW IS WITHIN 1.7m OF FFL AND THE FFL IS 2m OR MORE ABOVE NGL, REQUIRE A PERMANANTLY FIXED DEVICE RESTRICTING ANY OPENINGS OF THE WINDOW OR SCREEN SO THAT A 125mm SPHERE CANNOT PASS THROUGH; AND RESISTING OUTWARDS HORIZONTAL ACTION OF 250N AGAINST THE WINDOW. WHERE THE DEVICE OR SCREEN CAN BE REMOVED, UNLOCKED OR OVER-RIDDEN, THE DEVICE OR SCREEN MUST HAVE A CHILD RESISTANT RELEASE MECHANISM INSTALLED AND BARRIER BELOW THE WINDOW THAT IS 865mm HIGH ABOVE FFL AND RESTRICTS ANY OPENING WITHIN THE BARRIER SO THAT A 125mm SPHERE CANNOT PASS THROUGH, AND HAS NO HORIZONTAL OR NEAR HORIZONTAL ELEMENTS BETWEEN 150mm AND 760mm FROM FFL.
- GLAZING INSTALLED IN AREAS WITH HIGH POTENTIAL FOR HUMAN IMPACT TO COMPLY WITH NCC PART 8.4

DRAINAGE / WATER

- DRAINAGE TO BE DESIGNED AND CONSTRUCTED IN ACCORDANCE WITH AS3500 AND LOCAL AUTHORITY
- STORMWATER PIPES TO BE UPVC CLASS HD
- SEWER PIPES TO BE UPVC CLASS SH
- PROVIDE Ø20mm K2 POLYETHYLENE WATER RETICULATION
- TYPE B STOP VALVE TO BE LOCATED ADJACENT TO ENTRY
- BACKFILL ALL TRENCHES BENEATH VEHICLE PAVEMENT AND SLABS ON GRADE TO FULL DEPTH WITH 20 FCR
- PROVIDE OVERFLOW RELIEF GULLY WITH TAP OVER. INVERT LEVEL TO BE 150 MIN. BELOW LOWEST SANITARY DRAINAGE POINT.
- CUT AND BATTER ARE INDICATIVE. BATTER TO COMPLY WITH CURRENT NCC TABLE 3.1.1.1
- AG DRAIN REQUIRED AROUND PERIMETER OF DWELLING FOR ALL CLASS M, H, E SITES. LOCATE AG DRAIN NOT CLOSER THAN 1.5m FROM FOOTINGS IN ACCORDANCE WITH AS2870 SECTION 5.6
- PROVIDE SURFACE DRAINAGE IN ACCORDANCE WITH AS2870 SECTION 5.6.3
- PROVIDE FLEXIBLE JOINTS IN ALL DRAINAGE EMERGING FROM UNDERNEATH OR ATTACHED TO BUILDING IN ACCORDANCE WITH AS2870 SECTION 5.6.4 FOR ALL CLASS H AND E SITES. REFER TO GEOTECH FOR FURTHER INFORMATION
- DOWNPIPES AND GUTTERS DESIGNED IN ACCORDANCE WITH AS/NZS 3500.3

STAIRCASES / BALUSTRADES / HANDRAILS

STAIR TREADS240mm MIN. - 355mm MAX.

STAIR RISERS115mm MIN. - 190mm MAX.

- HANDRAIL REQUIRED WHERE CHANGE OF LEVEL BETWEEN FLOOR / LANDINGS > 1m AS PER CURRENT NCC 11.3.5
- NO GAPS IN STAIRCASES OR BALUSTRADE TO BE GREATER THAN 125mm
- BALUSTRADE REQUIRED WHERE LEVEL OF LANDING OR DECK IS GREATER THAN 1000mm ABOVE ADJACENT GROUND LEVEL
- BALUSTRADE TO BE MINIMUM 1000mm ABOVE FFL (INCLUDING ANY FLOOR COVERINGS)
- DOORS OPENING OUTWARDS EXTERNALLY MUST OPEN TO A LANDING (MIN. 750mm WIDE) WHERE THE DIFFERENCE IN LEVELS IS GREATER THAN 570mm
- NON-SLIP TREADS TO ALL TREADS AND TO COMPLY WITH NCC 11.2.4
- WHERE LANDINGS ARE NOT NOMINATED TO EXTERNAL DOORS, OPERATING DOOR LEAFS ARE TO BE SCREWED FIXED SHUT, OR PROVIDED WITH A FORMED FCR LANDING NOMINALLY 180mm BELOW FLOOR LEVEL.
- GLAZED BALUSTRADE AND HANDRAILS TO COMPLY WITH NCC PART 8.4, 11.3 AND AS1288 REQUIREMENTS

CONDENSATION

- WHERE RAKED CEILINGS EXIST, IT IS HIGHLY RECCOMENDED THAT SUITABLE SPACING BETWEEN SARKING AND BULK INSULATION EXISTS. (NO CONTACT BETWEEN PRODUCTS). THE BUILDER IS TO ENSURE ADEQUATE SIZED TIMBER IS USED TO ENSURE THIS SEPARATION IS PROVIDED.
- IN STANDARD ROOF SPACES, IT IS HIGHLY RECOMMENDED TO PROVIDE SEPARATION BETWEEN SARKING AND CEILING INSULATION AROUND THE BUILDING PERIMETER, TO ENSURE AIRFLOW FROM EAVE VENTS IS MAINTAINED
- IT IS HIGHLY RECOMMENDED THAT ALL LIGHTWEIGHT CLADDING IS BATTENED OUT FROM STUDS (METAL / FC SHEET / TIMBER)

WOOD HEATERS

- ALL WOOD HEATERS ARE TO COMPLY WITH MANUFACTURERS SPECIFICATION AND NCC PART 12.4

FIRE SAFETY

- SMOKE ALARMS TO BE MAINS POWERED AND INSTALLED AS PER AS3786. LOCATIONS AS PER NCC 9.5.
- SMOKE ALARMS TO BE INTERCONNECTED WHERE THERE IS MORE THAN ONE ALARM
- INSTALLATION OF WOOD HEATERS TO COMPLY WITH AS2918. PROVIDE LOCAL AUTHORITIES WITH INSULATION AND COMPLIANCE CERTIFICATES

ROOFING

- ROOF TO BE COLORBOND 'CUSTOM ORB' METALDECK UNLESS NOTED OTHERWISE. PROVIDED AND INSTALLED IN ACCORDANCE WITH AS1562.1 (IF TILED REFER TO AS2050)
- PREFABRICATED ROOF TRUSSES TO BE SUPPLIED AND INSTALLED TO MANUFACTURERS SPECIFICATIONS. TRUSS MANUFACTURER TO CONFIRM LINTEL SIZES.

ELECTRICAL

- EXHAUST FAN TO COMPLY WITH CURRENT NCC PART 10.6.2 SECTION C
- EXHAUST FANS TO BE SEALED AND DUCTED TO OUTSIDE OF DWELLING IN ACCORDANCE WITH NCC VOLUME 2, PARTS 10.8.2 AND 10.8.3
- IF VENTING OCCURS DIRECTLY THROUGH WALLS/ROOF ADJACENT TO FAN, THEN UNIT REQUIRES SELF CLOSING BAFFLES TO BE CLASSIFIED AS A SEALED UNIT
- ELECTRICIAN IS TO ENSURE THAT ALL GPO'S IN WET AREAS MEET ALL STANDARD AND CODE REQUIREMENTS - ALL GPO'S TO BE 300mm FROM FFL UNLESS NOTED OTHERWISE

WET AREAS

- WALLS TO WET AREAS TO BE FINISHED WITH WET AREA PLASTERBOARD
- COMPLIANCE WITH NCC PART 10.2 AND AS3740
- ALL UNENCLOSED SHOWERS ABOVE BATHS TO HAVE MINIMUM 900mm SHOWER SCREEN OR FLOORWASTE WITHIN 1500mm OF SHOWER CONNECTION AS PER AS3740

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Requirements for Building In Bushfire Hazard Areas
Building Act 2016
Directors Determination - Bushfire Hazard Areas
V1.1, dated 08 April 2021

Deemed-to-Satisfy Requirements (Part 2.3)

2.3.1 Design and construction
(1) Building work in a bushfire-prone area must be designed and constructed in accordance with either: -
(a) AS 3959-2018; or
(b) Standard for Steel Framed Construction in Bushfire Areas published by the National Association of Steel Framed Housing Inc. (NASH), as appropriate for a BAL determined for that site using table 2.6 of AS 3959.
(2) Subclause (1)(a) is only applicable to the following:
(a) a Class 1, 2 or 3 building; or
(b) a Class 10a building or deck associated with a Class 1, 2 or 3 building.
(3) Subclause (1)(b) is only applicable to the following:
(a) a Class 1 building; or
(b) a Class 10a building or deck associated with a Class 1 building.
(4) Despite subsection (1) permissible, variations from requirements specified in 1(a) and 1(b) are as specified in Table 1.
(5) Despite subsections (1) and (4), performance requirements for buildings subject to BAL 40 or BAL Flame Zone (BAL-FZ) are not satisfied by compliance with subsections (1) or (4).

2.3.2 Property Access
(1) A new building in a bushfire-prone area must be provided with property access to the building area and the firefighting water point, accessible by a carriageway, designed and constructed as specified in subclause (4).
(2) For an addition or alteration to an existing building in a bushfire-prone area, if there is no property access available property access must be provided to the building area and the firefighting water point accessible by a carriageway as specified in subclause (4).
(3) An addition or alteration to an existing building in a bushfire-prone area must not restrict any existing property access to the building area or to water supply for firefighting.
(4) Vehicular access from a public road to a building must:
(a) comply with the property access requirements specified in Table 2;
(b) include access from a public road to within 90 metres of the furthest part of the building measured as a hose lay; and
(c) include access to the hardstand area for the firefighting water point.

2.3.3 Water Supply for Fire fighting
(1) A new building constructed in a bushfire-prone area, must be provided with a water supply dedicated for fire fighting purposes as specified in Table 3A or Table 3B.
(2) For an addition or alteration to an existing building in a bushfire-prone area, if there is no water supply for firefighting available the building must be provided with a water supply dedicated for firefighting purposes which complies with the requirements specified in Table 3A or Table 3B.

2.3.4 Hazard Management Areas
(1) A new building, and an existing building in the case of an addition or alteration to a building, in a bushfire-prone area must be provided with a hazard management area.
(2) The hazard management area must comply with the requirements specified in Table 4.
(3) The hazard management area for a particular BAL must have the minimum dimensions required for the separation distances specified for that BAL in Table 2.6 of AS 3959.
(4) The hazard management area must be established and maintained such that the fuels are reduced sufficiently, and other hazards are removed such that the fuels and other hazards do not significantly contribute to the bushfire attack.
2.3.5 Bushfire emergency plan
(1) An emergency plan must be provided for:
(a) a new building;
(b) an existing building in the case of an addition or alteration to a building;
(c) an existing building in the case of a change of building class;
(d) a building associated with the use, handling, generation or storage of a hazardous chemical or explosive; in a bushfire-prone area.
(2) A bushfire emergency plan must comply with the requirements specified in Table 5.

7. Interpretation of Tables
(1) For the purposes of the deemed-to-satisfy provisions in clause 2.3 of this Determination, Tables 1, 2, 3A, 3B, 4, and 5 must be complied with in the following way:
(a) for a particular element specified in column 1, the corresponding requirement specified in column 2 must be complied with.

Table 1 - Construction Requirements & Construction Variations

Column 1		Column 2
ELEMENT		REQUIREMENT
A.	Straw Bale Construction	May be used in exposures up to and including BAL 19.
B.	Shielding provisions under Section 3.5 of AS3959-2018	To reduce construction requirements due to shielding, building plans must include suitable detailed elevations or plans that demonstrate that the requirements of Section 3.5 of the Standard can be met.
		Comment: Application of Section 3.5 of the Standard cannot result in and assessment of BAL-LOW.

Table 2 - Requirements for Property Access

Column 1		Column 2
ELEMENT		REQUIREMENT
A.	Property access length is less than 30 metres; or access is not for a fire appliance to access a water connection point.	There are no specified design and construction requirements.
B.	Property access length is 30 metres or greater; or access for a fire appliance to a water connection point.	The following design and construction requirements apply to property access: (1) All-weather construction; (2) Load capacity of at least 20 tonnes, including for bridges and culverts; (3) Minimum carriageway widths of 4 metres; (4) Minimum vertical clearance of 4 metres; (5) Minimum horizontal clearance of 0.5 metres from the edge of the carriageway; (6) Cross falls of less than 3° (1:20 or 5%); (7) Dips less than 7° (1:8 or 12.5%) entry and exit angle; (8) Curves with a minimum inner radius of 10 metres; (9) Maximum gradient of 15° (1:3.5 or 28%) for sealed roads, and 10° (1:5.5 or 18%) for unsealed roads; and (10) Terminate with a turning area for fire appliances provided by one of the following: (a) A turning circle with a minimum inner radius of 10 metres; (b) A property access encircling the building; or (c) A hammerhead "T" or "Y" turning head 4 metres wide and 8 metres long.
C.	Property access length is 200 metres or greater.	The following design and construction requirements apply to property access: (1) The Requirements for B above; and (2) Passing bays of 2 metres additional carriageway width and 20 metres length provided every 200 metres.
D.	Property access length is greater than 30 metres, and access is provided to 3 or more properties.	The following design and construction requirements apply to property access: (1) Complies with Requirements for B above; and (2) Passing bays of 2 metres additional carriageway width and 20 metres length must be provided every 100 metres.

Table 3A - Reticulated Water Supply for Firefighting

Column 1		Column 2
ELEMENT		REQUIREMENT
A.	Distance between building area to be protected and water supply	The following requirements apply: (1) The building area to be protected must be located within 120 metres of a fire hydrant; and (2) The distance must be measured as a hose lay, between the water connection point and the furthest part of the building area.
B.	Design criteria for fire hydrants	The following requirements apply: (1) Fire hydrant system must be designed and constructed in accordance with TasWater Supplement to Water Supply Code of Australia WSA 03 - 2011-3.1 MRWA Edition 2.0; and (2) Fire hydrants are not installed in parking areas.
C.	Hardstand	A hardstand area for fire appliances must be provided: (1) no more than three metres from the hydrant, measured as a hose lay; (2) No closer than six metres from the building area to be protected; (3) With a minimum width of three metres constructed to the same standard as the carriageway; and (4) Connected to the property access by a carriageway equivalent to the standard of the property access

Table 3B - Static Water Supply for Firefighting

Column 1		Column 2
ELEMENT		REQUIREMENT
A.	Distance between building area to be protected and water supply	The following requirements apply: (a) The building area to be protected must be located within 90 metres of the water connection point of a static water supply; and (b) The distance must be measured as a hose lay, between the water connection point and the furthest part of the building area.
B.	Static Water Supplies	A static water supply: (a) May have a remotely located offtake connected to the static water supply; (b) May be a supply for combined use (fire fighting and other uses) but the specified minimum quantity of fire fighting water must be available at all times; (c) Must be a minimum of 10,000 litres per building area to be protected. This volume of water must not be used for any other purpose including fire fighting sprinkler or spray systems; (d) Must be metal, concrete or lagged by non-combustible materials if above ground; and (e) If a tank can be located so it is shielded in all directions in compliance with Section 3.5 of AS 3959-2018, the tank may be constructed of any material provided that the lowest 400 mm of the tank exterior is protected by: (i) metal; (ii) non-combustible material; or (iii) fibre-cement a minimum of 6 mm thickness.
C.	Fittings, pipework and accessories (including stands and tank supports)	Fittings and pipework associated with a water connection point for a static water supply must: (a) Have a minimum nominal internal diameter of 50mm; (b) Be fitted with a valve with a minimum nominal internal diameter of 50mm; (c) Be metal or lagged by non-combustible materials if above ground; (d) Where buried, have a minimum depth of 300mm (e) Provide a DIN or NEN standard forged Storz 65 mm coupling fitted with a suction washer for connection to fire fighting equipment; (f) Ensure the coupling is accessible and available for connection at all times; (g) Ensure the coupling is fitted with a blank cap and securing chain (minimum 220 mm length); (h) Ensure underground tanks have either an opening at the top of not less than 250 mm diameter or a coupling compliant with this Table; and (i) Where a remote offtake is installed, ensure the offtake is in a position that is: (i) Visible; (ii) Accessible to allow connection by fire fighting equipment; (iii) At a working height of 450 - 600mm above ground level; and (iv) Protected from possible damage, including damage by vehicles.
D.	Signage for static water connections	(1) The water connection point for a static water supply must be identified by a sign permanently fixed to the exterior of the assembly in a visible location. The sign must: (a) comply with water tank signage requirements within AS 2304; or (b) comply with the TFS Water Supply Signage Guideline.
E.	Hardstand	A hardstand area for fire appliances must be provided: (a) No more than three metres from the water connection point, measured as a hose lay (including the minimum water level in dams, swimming pools and the like); (b) No closer than six metres from the building area to be protected; (c) With a minimum width of three metres constructed to the same standard as the carriageway; and (d) Connected to the property access by a carriageway equivalent to the standard of the property access.

Table 4 - Requirements for Hazard Management Area

Column 1		Column 2
ELEMENT		REQUIREMENT
A.	Hazard managements areas for new buildings on lots provided with a BAL at the time of subdivision.	A new building must: (a) Be located on the lot so as to be provided with a HMA no smaller than the required separation distances for the BAL determined at the time of the subdivision; and (b) Have a HMA established in accordance with a certified bushfire hazard management plan.
B.	Hazard management areas for new buildings on lots not provided with a BAL at the time of sub division.	A new building must: (a) Be located on the lot so as to be provided with a HMA no smaller than the separation distances required for BAL 29; and (b) Have an HMA established in accordance with a certified bushfire hazard management plan.
C.	Hazard management areas for alterations or additions to buildings.	An alteration or addition to a building must: (a) Be located on the lot so as to be provided with a HMA which: (i) Has the separation distances required for the BAL assessed for the construction of the existing building; or (ii) In the case of a building without an existing BAL assessment, is no smaller than the separation distances required for BAL 29; and (b) Have an HMA established in accordance with a certified bushfire hazard management plan.
D.	Hazard management areas for new buildings and additions and alterations to buildings classified as an accommodation building BCA Class 1b, BCA Class 2, or BCA Class 3, other than communal residence for persons with a disability, a respite centre or a residential aged care facility or similar.	A new building or an alteration or addition must: (a) be located on the lot so as to be provided with HMAs no smaller than the separation distances required for BAL 12.5; and (b) have a HMA established in accordance with a certified bushfire hazard management plan.
E.	Hazard management areas for new buildings and additions and alterations to existing buildings classified as vulnerable use as defined in the relevant planning scheme.	A new building or an addition or alteration including change of use must: (a) be located on the lot so as to be provided with HMAs no smaller than the separation distances required for BAL 12.5; and (b) have a HMA established in accordance with a certified bushfire hazard management plan.
F.	Hazard management areas for new buildings or additions and alterations to buildings associated with the use, handling, generation or storage of a hazardous chemical or explosive.	A new building or an alteration or addition, including change of use, for a building determined as a hazardous use must: (a) Be located on the lot so as to be provided with a HMA no smaller than the required separation distances for the BAL determined in the certified bushfire hazard management plan; and (b) Have a HMA established in accordance with a certified bushfire hazard management plan.

Table 5 - Requirements for Emergency Planning

Column 1		Column 2
ELEMENT		REQUIREMENT
A.	Bushfire emergency plans	An emergency plan must be developed for the site which is: (a) Consistent with TFS Bushfire Emergency Planning Guidelines; and (b) Approved by TFS or a person accredited by the TFS.

REFER TO SHEET 1 (COVER SHEET) FOR ALL BUILDING INFORMATION REGARDING:
- SUSTAINABILITY REQUIREMENTS
- SITE CLASSIFICATION
- GENERAL BUILDING INFORMATION

BAL-12.5 BUSHFIRE REQUIREMENTS
SEE SHEET 1 (COVER SHEET) FOR DETAILS

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	2 PLANS UPDATE	MLG 24/10/2025	LOT / SECTION / CT: 99 / - / 187077	SHEET TITLE: BUILDING ACT BUSHFIRE HAZARD AREAS	SHEET No.: 21 / 23	714497
	3 PRELIM PLANS - INITIAL ISSUE	KPH 06/11/2025	COUNCIL: WEST TAMAR		SCALES:	

SUBJECT TO NCC 2022
(1 MAY 2023)
WATERPROOFING & PLUMBING

PLAN ACCEPTANCE BY OWNER

SIGNATURE: DATE:

SIGNATURE: DATE:

PLEASE NOTE THAT VARIATIONS WILL NOT BE ACCEPTED AFTER THIS PLAN ACCEPTANCE HAS BEEN SIGNED

AS3959 (2018)

All specifications are per AS3959 (2018) and Wilson Homes request. Other materials and options may be available, refer to AS3959 for full list of compliant materials.

5.1 GENERAL

A building assessed in Section 2 as being BAL -12.5 shall comply with Section 3 and Clauses 5.2 to 5.8.

Any element of construction or system that satisfies the test criteria of AS 1530.8.1 may be used in lieu of the applicable requirements contained in Clauses 5.2 to 5.8 (see Clause 3.8).

NOTE: BAL -12.5 is primarily concerned with protection from ember attack, and radiant heat up to and including 29kW/m² where the site is less than 100 m from the source of the bushfire attack.

5.2 SUBFLOOR SUPPORTS

This Standard does not provide construction requirements for subfloor supports where the subfloor space is enclosed with -
(a) a wall that complies with Clause 5.4; OR
(b) a mesh or perforated sheet with a maximum aperture of 2mm, made of corrosion resistant steel, bronze or aluminium; OR
(c) a combination of Items (a) and (b).

NOTE: This requirement applies to the subject building only and not to verandas, decks, steps, ramps and landings (see Clause 5.7)

C5.2 Combustible materials stored in the subfloor space may be ignited by embers and cause and impact to the building.

5.3 FLOORS

5.3.1 GENERAL

This Standard does not provide construction requirements for concrete slabs on the ground.

5.3.2 ELEVATED FLOORS

5.3.2.1 ENCLOSED SUBFLOOR SPACE

This standard does not provide consturction requirements for elevated floors, including bearers and joists and flooring, where the subfloor space is enclosed with

- (a) a wall that complies with Clause 5.4; OR
- (b) a mesh perforated sheet with a maximum aperture of 2mm, made of corrosion resistant steel, bronze or aluminium; OR
- (c) a combination of Items (a) and (b) above.

5.3.2.2 UNENCLOSED SUBFLOOR SPACE

Where the subfloor space is unenclosed, the bearers, joists and flooring, less than 400mm above finished ground level, shall be one of the following -

(a) Materials that comply with the following:

- (i) Bearers and joists shall be -
 - (A) non-combustible; OR
 - (B) bushfire-resisting timber (see Appendix F); OR
 - (C) a combination of Items (A) and (B) above.
- (ii) Flooring shall be -
 - (A) non-combustible; OR
 - (B) bushfire-resisting timber (see Appendix F); OR
 - (C) timber (other than bushfire-resisting timber),

particleboard or plywood flooring where the underside is lined with sarking-type material or mineral wool insulation; OR

- (D) a combination of any Items (A), (B) or (C) above.

OR

(b) A system complying with AS1530.8.1

This standard does not provide construction requirements for elements of elevated floors, including bearers, joists and flooring, if the underside of the element is 400mm or more above finished ground level.

5.4.1 WALLS

The exposed components of an external wall that is less than 400 mm from the ground or less than 400 mm above decks, carport roofs, awnings and similar fittings having an angle of less than 18 degrees to the horizontal and extending more than 110 mm in width from the wall (see Figure D3, Appendix D) shall be:

(a) Non-combustible material.
NOTE: Examples include, but are not limited to, the following (with a minimum of 90 mm inthickness):

- (i) Full masonry or masonry veneer walls with an outer leaf of clay, concrete, calcium silicate or natural stone.
- (ii) Precast or in situ walls of concrete or aerated concrete.
- (iii) Earth wall including mud brick. OR

(b) Timber logs of a species with a density of 680kg/m³ or greater at a 12 percent moisture content; of a minimum nominal overall thickness of 90mm and a minimum thickness of 70mm (see Clause 3.11); and gauge planed. OR

(c) Cladding that is fixed externally to a timber-framed or a steel-framed wall that is sarked on the outside of the frame and is -

- (i) non-combustible material; OR
- (ii) fibre cement a minimum of 6mm in thickness; OR
- (iii) bushfire-resisting timber (see Appendix F); OR
- (iv) a timber species as specified in Paragraph E1, Appendix E; pr
- (v) a combination of any of Items (i), (ii), (iii) or (iv) above. OR
- (d) A combination of any items (a), (b) or (c) above.

5.4.2 JOINTS

All joints in the external surface material of walls shall be covered, sealed, overlapped, backed or butt-jointed.

5.4.3 VENTS AND WEEPHOLES

Except for exclusions provided in Clause 3.6, vents and weepholes in external walls shall be screened with a mesh made of corrosion-resistant steel, bronze or aluminium.

5.5.1 BUSHFIRE SHUTTERS

Where fitted, bushfire shutters shall comply with Clause 3.7 and be made from -

- (a) non-combustible material; OR
- (b) a timber species as specified in Paragraph E1, Appendix E; OR
- (c) bushfire-resisting timber (see Appendix F); OR
- (d) a combination of Items (a), (b) and (c) above.

5.5.2 SCREENS FOR WINDOWS AND DOORS

Where fitted, screens for windows and doors shall have a mesh or perforated sheet made of corrosion-resistant steel, bronze or aluminium.

The frame supporting the mesh or perforated sheet shall be made from -

- (a) metal; OR
- (b) bushfire-resisting timber (see Appendix F);
- (c) a timber species as specified in Paragraph E2, Appendix E.

5.5.3 WINDOWS AND SIDELIGHTS

Window assemblies shall:

(a) be completely protected by a bushfire shutter that complies with Clause 3.7 and clause 5.5.1; OR

(b) Be completely protected externally by screens that conform with Clause 3.6 and Clause 5.5.2

(c) Conform with the following:

- (i) Frame material Where window assemblies less than 400mm from the ground or less than 400mm above decks, carport roofs, awnings and similar elements or fittings having and angle less than 18 degrees to the horizontal and extending more than 110mm in width from the window frame (see Figure D3, Appendix D), window frames and window joinery shall be made from:
 - (A) Bushfire-resisting timber (see Appendix F) OR
 - (B) A timber species as specified in Paragraph E2, Appendix F); OR
 - (C) Metal. OR
 - (D) Metal-reinforced uPVC. The reinforcing members shall be made from aluminium, stainless steel, or corrosion-resistant steel.

There are no specific restrictions on frame material for all other windows.

- (i) Hardware There are no specific restrictions on hardware for windows.
- (ii) Glazing Where glazing is less than 400mm from the ground or less than 400mm above decks, carport roofs, awnings and similar elements or fittings having and angle less than 18 degrees to the horizontal and extending more than 110mm in width from the window frame (see Figure D3, Appendix D), this glazing shall be Grade A safety glass a minimum of 4mm in thickness or glass blocks with no restriction on glazing methods.

NOTE: Where double-glazed assemblies are used above, the requirements apply to the external pane of the glazed assembly only. For all other glazing, annealed glass may be used in accordance with AS 1288.

- (iv) Seals and weather strips There are no specific requirements for seals and weather strips at this BAL level.

- (iv) Screens The openable portions of windows shall be screened internally or externally with screens that conform with Clause 3.6 and Clause 5.5.2.

C5.5.3 For Clause 5.5.3(c), screening of the openable portions of all windows is required in all BAL's to prevent the entry of embers to the building when the window is open.

For Clause 5.5.3 (c)(v), screening of the openable and fixed portions of some windows is required to reduce the effects of radiant heat on some tyes of glass. If the screening is required to reduce the effects of radiant heat on glass, and has to be externally fixed.

For Clause 5.5.3 (c)(v), if the screening is required only to prevent the entry of embers, the screening may be fitted externally or internally.

5.5.4 DOORS SIDE-HUNG EXTERNAL DOORS (including French Doors, Panel Fold and Bi-fold Doors)

Side-hung external doors, including French doors, panel fold and bi-fold doors, shall -

(a) Be protected by bushfire shutters that comply with Clause 3.7 and Clause 5.5.1.

OR

(b) Be protected externally by screens that comply with Clause 3.6 and Clause 5.5.2.

OR

(c) conform with the following:

- (i) Door panel material Materials shall be -
 - (A) non combustible; OR
 - (B) solid timber, laminated timber or reconstituted timber door, having a minimum thickness of 35mm for the first 400mm above the threshold; OR
 - (C) hollow core, solid timber, laminated timber or reconstituted timber with a non-combustible kickplate on the outside for the first 400mm above the threshold; OR
 - (D) hollow core, solid timber, laminated timber or reconstituted timber protected externally by a screen that complies with Clause 5.5.2; OR
 - (E) for fully framed glazed door panels, the framing is made from metal or bushfire resisting timber (see Appendix F), or a timber species as specified in Paragraph E2, Appendix E or uPVC.

- (ii) Door frame material Door frames shall be made from:
 - (A) Bushfire-resisting timber (see Appendix F). OR
 - (B) a timber species as specified in Paragraph E2 of Appendix E;

OR

- (C) Metal. OR
- (D) Metal-reinforced PVC-U. The reinforcing members shall be made from aluminium, stainless steel, or corrosion-resistant steel.

(iii) Hardware There are no specific requirements for hardwarea at this BAL level.

- (iv) Glazing the glazing shall be Grade A safety glass a minimum of 4mm in thickness, or glass blocks with no restriction on glazing methods. NOTE: Where double glazed units are used the above requirements apply to the external face of the window assembly only.

(v) Seals and weather strips Weather strips, draft excluders or draft seals shall be installed.

(vi) Screens There are no specific requirements for hardwarea at this BAL level.

(vii) Doors shall be tight-fitting to the door frame and to an abutting door, if applicable.

5.5.5 DOORS-SLIDING DOORS

Sliding doors shall:

(a) Be protected by bushfire shutters that comply with Clause 3.7 and Clause 5.5.1.

OR

(b) Be protected externally by screens that comply with Clause 3.6 and Clause 5.5.2.

OR

(c) conform with the following:

- (i) Frame material The material for door frames, including fully framed glazed doors, shall be -
 - (A) Bushfire-resisting timber (see Appendix F). OR
 - (B) a timber species as specified in Paragraph E2 of Appendix E; OR
 - (C) Metal. OR
 - (D) Metal-reinforced uPVC. The reinforcing members shall be made from aluminium, stainless steel, or corrosion-resistant steel.

(ii) Hardware There are no specific requirements for hardwarea at this BAL level.

- (iii) Glazing Where doors incorporate glazing, the glazing shall be Grade A safety glass a minimum of 4mm in thickness,
- (iv) Seals and weather strips There are no specific requirements for hardwarea at this BAL level.

(v) Screens There are no specific requirements for hardwarea at this BAL level.

(vi) Sliding panels Sliding panels shall be tight-fitting in the frames.

5.5.6 DOORS-VEHICLE ACCESS DOORS (GARAGE DOORS)

The following apply to vehicle access doors:

(a) The lower portion of a vehicle access door that is within 400mm of the ground when the door is closed (see Figure D4, Appendix D) shall be made from -

- (i) non combustible material; OR
- (ii) bushfire-resisting timber (see Appendix F); OR
- (iii) fibre- cement sheet, a minimum of 6mm in thickness; OR
- (iv) a timber species as specified in Paragraph E1, Appendix E; OR
- (iv) a combination of any Items (i), (iii) or (iv) above.

(b) All vehicle access doors doors shall be fitted with suitable weather strips, draught seals or brushses. Door assemblies fitted with guide tracks do not need edge gap protection.

NOTES:

- 1 Refer to AS/NZS 4505 for door tyles.
- 2 Gaps of door edges or building elements should be protected as per Section 3.
- C5.5.6(b) These guide tracks do not provide a direct passage for embers into the building.
- (c) Vehicle access doors with ventilation slots shall be protected in accordance with Clause 3.6.

5.6.1 ROOFS - GENERAL

The following apply to all types of roofs and roofing systems:

(a) Roof tiles, roof sheets and roof-covering accessories shall be non-combustible.

(b) The roof/wall junction shall be sealed, or otherwise protected in accordance with Clause 3.6.

(c) Roof ventilation openings, such as gable and roof vents, shall be fitted with ember guards made of non-combustible material or a mesh or perforated sheet conforming with Clause 3.6 and made of corrosion-resistant steel, bronze or aluminium.

(d) Only evaporative coolers manufactured in accordance with AS/NZS 60335.2.98 shall be used. Evaporative coolers with an internal damper to prevent the entry of embers into the roof space need to be screened externally.

5.6.2 TILED ROOFS

Tiled roofs shall be fully sarked. The sarking shall -

- (a) be located on top of the roof framing, except that the roof battens may be fixed above the sarking;
- (b) cover the entire roof area including ridges and hips; and
- (c) extend into gutters and valleys.

5.6.3 SHEET ROOFS

Sheet roofs shall—

- (a) be fully sarked in accordance with Clause 5.6.2, except that foil-backed insulation blankets may be installed over the battens; and
- (b) have any gaps sealed at the fascia or wall line and at valleys, hips and ridges by -

(i) a mesh or perforated sheet that conforms with Clause 3.6 and that is made of corrosion-resistant steel, bronze or aluminium; OR

(ii) mineral wool; OR

(iii) other non-combustible material; OR

(iv) a combination of any of Items (i), (ii) or (iii) above.

C5.6.3 - Sarking is used as a secondary form of ember protection for the roof space to account for minor gaps that may develop in sheet roofing.

5.6.4 VERANDA, CARPORT AND AWNING ROOFS

The following apply to veranda, carport and awning roofs:

(a) A veranda, carport or awning roof forming part of the main roof space [see Figure D1(a), Appendix D] shall meet all the requirements for the main roof, as specified in Clauses 5.6.1, to 5.6.6.

(b) A veranda, carport or awning roof separated from the main roof space by an external wall [see Figures D1(b) and D1(c), Appendix D] complying with Clause 5.4 shall have a non-combustible roof covering, except where the roof covering is a translucent or transparent material.

NOTE: There is no requirement to line the inderside of a veranda, carport or awning roof that is separated from the main roof space

5.6.5 ROOF PENETRATIONS

The following apply to roof penetrations:

(a) Roof penetrations, including roof lights, roof ventilators, roof-mounted evaporative cooling units, aerials, vent pipes and supports for solar collectors shall be sealed. The material used to seal the penetration shall be non-combustible.

(b) Openings in vented roof lights, roof ventilators or vent pipes shall conform with Clause 3.6 and be made of corrosion-resistant steel, bronze or aluminium.

NOTE: A gas appliance designed such that air for combustion dose not enter from, or combustion products enter into, the room which the appliance is located.

In the case of gas appliance flues, ember guards shall not be fitted.

NOTE: AS/NZS 5601 contains requirements for gas appliance flue systems and cowl. Advice can be obtained from manufacturers and State and Territory gas technical regulators.

(c) All overhead glazing shall be Grade A safety glass complying with AS 1288.

(d) Glazed elements in roof lights and skylights may be of polymer, provided a Grade A safety glass diffuser, complying with AS 1288, is installed under the glazing. Where glazing is an insulating glazing unit (IGU), Grade A toughened safety glass of minimum 4 mm in thickness shall be used in the outer pane of the IGU.

(e) Flashing elements of tubular skylights may be of a fire-retardant material, provided the roof integrity is maintained by an under-flashing of a material having a flammability index not exceeding five..

(f) Evaporative cooling units shall be fitted with non-combustible butterfly closers as close as practicable to the roof level, or the unit shall be fitted with non-combustible covers with a mesh or perforated sheet with a maximum aperture of 2mm, made of corrosion-resistant steel, bronze or aluminium.

(g) Vent pipes made from PVC are permitted.

(h) Eaves lighting shall be adequately sealed and not compromise the performance of the element.

5.6.6 EAVES LININGS, FASCIAS AND GABLES

The following apply to eaves linings, fascias and gables:

(a) Gables shall comply with Clause 5.4.

(b) Eaves penetrations shall be protected the same as for roof penetrations, as specified in Clause 5.6.5.

(c) Eaves ventilation openings shall be fitted with ember guards in accordance with Clause 3.6 and made of corrosion-resistant steel, bronze or aluminium

Joints in eaves linings, fascias and gables may be sealed with plastic joining strips or timber storm moulds.

This standard does not provide construction requirements for fascias, bargeboards and eaves linings.

5.6.7 GUTTERS AND DOWNPIPES

This Standard does not provide material requirements for downpipes. If installed, gutter and valley leaf guards shall be non-combustible. With the exception of box gutters, gutters shall be metal or PVC-U. Box gutters shall be non-combustible and flashed at the junction with the roof with noncombustible material.

5.7.1 VERANDAS, DECKS, STEPS

AND LANDINGS - GENERAL

Decking may be spaced.

There is no requirement to enclose the subfloor spaces of verandas, decks, steps, ramps or landings.

C5.7.7 - Spaced decking is nominally spaced at 3 mm (in accordance with standard industry practice); however, due to the nature of timber decking with seasonal changes in moisture content, that spacing may range from 0 - 5 mm during service. It should be noted that recent research studies have shown that gaps at 5 mm spacing afford opportunity for embers to become lodged in between timbers, which may contribute to a fire. Larger gap spacings of 10 mm may preclude this from happening but such a spacing regime may not be practical for a timber deck.

5.7.2 ENCLOSED SUBFLOOR SPACES OF VERANDAS,

DECKS, STEPS, RAMPS AND LANDINGS

5.7.2.1 Materials to enclose a subfloor space

This standard does not provide construction requirements for the materials used to enclose a subfloor space except where those materials are less than 400mm from the ground. Where the materials used to enclose a subfloor space are less than 400mm from the ground, they shall conform with Clause 5.4.

5.7.2.2 Supports

This Standard does not provide construction requirements for support posts, columns, stumps, stringers, piers and poles.

5.7.2.3 Framing

This Standard does not provide construction requirements for the framing of verandas, decks, ramps or landings (i.e., bearers and joists).

5.7.2.4 Decking, stair treads and the trafficable surfaces of ramps and landings

This standard does not provide construction requirements for decking, stair treds and the trafficable surfaces and landings that are more than 300mm from a glazed element.

Decking, stair treads and the trafficable surfaces of ramps and landings less than 300mm (measured horizontally at deck level) from glazed elements that are less than 400mm (measured vertically) from the surface of the deck (see Figure D2, Appendix D) shall be made from -

- (a) of non-combustible material; OR
- (b) of bushfire-resisting timber (see Appendix F); OR
- (c) a timber species as specified in Paragraph E1, Appendix E; or
- (d) uPVC; or
- (e) a combination of Items (a), (b), (c) or (d).

5.7.3 UNENCLOSED SUBFLOOR SPACES OF VERANDAS,

DECKS, STEPS, RAMPS AND LANDINGS

5.7.3.1 Supports

This Standard does not provide construction requirements for support posts, columns, stumps, stringers, piers and poles.

5.7.3.2 Framing

This Standard does not provide construction requirements for the framing of verandas, decks, ramps or landings (i.e., bearers and joists).

5.7.3.3 Decking, stair treads and the trafficable surfaces of ramps and landings

This Standard does not provide construction requirements for deshing, stair treds and the trafficable surfaces of ramps and landings that are more than 300mm from a glazed element.

Decking, stair treads and the trafficable surfaces of ramps and landings less than 300mm (measured horizontally at deck level) from glazed elements that are less than 400mm (measured vertically) from the surface of the deck (see Figure D2, Appendix D) shall be made from-

- (a) of non-combustible material; OR
- (b) of bushfire-resisting timber (see Appendix F); OR
- (c) a timber species as specified in Paragraph E1, Appendix E; or
- (d) uPVC; or
- (e) a combination of any of Items (a), (b), (c) or (d).

5.7.4 BALUSTRADES, HANDRAILS OR OTHER BARRIERS

This Standard does not provide construction requirements for balustrades, handrails and other barriers.

5.7.5 VERANDA POSTS

Verandah Posts -

(a) Shall be timber mounted on galvanised mounted shoes or stirrups with a clearance of no less than 75mm above adjacent ground level; or

(b) If less than 400mm (measured vertically) from the surface of the deck or ground (see Fig D2, Appendix D) shall be made from -

- (i) non-combustible material;or
- (ii) bushfire-resisting timber (see Appendix F); or
- (iii) a timbers species as specified in Paragraph E1, Appendix E; or
- (iv) a combination of any of items (a) or (b).

5.8 WATER AND GAS SUPPLY PIPES

Above-ground, exposed water and gas supply pipes shall be metal.

SUBJECT TO NCC 2022

(1 MAY 2023)

WATERPROOFING & PLUMBING

PLAN ACCEPTANCE BY OWNER


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BAL-12.5 BUSHFIRE REQUIREMENTS
SEE SHEET 1 (COVER SHEET) FOR DETAILS

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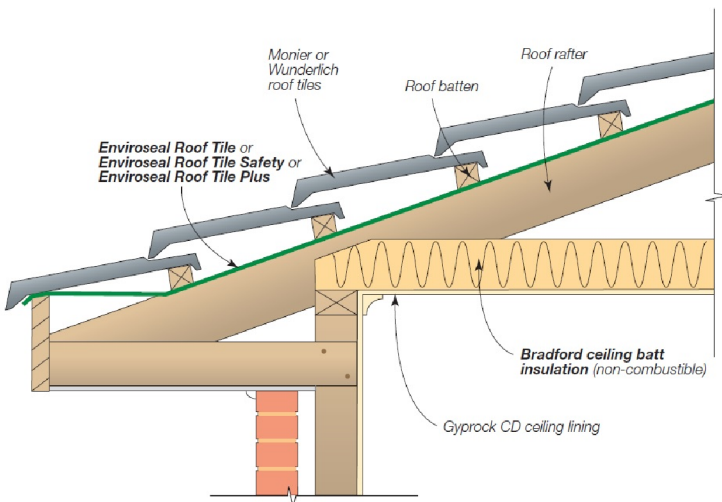
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Rafter Spacing	Product
Up to and including 600mm	EnviroSeal™ Roof Tile or EnviroSeal™ Roof Tile Plus
Over 600mm	EnviroSeal™ Roof Tile Safety

Figure 5.1. Tiled Roofs

- Install EnviroSeal roof tile sarking on top of the roof framing and below the roof battens.
- For further fixing details contact CSR technical support.



Application	Product
Sarking	EnviroSeal™ Resiwrap
Foil faced insulation blanket	Bradford Anticon™
Gap seal	Bradford Fireseal BAL 12.5 - 40 Blanket

Figure 5.2.1. Fascia Detail – Metal Roof (BAL12.5-40)

- Install EnviroSeal Resiwrap to the entire roof area over the top of the battens.
- Immediately above the fascia install BAL12.5 – 40 Blanket extending up the roof and over the first batten. Compress with the roof sheeting.
- For further fixing details contact CSR technical support.

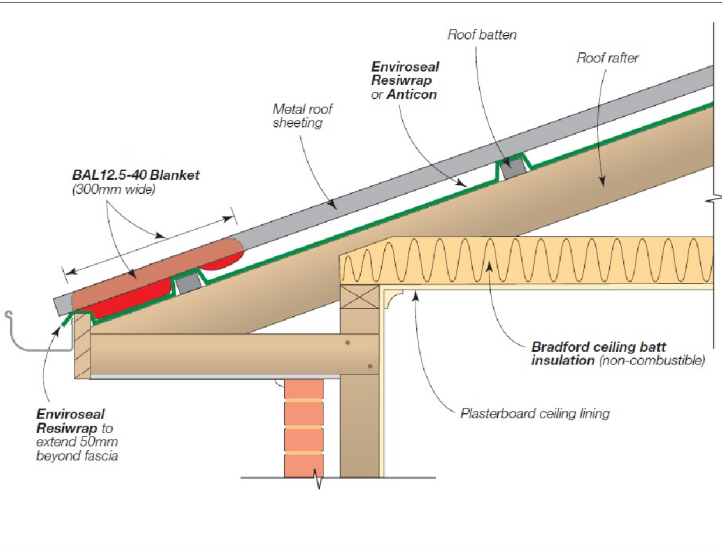


Figure 5.2.2. Valley Detail – Steel Roof (BAL-12.5 – BAL-40)

- Install EnviroSeal Resiwrap to the entire roof area over the top of the battens.
- BAL12.5 – 40 Blanket to be laid over the top of the sarking extending into the valley gutter. Compress with roof sheeting.
- For further fixing details contact CSR technical support.

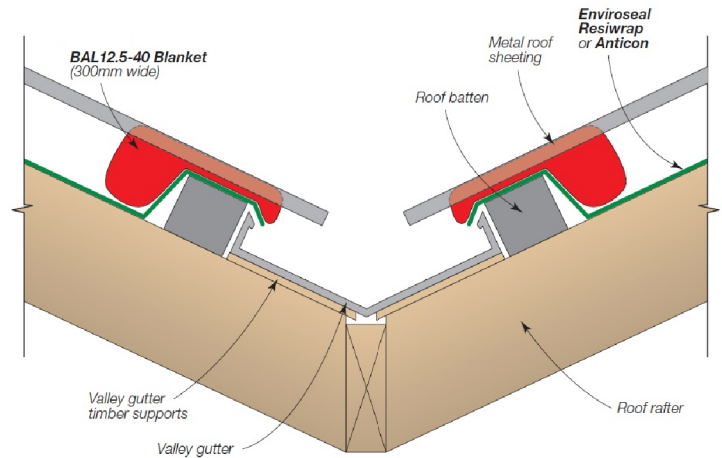


Figure 5.2.3. Barge Detail – Steel Roof (BAL-12.5 – BAL-40)

- Install EnviroSeal Resiwrap to the entire roof area over the top of the battens.
- At barge install BAL12.5 – 40 Blanket and compress with roof sheeting.
- For further fixing details contact CSR technical support.


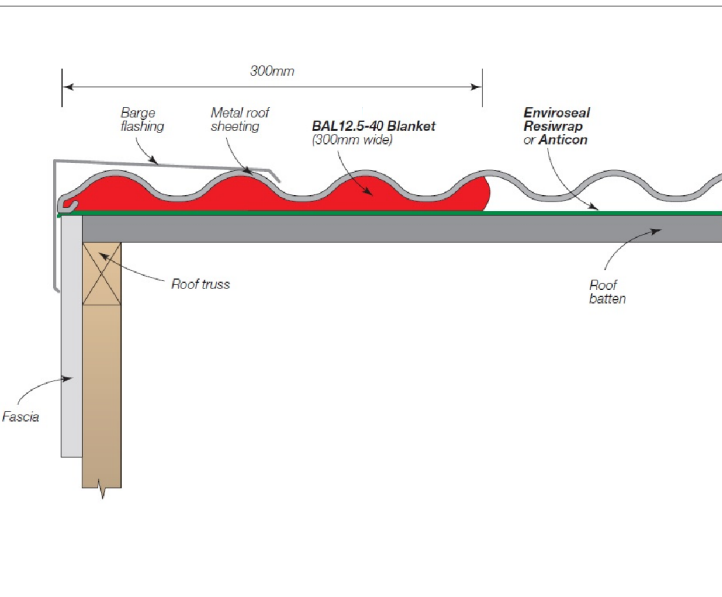


Figure 5.2.4. Hip/Ridge Detail – Steel Roof (BAL-12.5 – BAL-40)

- Install EnviroSeal Resiwrap to the entire roof area over the top of the battens.
- At the ridge/hip lay BAL12.5 – 40 Blanket over the gap between the roof sheets and compress with the ridge capping to the roof profile.
- For further fixing details contact CSR technical support.

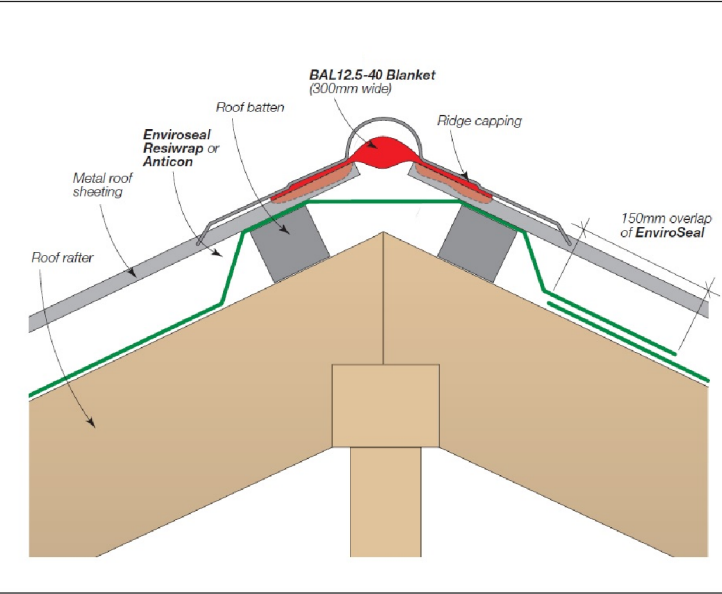

Details for the purpose of bushfire proofing only. To be printed in colour.

Images sourced from Bradfords "Bushfire Roofing System", Published 04/11.

BAL-12.5 BUSHFIRE REQUIREMENTS
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